
CITY OF EAST PALO ALTO, CALIFORNIA DEPARTMENT OF PUBLIC WORKS ENGINEERING DIVISION

60% CHECKPRINT CONSTRUCTION PLANS FOR THE ANNUAL STREET RESURFACING PROJECT 2024–2025 CIP PROJECT NO. ST-07-25

PROJECT LOCATION MAP

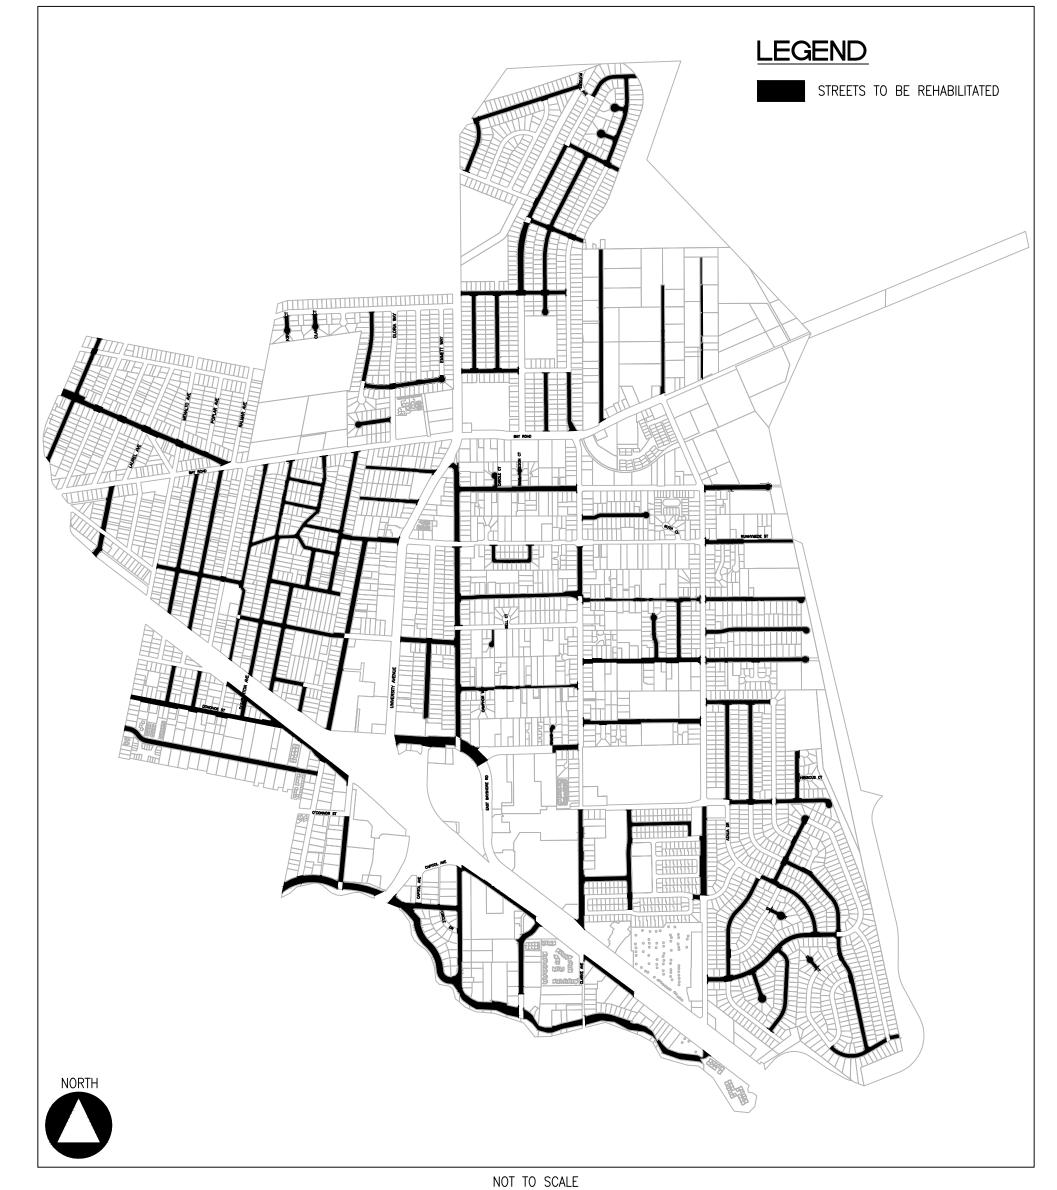

Г	STRE		
STREET NAME	BEGINNING	END	TREATMENT
EUCLID AVENUE	RUNNYMEDE STREET	BELL STREET	SLURRY SEAL W/ CRACK SEALING
GATES STREET	TATE STREET	WILKS STREET	SLURRY SEAL W/ CRACK SEALING
ILLINOIS STREET	FORDHAM STREET	STEVENS AVENUE	SLURRY SEAL W/ CRACK SEALING
ILLINOIS STREET	MICHIGAN AVENUE	BAY ROAD	SLURRY SEAL W/ CRACK SEALING
LINCOLN STREET	OAKDALE ROAD	GARDEN STREET	SLURRY SEAL W/ CRACK SEALING
O'CONNOR STREET	AZALIA DRIVE	LARKSPUR DRIVE	SLURRY SEAL W/ CRACK SEALING
RUNNYMEDE STREET	COOLEY AVENUE	COOLEY AVENUE	SLURRY SEAL W/ CRACK SEALING
DUMBARTON AVENUE	BAY ROAD	PALO VERDE AVENUE	SLURRY SEAL W/ CRACK SEALING
LINCOLN STREET	OAKDALE ROAD	GARDEN STREET	SLURRY SEAL W/ CRACK SEALING
NEWBRIDGE STREET	RALMAR AVENUE	SARATOGA AVENUE	SLURRY SEAL W/ CRACK SEALING
PAUL ROBESON STREET	WEEKS STREET	END	SLURRY SEAL W/ CRACK SEALING
WEST BAYSHORE ROAD	OAKWOOD STREET	MANHATTAN AVENUE	SLURRY SEAL W/ CRACK SEALING
AVELAR STREET	RUNNYMEDE STREET	RUNNYMEDE STREET	SLURRY SEAL
AZALIA DRIVE	SAGE STREET	O'CONNOR STREET	SLURRY SEAL
BELL STREET	OAKWOOD DRIVE	EUCLID AVENUE	SLURRY SEAL
CAROLE COURT	WEEKS STREET	CUL DE SAC	SLURRY SEAL
COOLEY AVENUE	UNIVERSITY AVENUE	RUNNYMEDE STREET	SLURRY SEAL
DAPHNE WAY	ASTER WAY	END	SLURRY SEAL
DONOHOE STREET	EAST BAYSHORE ROAD	COOLEY AVENUE	SLURRY SEAL
DUMBARTON AVENUE	WEST BAYSHORE ROAD	DONOHOE STREET	SLURRY SEAL
EUCLID AVENUE	O'CONNOR STREET	WOODLAND AVENUE	SLURRY SEAL
LARKSPUR DRIVE	SAGE STREET	GARDENIA WAY	SLURRY SEAL
MANHATTAN AVENUE	WEST BAYSHORE ROAD	O'CONNOR STREET	SLURRY SEAL
NEWBRIDGE STREET	SARATOGA AVENUE	CITY LIMIT	SLURRY SEAL
PALO VERDE AVENUE	BAY ROAD	OAKWOOD DRIVE	SLURRY SEAL
RALMAR STREET	GARDEN STREET	EAST BAYSHORE ROAD	SLURRY SEAL
SACRAMENTO STREET	UNIVERSITY AVENUE	END	SLURRY SEAL
SAGE STREET	PULGAS AVENUE	LARKSPUR DRIVE	SLURRY SEAL
SCHEMBRI LANE	COOLEY AVENUE	CLARKE AVENUE	SLURRY SEAL
STEVENS AVENUE	FORDHAM STREET	END	SLURRY SEAL
VERBENA DRIVE	AZALIA DRIVE	CAMELLIA DRIVE	SLURRY SEAL
WEEKS STREET	UNIVERSITY AVENUE	END	SLURRY SEAL
WEST BAYSHORE ROAD	COOLEY AVENUE	NEWELL ROAD	SLURRY SEAL
WEST BAYSHORE ROAD	CLARKE AVENUE	1838 W. BAYSHORE ROAD	SLURRY SEAL
WISTERIA DRIVE	CAMELLIA DRIVE	DAPHNE WAY	SLURRY SEAL
WISTERIA DRIVE	SAGE STREET	O'CONNOR STREET	SLURRY SEAL
WOODLAND AVENUE	EUCLID AVENUE	MANHATTAN AVENUE	SLURRY SEAL
WOODLAND AVENUE	COOLEY AVENUE	NEWELL ROAD	SLURRY SEAL
WOODLAND AVENUE	CLARKE AVENUE	WEST BAYSHORE ROAD	SLURRY SEAL
WOODLAND AVENUE	UNIVERSITY AVENUE	COOLEY AVENUE	SLURRY SEAL
CAPITOL AVENUE	BELL STREET	DONOHOE STREET	THIN OVERLAY
GRACE AVENUE	GLORIA WAY	END	THIN OVERLAY
	LINCOLN STREET	GLEN WAY	THIN OVERLAY
GREEN STREET			
	LARKSPUR DRIVE	END	THIN OVERLAY
GREEN STREET O'CONNOR STREET WEEKS STREET		END END	THIN OVERLAY THIN OVERLAY

TREET NAME	BEGINNING	END	TREATMENT
BELL STREET	UNIVERSITY AVENUE	COOLEY AVENUE	MILL & THIN OVERLAY
DAPHNE COURT	DAPHNE WAY	END	MILL & THIN OVERLAY
GREEN STREET	OAKWOOD DRIVE	CITY LIMIT	MILL & THIN OVERLAY
MYRTLE STREET	CLARKE AVENUE	PULGAS AVENUE	MILL & THIN OVERLAY
BEECH STREET	PULGAS AVENUE	END	MILL & THICK OVERLAY
CAMELLIA COURT	CAMELLIA DRIVE	END	MILL & THICK OVERLAY
CLARENCE COURT	KAVANAUGH WAY	END	MILL & THICK OVERLAY
CLARKE AVENUE	RUNNYMEDE STREET	GARDEN STREET	MILL & THICK OVERLAY
COOLEY AVENUE	BELL STREET	DONOHOE STREET	MILL & THICK OVERLAY
COOLEY AVENUE	RUNNYMEDE STREET	BELL STREET	MILL & THICK OVERLAY
DUMBARTON AVENUE	PALO VERDE AVENUE	BELL STREET	MILL & THICK OVERLAY
EAST O'KEEFE STREET	EUCLID AVENUE	CITY LIMIT	MILL & THICK OVERLAY
FORDHAM STREET	RUTGERS STREET	END	MILL & THICK OVERLAY
GARDEN STREET	CLARKE AVENUE	PULGAS AVENUE	MILL & THICK OVERLAY
GONZAGA STREET	NOTRE DAME	END	MILL & THICK OVERLAY
HAZELWOOD WAY	KAVANAUGH DRIVE	URSULA WAY	MILL & THICK OVERLAY
KIRKWOOD COURT	KAVANAUGH DRIVE	END	MILL & THICK OVERLAY
LAUREL AVENUE	HOLLAND STREET	EAST BAYSHORE ROAD	MILL & THICK OVERLAY
LINCOLN STREET	GARDEN STREET	EAST BAYSHORE ROAD	MILL & THICK OVERLAY
MICHIGAN AVENUE	UNIVERSITY AVENUE	FORDHAM STREET	MILL & THICK OVERLAY
NEWELL ROAD	WOODLAND AVENUE	WEST BAYSHORE ROAD	MILL & THICK OVERLAY
OAKDALE ROAD	PALO VERDE AVENUE	LINCOLN AVENUE	MILL & THICK OVERLAY
OAKES STREET	PULGAS AVENUE	BAINES STREET	MILL & THICK OVERLAY
POPLAR AVENUE	BAY ROAD	GARDEWN STREET	MILL & THICK OVERLAY
PURDUE AVENUE	FORDHAM STREET	END	MILL & THICK OVERLAY
SALAS COURT	DONOHOE STREET	END	MILL & THICK OVERLAY
SCOFIELD STREET	WOODLAND AVENUE	COOLEY AVENUE	MILL & THICK OVERLAY
TATE STREET	O'CONNOR STREET	BAINES STREET	MILL & THICK OVERLAY
TERRA-VILLA AVENUE	GARDEN STREET	BEECH STREET	MILL & THICK OVERLAY
TINSLEY STREET	TATE STREET	CLARKE AVENUE	MILL & THICK OVERLAY
URSULA WAY	HAZELWOOD WAY	EMMETT WAY	MILL & THICK OVERLAY
WISTERIA DRIVE	GARDENIA WAY	CAMELLIA DRIVE	MILL & THICK OVERLAY
WOODLAND AVENUE	CLARKE AVENUE	WEST BAYSHORE ROAD	MILL & THICK OVERLAY
SARATOGA AVENUE	EAST BAYSHORE ROAD	CITY LIMIT	MILL & THICK OVERLAY
SCOFIELD STREET	WOODLAND AVENUE	COOLEY AVENUE	MILL & THICK OVERLAY
DONOHOE STREET	UNIVERSITY AVENUE	COOLEY AVENUE	MILL & THIN OVERLAY W/ FABRIC
DONOHOE STREET	CLARKE AVENUE	SALAS COURT	MILL & THIN OVERLAY W/ FABRIC
MANHATTAN AVENUE	O'CONNOR STREET	WOODLAND AVENUE	MILL & THIN OVERLAY W/ FABRIC
EUCLID AVENUE	BELL STREET	DONOHOE STREET	MILL & THICK OVERLAY W/ FABRIC
PULGAS AVENUE	O'CONNOR STREET	GAILLARDIA WAY	MILL & THICK OVERLAY W/ FABRIC
COOLEY AVENUE	WEST BAYSHORE ROAD	WOODLAND AVENUE	MULTI-LAYER TREATMENT
DONOHOE STREET	WEST BAYSHORE ROAD	CITY LIMIT	MULTI-LAYER TREATMENT
FORDHAM STREET	STEVENS AVENUE	PURDUE AVENUE	MULTI-LAYER TREATMENT
GONZAGA STREET	STEVENS AVENUE	PURDUE AVENUE	MULTI-LAYER TREATMENT
RUNNYMEDE STREET	PULGAS AVENUE	END	MULTI-LAYER TREATMENT
WOODLAND AVENUE	MANHATTAN AVENUE	UNIVERSITY AVENUE	MULTI-LAYER TREATMENT

PREPARED BY PROJECT LOCATION MAP AND STREETS LIST CITY OF EAST PALO ALTO BESIGNED/DRAFTED BY CITY OF EAST PALO ALTO BESIGNED/DRAFTED BY BESIGNED BY BESIG	DESCRIPTION OF REVISION DATE						
PROJECT LOCATION MAP AND STREETS LIST CITY OF EAST PALO ALTO DEPARTMENT OF PUBLIC WORKS FROJECT 2024-2025 PROJECT LOCATION MAP AND CITY OF EAST PALO ALTO DEPARTMENT OF PUBLIC WORKS FOUNDLY STREET RESURFACING FOR THE PROJECT 2024-2025 FINAL PROJECT 2024-2025	NO.						
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- 2. THE ENGINEER ASSUMES NO RESPONSIBILITY BEYOND THE ADEQUACY OF THE DESIGN CONTAINED HEREIN
- 3. THE CONTRACTOR SHALL COMPLY WITH THE RULES AND REGULATIONS OF THE CAL/OSHA STATE OF CALIFORNIA CONSTRUCTION SAFETY ORDERS.
- 4. SHOULD IT APPEAR THAT THE WORK TO BE DONE, OR ANY MATTER RELATIVE THERETO, IS NOT SUFFICIENTLY DETAILED OR EXPLAINED ON THESE PLANS THE CONTRACTOR SHALL CONTACT THE PROJECT ENGINEER FOR SUCH FURTHER EXPLANATIONS AS BE NECESSARY.
- 5. ALL WORK SHALL BE PERFORMED IN CONFORMANCE WITH THE PROJECT SPECIFICATIONS, SPECIAL PROVISIONS, SAN MATEO COUNTY STANDARD PLANS, AND REQUIREMENTS SET FORTH IN THE COUNTY OF SAN MATEO'S ENGINEERING STANDARDS.
- 6. THE CONTRACTOR SHALL SUBMIT TO THE CITY AND HAVE IN THE SUPERINTENDENT'S VEHICLE, EMERGENCY TELEPHONE NUMBERS FOR POLICE, FIRE, AMBULANCE, AND THOSE AGENCIES RESPONSIBLE FOR MAINTENANCE OF UTILITIES IN THE VICINITY OF THE JOBSITE.
- 7. EMERGENCY PHONE NUMBERS TO REACH CONTRACTOR SHALL BE PROVIDED TO THE CITY OF EAST PALO ALTO DEPARTMENT OF PUBLIC WORKS.
- 8. THE CONTRACTOR SHALL PROVIDE ALL LIGHTS, SIGNS, BARRICADES, FLAGGERS, OR OTHER DEVICES NECESSARY TO PROVIDE FOR PUBLIC SAFETY.
- 9. EXCAVATIONS SHALL BE ADEQUATELY SHORES, BRACED, AND SHEETED SO THAT THE EARTH WILL NOT SLIDE OR SETTLE AND SO THAT ALL EXISTING IMPROVEMENTS OF ANY KIND WILL BE FULLY PROTECTED FROM DAMAGE. ANY DAMAGE RESULTING FROM A LACK OF ADEQUATE SHORING, BRACING, AND SHEETING SHALL BE THE RESPONSIBILITY OF THE CONTRACTOR AND THEY SHALL AFFECT NECESSARY REPAIRS OR RECONSTRUCTION AT THEIR OWN EDPENSE. WHERE THE EXCAVATION FOR A CONDUIT TRENCH AND/OR STRUCTURE IS FIVE FEET OR MORE IN DEPTH, THE CONTRACTOR SHALL PROVIDE ADEQUATE SHEETING, SHORING, AND BRACING OR EQUIVALENT METHOD FOR THE PROTECTION OF LIFE OR LIMB, CONFORMING TO THE APPLICABLE CONSTRUCTION SAFETY ORDERS OF THE DIVISION OF INDUSTRIAL SAFETY OF THE STATE OF CALIFORNIA. THE CONTRACTOR SHALL ALWAYS COMPLY WITH OSHA REQUIREMENTS.
- 10. NO WORK SHALL BE DONE ON THIS PROJECT PRIOR TO A PRE-CONSTRUCTION CONFERENCE TO BE HELD WITH THE CITY ENGINEER.
- 11. THE CONTRACTOR SHALL CONFINE THEIR OPERATIONS AND ACTIVITIES TO WITHIN THE PROJECT LIMITS, CONSISTING OF ROAD RIGHT-OF-WAY, RIGHTS OF ENTRY, AND/OR PROJECT CONFORMS, AS SHOWN ON THE PLANS AND AS DIRECTED BY THE ENGINEER.
- 12. THE CONTRACTOR SHALL INFORM THE CITY ENGINEER 48 HOURS IN ADVANCE OF THE TIME THEY REQUIRE AN INSPECTOR, INCLUDING FORM WORK REVIEW AND APPROVAL.
- 13. THE FOLLOWING CONTROL MEASURES FOR GRADING AND CONSTRUCTION ACTIVITIES SHALL BE ADHERED TO, UNLESS OTHERWISE APPROVED BY THE CITY:
- A. GRADING AND CONSTRUCTION ACTIVITIES SHALL BE LIMITED TO THE HOURS OF 8:00 AM UNTIL 5:00 PM ON WEEKDAYS. THERE SHALL BE NO GRADING OR CONSTRUCTION ACTIVITIES ON THE WEEKENDS OR ON CITY HOLIDAYS.
- B. GRADING AND CONSTRUCTION EQUIPMENT SHALL BE PROPERLY MUFFLED.
- C. UNNECESSARY IDLING OF GRADING AND CONSTRUCTION EQUIPMENT IS PROHIBITED.
- D. NOISE-GENERATING STATIONARY CONSTRUCTION EQUIPMENT, SUCH AS COMPRESSORS, SHALL BE LOCATED AS FAR AS PRACTICAL FROM OCCUPIED RESIDENTIAL HOMES.
- E. CONSTRUCTION TRASH AND DEBRIS SHALL BE CLEANED UP DAILY.
- F. ALL UNPAVED ACCESS ROADS, PARKING AREAS, AND CONSTRUCTION STAGING AREAS SHALL BE WATERED OR TREATED WITH NON-TOXIC SOIL STABILIZERS AS NECESSARY TO PREVENT AIRBORNE DUST.
- G. CONSTRUCTION SITES SHALL BE KEPT CLEAN AT ALL TIMES. AT NO TIME SHALL THE CONTRACTOR OR PERMIT HOLDER BE ALLOWED TO LEAVE THE SITE PRIOR TO THOROUGHLY CLEANING SIDEWALKS, CURBS, GUTTERS, AND STREET SURFACES.
- H. ADJACENT STREETS AND APPROVED HAUL ROUTES SHALL BE SWEPT DAILY BY MECHANICAL SWEEPERS EQUIPPED WITH VACUUM UNITS AND THOROUGHLY FLUSHED AFTER SWEEPING IS COMPLETED.
- I. CONSTRUCTION ACCESS ROUTES SHALL BE APPROVED IN ADVANCE BY THE CITY OF EAST PALO ALTO.
- 14. THE CONTRACTOR SHALL COORDINATE DIRECTLY WITH ALL UTILITY COMPANIES WHEN PERFORMING ANY EXCAVATION TO ENSURE UTILITY MAINS AND SERVICE LATERALS MAINTAIN ADEQUATE COVER.
- 15. PRIOR TO CONSTRUCTION, THE CONTRACTOR SHALL PREPARE A DUST CONTROL PLAN FOR SUBMITTAL TO THE COMMUNITY DEVELOPMENT DEPARTMENT. THE DUST CONTROL PLAN SHALL INCLUDE A SCHEDULE FOR WATERING AREAS OF EXPOSED SURFACES DURING THE CONSTRUCTION AND GRADING PROCESS (EARLY MORNING AND EARLY EVENING). OVERFILLING OF WATER TRUCKS WILL NOT BE ALLOWED.
- 16. THE CONTRACTOR SHALL BE RESPONSIBLE FOR ANY DAMAGE TO THE SITE OR SURROUNDING AREA DUE TO DUST OR EROSION RESULTING FROM WORK DONE BY THE CONTRACTOR. THE CONTRACTOR SHALL PROVIDE A SEVEN—DAY PHONE NUMBER TO RECEIVE AND RESPOND TO DUST COMPLAINTS RESULTING FROM ALL CONSTRUCTION OPERATIONS AND SHALL BE MAINTAINED UNTIL CONSTRUCTION IS COMPLETE.
- 17. THE CONTRACTOR SHALL PROVIDE A TRAFFIC CONTROL PLAN FOR REVIEW TO THE COMMUNITY DEVELOPMENT DEPARTMENT PRIOR TO CONSTRUCTION.
- 18. EXISTING UNDERGROUND UTILITIES AND IMPROVEMENTS ARE APPROXIMATE LOCATIONS BASED UPON RECORD INFORMATION AVAILABLE TO THE ENGINEER AT THE TIME OF PREPARATION OF THESE PLANS. IT IS THE CONTRACTOR'S RESPONSIBILITY TO VERIFY THE LOCATION AND DEPTH OF ANY EXISTING UNDERGROUND UTILITIES AND IMPROVEMENT WITH APPROPRIATE AGENCIES PRIOR TO THE START OF CONSTRUCTION IN THAT VICINITY. ANY CONFRLICTS SHALL BE REPORTED IMMEDIATELY TO THE CITY AND TO THE ENGINEER. NEITHER THE CITY NOR THE ENGINEER ASSUMES RESPONSIBILITY THAT THE OBSTRUCTIONS INDICATED ON THE PLANS WILL BE THE OBSTRUCTIONS ENCOUNTERED. THE CONTRACTOR SHALL NOTIFY UNDERGROUND SERVICE ALERT 811 TWO WORKING DAYS PRIOR TO THE START OF CONSTRUCTION.
- 19. AT THE TIME OF CONSTRUCTION, ALL EXISTING MONUMENTATION, INCLUDING PROJECT SURVEY CONTROL POINTS, SHALL BE PRESERVED. IF MONUMENTS BECOME DAMAGED DURING CONSTRUCTION, THEY SHALL BE RESTORED AT THE CONTRACTOR'S EXPENSE.
- 20. THE CONTRACTOR SHALL IMMEDIATELY REPORT ANY SOIL OR WATER CONTAMINATION NOTICED DURING CONSTRUCTION TO THE CITY OF EAST PALO ALTO FIRE DEPARTMENT HAZARDOUS MATERIALS DIVISION, THE SAN MATEO COUNTY DEPARTMENT OF HEALTH, AND THE CALIFORNIA REGIONAL WATER QUALITY CONTROL BOARD.

- 21. ALL EXCAVATIONS SHALL BE BACKFILLED AND COMPACTED AT DAY'S END. A MINIMUM OF TWO INCHES OF TEMPORARY PAVING SHALL BE INSTALLED AND COMPACTED BY MECHANICAL MEANS TO PRODUCE A SMOOTH SURFACE FOR PEDESTRIAN AND VEHICULAR TRAFFIC.
- 22. IT IS THE RESPONSIBILITY OF THE CONTRACTOR TO RESTORE STREET AND SIDEWALK SUBGRADES DISTURBED DURING UNDERGROUND CONSTRUCTION. ALL EXISTING STREET IMPROVEMENTS DAMAGED DURING CONSTRUCTION SHALL BE REPAIRED TO THE SATISFACTION OF THE CITY ENGINEER.
- 23. ALL EXISTING UTILITIES AND IMPROVEMENTS THAT BECOME DAMAGED DURING CONSTRUCTION SHALL BE COMPLETELY RESTORED TO THE SATISFACTION OF THE CITY ENGINEER AND THE UTILITY OWNER. AT THE SOLE EXPENSE OF THE CONTRACTOR.
- 24. THE CONTRACTOR SHALL NOT STOCKPILE DEBRIS ONSITE UNLESS APPROVED IN ADVANCE BY THE ENGINEER IN WRITING.

CONSTRUCTION NOTES

- 1. STATIONING HEREON IS ALONG STREET CENTERLINE UNLESS OTHERWISE SHOWN OR INDICATED.
- 2. ALL CURB, GUTTER, SIDEWALK, AND PAVEMENT TO BE REMOVED SHALL BE SAWCUT AT THE CONFORM LIMITS.
- 3. EXACT LIMITS OF AC PATCHING (DIG-OUT REPAIR) WILL BE MARKED IN THE FIELD BY THE CITY ENGINEER.
- 4. THE CONTRACTOR SHALL BE RESPONSIBLE FOR MATCHING STREETS, SURROUNDING LANDSCAPE & OTHER IMPROVEMENTS WITH A SMOOTH TRANSITION IN PAVING, CURBS, GUTTERS, SIDEWALKS, OR GRADING TO AVOID ANY ABRUPT OR APPARENT CHANGES IN GRADES OR CROSS SLOPE, LOW SPOTS, OR HAZARDOUS CONDITIONS. PAVING CONFORMS SHALL BE MADE AT A SMOOTHLY TRIMMED BUTT JOINT. DO NOT OVERLAP EXISTING PAVEMENT.
- 5. PAVEMENT STRIPING AND MARKING SHALL BE RESTORED AND REPLACED AFTER APPLYING SURFACE TREATMENT TO EXISTING PAVEMENT. ALL PAVEMENT MARKINGS AND STRIPES SHALL BE THERMOPLASTIC UNLESS NOTED OTHERWISE.
- 6. ALL STRIPING SHALL BE CAT-TRACKED BY THE CONTRACTOR AND APPROVED BY THE CITY ENGINEER PRIOR TO FINAL INSTALLATION. A MINIMUM OF 48 HOURS NOTICE IS REQUIRED.
- 7. AT A MINIMUM, THE FOLLOWING SPECIFIED PERCENTAGES OF THE WASTE TONNAGE GENERATED FROM SITE ACTIVITIES SHALL BE DIVERTED FROM GOING INTO A LANDFILL THROUGH USE OF RECYCLING, REUSE, AND DIVERSION PROGRAMS:

<u>DEMOLITION</u>: 60% OF WASTE TONNAGE INCLUDING CONCRETE AND ASPHALT, AND 25% OF WASTE TONNAGE EXCLUDING CONCRETE AND ASPHALT

CONSTRUCTION: 55% OF WASTE TONNAGE INCLUDING CONCRETE AND ASPHALT, AND 20% OF WASTE TONNAGE EXCLUDING CONCRETE AND ASPHALT

DEMOLITION DIVERSIONS AND CONSTRUCTION DIVERSIONS SHALL BE CALCULATED SEPARATELY.

EROSION CONTROL NOTES

- 1. CONTRACTOR SHALL EMPLOY BEST MANAGEMENT PRACTICES (BMP'S) IN ACCORDANCE WITH THE LATEST EDITION OF THE STATE OF CALIFORNIA CONSTRUCTION SITE BMP MANUAL AND THE SAN MATEO STORMWATER POLLUTION PREVENTION PROGRAM (SWPPP).
- 2. ALL CONSTRUCTION ACTIVITIES SHALL MEET THE REQUIREMENTS OF THE CITY OF EAST PALO ALTO NATIONAL POLLUTANT DISCHARGE ELIMINATION SYSTEM (NPDES) PERMIT.
- 3. EROSION CONTROL MEASURES SHALL BE INSTALLED AS NECESSARY TO PREVENT SEDIMENT RUNOFF TO PUBLIC ROADWAYS, DRAINAGE FACILITIES, AND ADJACENT PROPERTIES.
- 4. ALL LOOSE SOIL AND DEBRIS SHALL BE REMOVED FROM THE STREET AREAS UPON STARTING OPERATIONS AND NO LESS OFTEN THAN DAILY THEREAFTER. INSPECTOR MAY REQUIRE MORE FREQUENT CLEANING AS WEATHER CONDITIONS DICTATE.
- 5. EXCEPT AS OTHERWISE DIRECTED BY THE INSPECTOR, ALL EROSION CONTROL DEVICES SHALL BE IN PLACE AT THE END OF EACH WORKING DAY WHEN THE FORECAST OF RAIN PROBABILITY EXCEEDS 40% AND MAINTAINED THROUGHOUT THE YEAR.
- 6. ALL PAVED AREAS WILL BE KEPT CLEAR OF EARTHEN MATERIAL AND DEBRIS. THE SITE WILL BE MAINTAINED SO THAT SEDIMENT-LADEN RUNOFF DOES NOT ENTER THE STORM DRAINAGE SYSTEM.
- 7. ALL STORM DRAIN STRUCTURES AND INLET PIPES SHALL BE PROTECTED FROM INFLOW OR SILT BY GRAVEL BAG SILT BARRIERS OR SIMILAR DEVICE.
- 8. CONTRACTOR SHALL POSSESS THE TOOLS, EQUIPMENT, AND MATERIALS REQUIRED TO PROVIDE EROSION CONTROL MEASURES MADE NECESSARY BY A CONSTRUCTION OPERATION ON THE JOB SITE PRIOR TO BEGINNING THE OPERATION.
- 9. ADJACENT PROPERTIES SHALL BE PROTECTED FROM STORM WATERS, MUD, SILT, ETC. ON A DAILY
- 10. DUST CONTROL SHALL BE MAINTAINED AT ALL TIMES DURING CONSTRUCTION AND UNTIL FINAL COMPLETION. THE CONTRACTOR, WHEN THEIR SUBCONTRACTOR ARE OPERATING EQUIPMENT ON—SITE, SHALL PREVENT THE FORMATION OF ANY AIRBORNE NUISANCE BY WATERING AND/OR TREATING THE SITE OF THE WORK IN SUCH A MANNER THAT WILL CONFINE DUST PARTICLES TO THE IMMEDIATE SURFACE OF THE WORK. ADDITIONAL WATERING SHALL BE PROVIDED ON DRY OR WINDY DAYS. THE CONTRACTOR SHALL BE RESPONSIBLE FOR ANY DAMAGE CAUSED BY DUST FROM THEIR OWN ACTIVITIES OR THEIR SUBCONTRACTOR'S ACTIVITIES IN PERFORMING THE WORK UNDER THIS CONTRACT, AND SHALL BE RESPONSIBLE FOR ANY CITATIONS, FINES, OR CHARGES RESULTING FROM DUST NUISANCE. DUST CONTROL SHALL BE DONE ON A DAILY BASIS.
- 11. CONCRETE WASH AREA SHALL BE CONSTRUCTED IN ACCORDANCE WITH CALIFORNIA STORM WATER BEST MANAGEMENT PRACTICES DETAIL WM-8.
- 12. STORE, HANDLE, AND DISPOSE OF CONSTRUCTION MATERIALS AND WASTES SO AS TO PREVENT THEIR ENTRY TO THE STORM DRAIN SYSTEM. THE CONTRACTOR MUST NOT ALLOW CONCRETE, WASH WATERS, SLURRIES, PAINT, OR OTHER MATERIALS TO ENTER CATCH BASINS OR TO ENTER SITE RUNOFF.
- 13. USE FILTRATION OR OTHER MEASURES TO REMOVE SEDIMENTS FROM DEWATERING EFFLUENT.
- 14. NO CLEANING, FUELING, OR MAINTAINING VEHICLES ON SITE SHALL BE PERMITTED TO ALLOW DELETERIOUS MATERIALS FROM ENTERING CATCH BASINS OR TO ENTER SITE RUNOFF.
- 15. CONTRACTORS AND SUBCONTRACTORS SHALL BE PROPERLY TRAINED AND MADE AWARE OF THE STORM WATER POLLUTION PREVENTION PROGRAM MEASURES. FAILURE TO COMPLY WITH THE APPROVED BMP'S COULD RESULT IN A FINE OF \$1,000 FOR THE FIRST VIOLATION, INCREASING WITH EACH SUBSEQUENT VIOLATION.

EXISTING UTILITY NOTES

- 1. ALL UTILITY STRUCTURE WORK SHALL BE IN ACCORDANCE WITH THE UTILITY DISTRICT OWNER'S STANDARD PLANS AND SPECIFICATIONS.
- 2. NO UTILITY WORK SHALL BE DONE UNTIL AUTHORIZED BY THE UTILITY OWNER. THE CONTRACTOR SHALL NOTIFY THE UTILITY OWNER AT LEAST TWO (2) WORKING DAYS PRIOR TO STARTING ANY WORK.
- 3. ALL UTILITY COVERS, BOXES, AND MANHOLES SHALL BE ADJUSTED TO THE FINISHED GRADE PRIOR TO THE COMPLETION OF THE PROJECT.
- 4. WATER METER COVERS, GAS VALVE COVERS, WATER VALVE COVERS, JOINT UTILITY BOXES, AND SANITARY SEWER CLEANOUT COVERS SHALL BE REPLACED WITH TRAFFIC—RATED FRAMES AND COVERS WHEN FALLING WITHIN A VEHICULAR TRAVEL WAY, INCLUDING ROADWAYS, PARKING AREAS, AND DRIVEWAYS.
- 5. CONTRACTOR SHALL INSTALL CURB ALIGNMENT ADJUSTMENT AROUND EXISTING UTILITY STRUCTURE AT ALL WATER METERS, GAS VALVES, WATER VALVES, SANITARY SEWER CLEANOUTS, AND UTILITY POLES THAT CONFLICT WITH THE PROPOSED CURB ALIGNMENT AS DETERMINED IN THE FIELD. CURB ALIGNMENT ADJUSTMENT SHALL BE REVIEWED AND APPROVED IN THE FIELD BY THE ENGINEER.
- 6. FIRE HYDRANTS SHALL BE ADJUSTED TO FINISH GRADE BY REPLACING THE RISE PIPE SUCH THAT THE HYDRANT HAS THE PROPER EXPOSURE IN ACCORDANCE WITH SAN MATEO COUNTY STANDARD DETAIL W-5. EXISTING HYDRANTS SHALL BE RE-USED.
- 7. FIRE HYDRANTS IN SIDEWALKS SHALL HAVE THEIR BOLLARDS REMOVED.
- 8. ADJUST SANITARY SEWER MANHOLES TO FINISH GRADE BY ADDING OR SUBTRACTING GRADE RINGS. RE-SET EXISTING FRAME AND COVER IN ACCORDANCE WITH SAN MATEO COUNTY STANDARD DETAIL C-1.
- 9. ADJUST STORM DRAIN MANHOLE TO FINISH GRADE BY ADDING OR SUBTRACTING GRADE RINGS. RE-SET EXISTING FRAME AND COVER IN ACCORDANCE WITH SAN MATEO COUNTY STANDARD DETAIL B-10.

<u>UTILITY OWNERS</u>

WATER SUPPLY AMERICAN WATER ENTERPRISES

SANITARY SEWER EAST PALO ALTO SANITARY DISTRICT AND WEST VALLEY SANITARY DISTRICT

STORM DRAIN

CITY OF EAST PALO ALTO

GAS

PACIFIC GAS & ELECTRIC (PG&E)

ELECTRIC

PACIFIC GAS & ELECTRIC (PG&E)

TELEPHONE AMERICAN TELEPHONE & TELEGRAPH COMPANY (AT&T)

CABLE TELEVISION COMCAST

ABBREVIATIONS

AP ANGLE POINT
AC ASPHALT CONCRETE
BEG BEGIN
BOW BACK OF WALK
C&G CONCRETE CURB & GUTTER

CL CHAIN LINK
CONC CONCRETE
DI DRAIN INLET
DWY DRIVEWAY
EX EXISTING
P/L PROPERTY LINE
PVMT PAVEMENT
RECONST RECONSTRUCTION
REL REMOVE

SL SLOPE
SHT SHEET
SM SAN MATEO COUNTY
SW SIDEWALK
TRANS TRANSITION
TOT TOTAL
TYP TYPICAL
UTP UTILITY POLE
WCR WHEELCHAIR RAMP
VG VALLEY GUTTER

VARIES

CITY OF EAST PALO ALTO
DEPARTMENT OF PUBLIC WORKS

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SHEET NUMBER


PROJECT/JOB NUMBER

ST-07-25

OR

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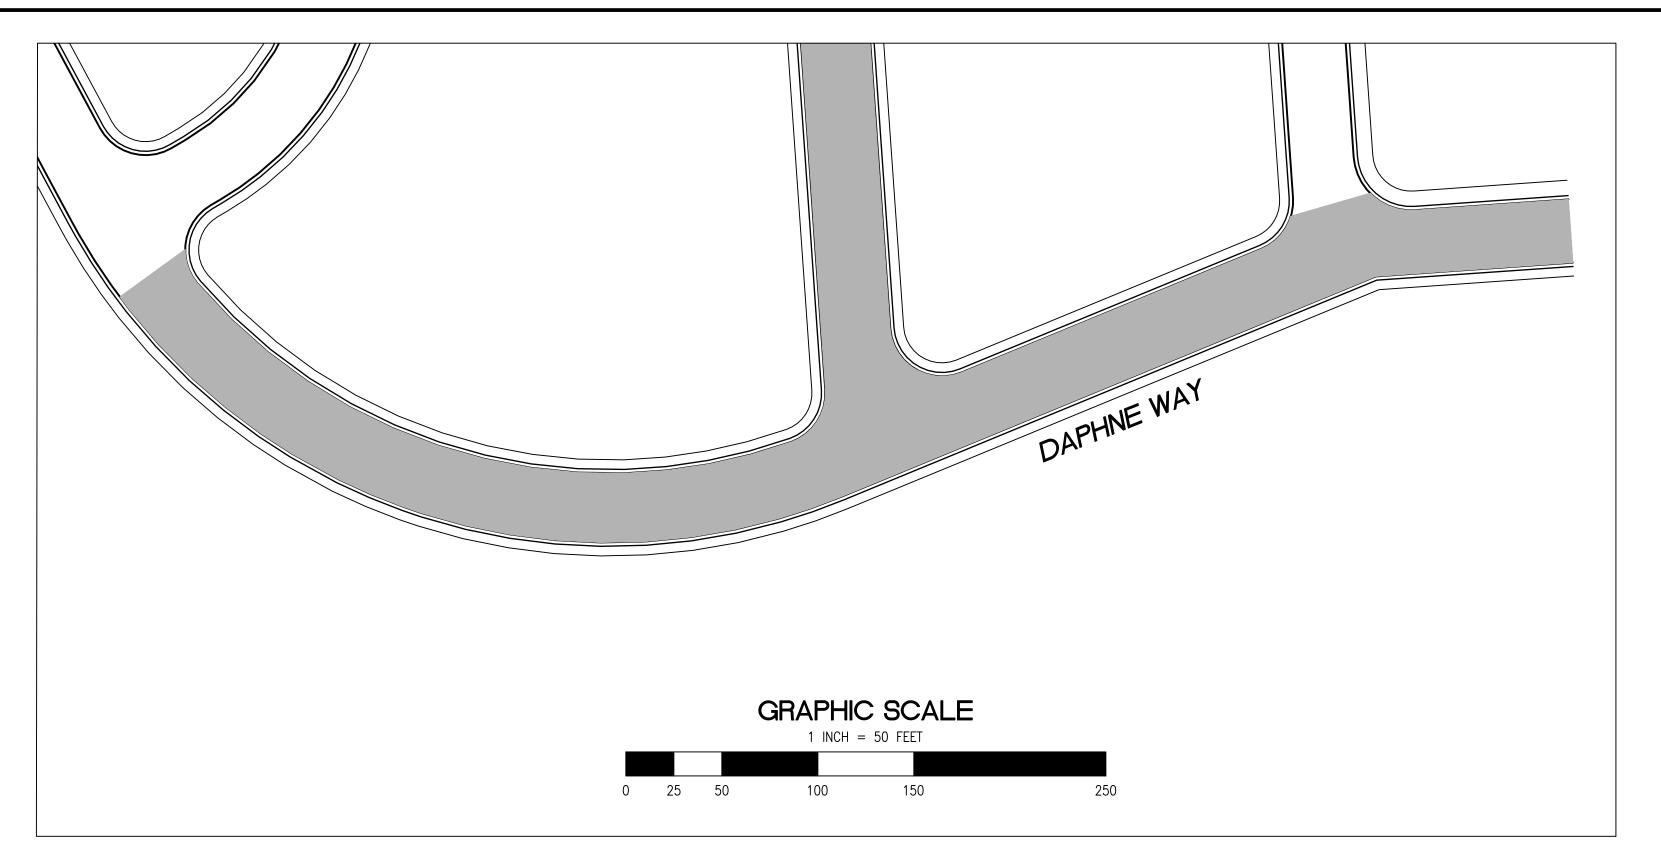
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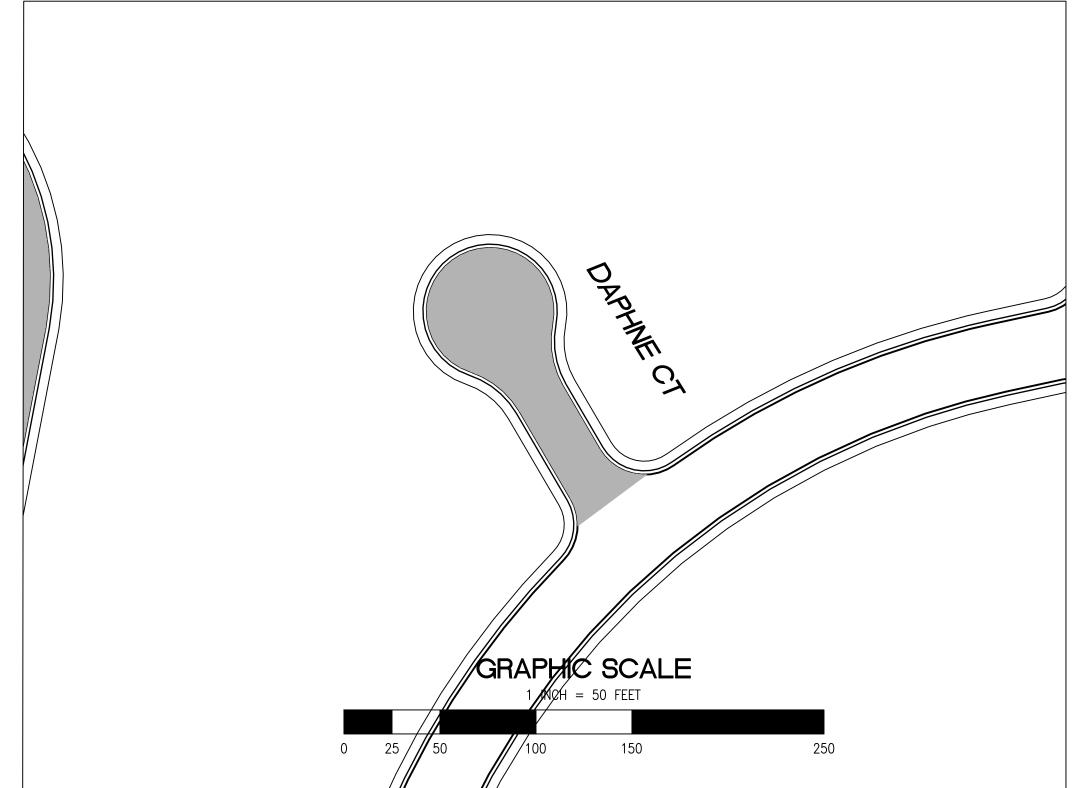



/USERS/MICHAELCORTEZ/LIBRARY/CLOUDSTORAGE/ONEDRIVE-CITYOFEASTPALOALTO/DOCUMENTS/PROJECTS/ST-07-25/CADD - PLAN SET/02_GENERAL NOTES ABBREN PLOTTED ON 6/20/2012 BY MICHAEL CORTEZ

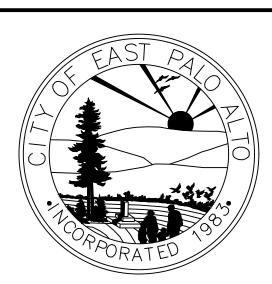/USEKS/MICHAELCORIEZ/LIBRARY/CLOUDSIORAGE/ONEDRIVE—CITYOFEASIPALOALIO/DOCUMENTS/PROJECTS/ST—07—25/CADD — PLAN SET/04.1_CIVIL IMPROVEMENT PLANS_GAR PLOTTED ON 5/28/2024 8:47:15 AM BY MICHAELCORTEZ

0 0.5 1.0





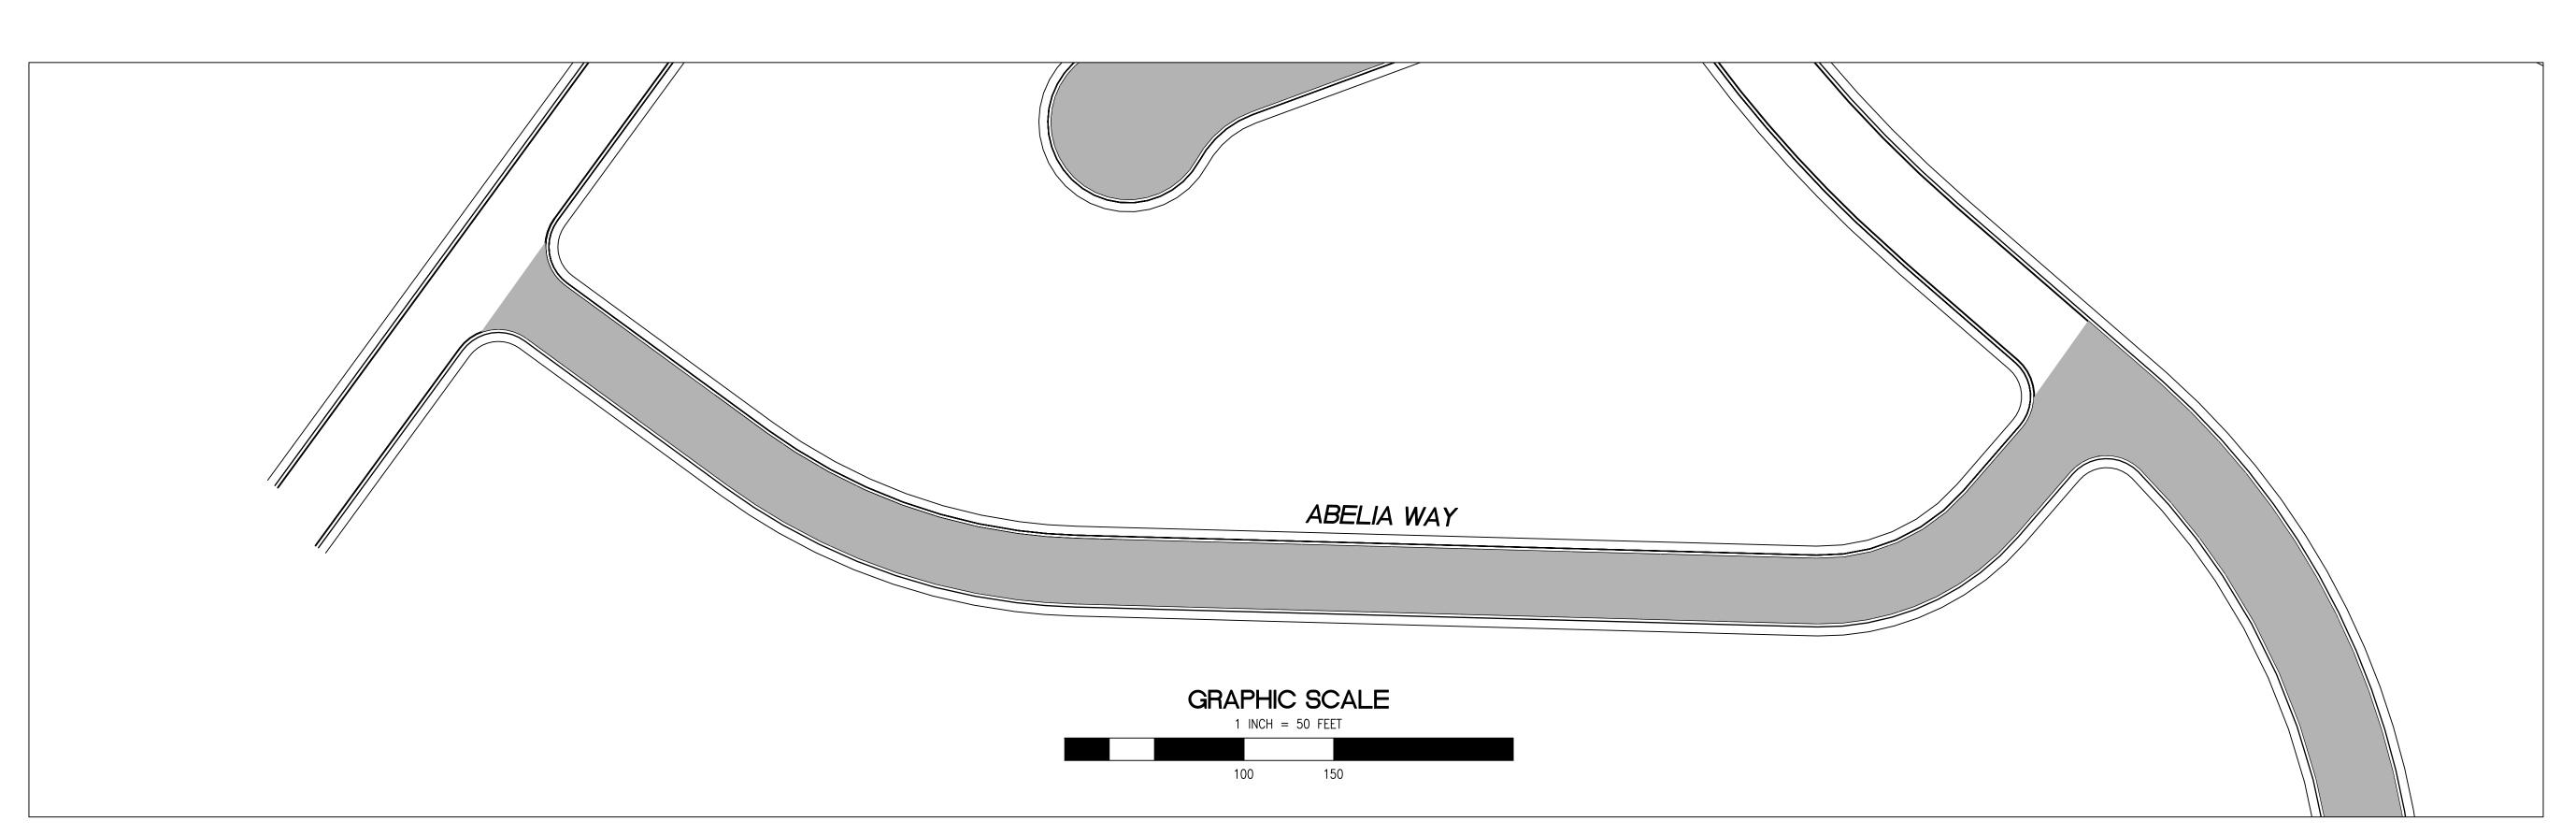

2" GRIND AND 2" OVERLAY

2" A.C. OVERLAY


SHEET NOTES

- 1 PROTECT IN PLACE
- 2 RAISE STORM DRAIN MANHOLE
- 3 RAISE COMMUNICATION VAULT
- 4 RAISE MONUMENTS
- 5 RAISE SANITARY SEWER MANHOLE
- 6 RAISE DETECTOR VAULT
- 7 REMOVE AND REPLACE TRAFFIC LOOPS
- 8 REMOVE AND REPLACE SPEED HUMP
- 9 REMOVE AND REPLACE CURB & GUTTER
- 10 PAVEMENT LEGENDS "STOP" / "BUMP"

- (11) CENTERLINE STRIPE YELLOW (PER CALTRANS DETAIL A20A DETAIL 21)
- 12) STOP BAR 12" WHITE STRIPE
- (13) CROSS WALK (PER CALTRANS STANDARD A24F)
- 14) ADA CURB RAMPS (NOT TO SCALE, SEE DETAIL $\frac{5}{39}$ OR CALTRANS STANDARD A88A)
- 15) PROTECT DRAIN INLET IN PLACE
- 16 REMOVE AND REPLACE VALLEY GUTTER
- 17) REPLACE MONUMENT FRAME AND COVER
- 18) 5' WIDE CLASS II BIKE LANE (PER NACTO/CA MUTCD STANDARD)
- 20 BIKE LANE DASHED GREEN LANE (PER NACTO/CA MUTCD STANDARD)

- 21) CLASS III BIKE SHARROWS (PER NACTO/CA MUTCD STANDARD)
- 22) ADD "NO DUMPING, DRAINS TO BAY" STENCIL
- (24) CONSTRUCT NEW 4' V-GUTTER (SEE DETAIL XX, SHEET XX)
- 25) YELLOW SCHOOL CROSSWALK (PER CALTRANS STANDARD A24F) 26 2" GRIND AND OVERLAY (SEE DETAIL XX, SHEET XX)
- 27) TYPE II SLURRY SEAL
- 28) REMOVE THERMOPLASTIC
- 19 BIKE LANE SYMBOL WITH GREEN LANE (25' LENGTH) (PER NACTO/CA MUTCD STANDARD) (29 CONSTRUCT NEW DRIVEWAY APPROACH (SEE DETAIL XX, SHEET XX)
 - 30 CONSTRUCT NEW 2" MIN. A.C. OVER COMPACTED SUBBASE (2% SLOPE)

- (31) CONSTRUCT NEW SPEED HUMP (SEE DETAIL XX, SHEET XX)
- 32) PAVEMENT LEGENDS "SLOW SCHOOL XING" (PER CALTRANS STANDARD A24D) (23) CONSTRUCT NEW GUTTER, CURB, AND SIDEWALK (SEE DETAIL XX SHEET XX) (33) GRIND AND REPLACE SPEED HUMP (SEE DETAIL XX, SHEET XX)
 - 34) 2" OVERLAY (SEE DETAIL XX, SHEET XX)
 - 35) PEDESTRIAN CROSSING SIGN (CALTRANS SIGN W11-2)
 - (36) IN-ROAD PEDESTRIAN CROSSING SIGN (CALTRANS SIGN R1-6)
 - 37) NO PARKING SIGNS (CALTRANS SIGN R28 (CA))

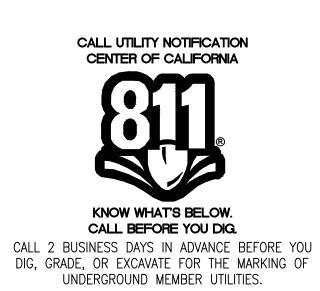


PROJECT/JOB NUMBER

ST-07-25



RELATIVE BORDER SCALE IS IN INCHES

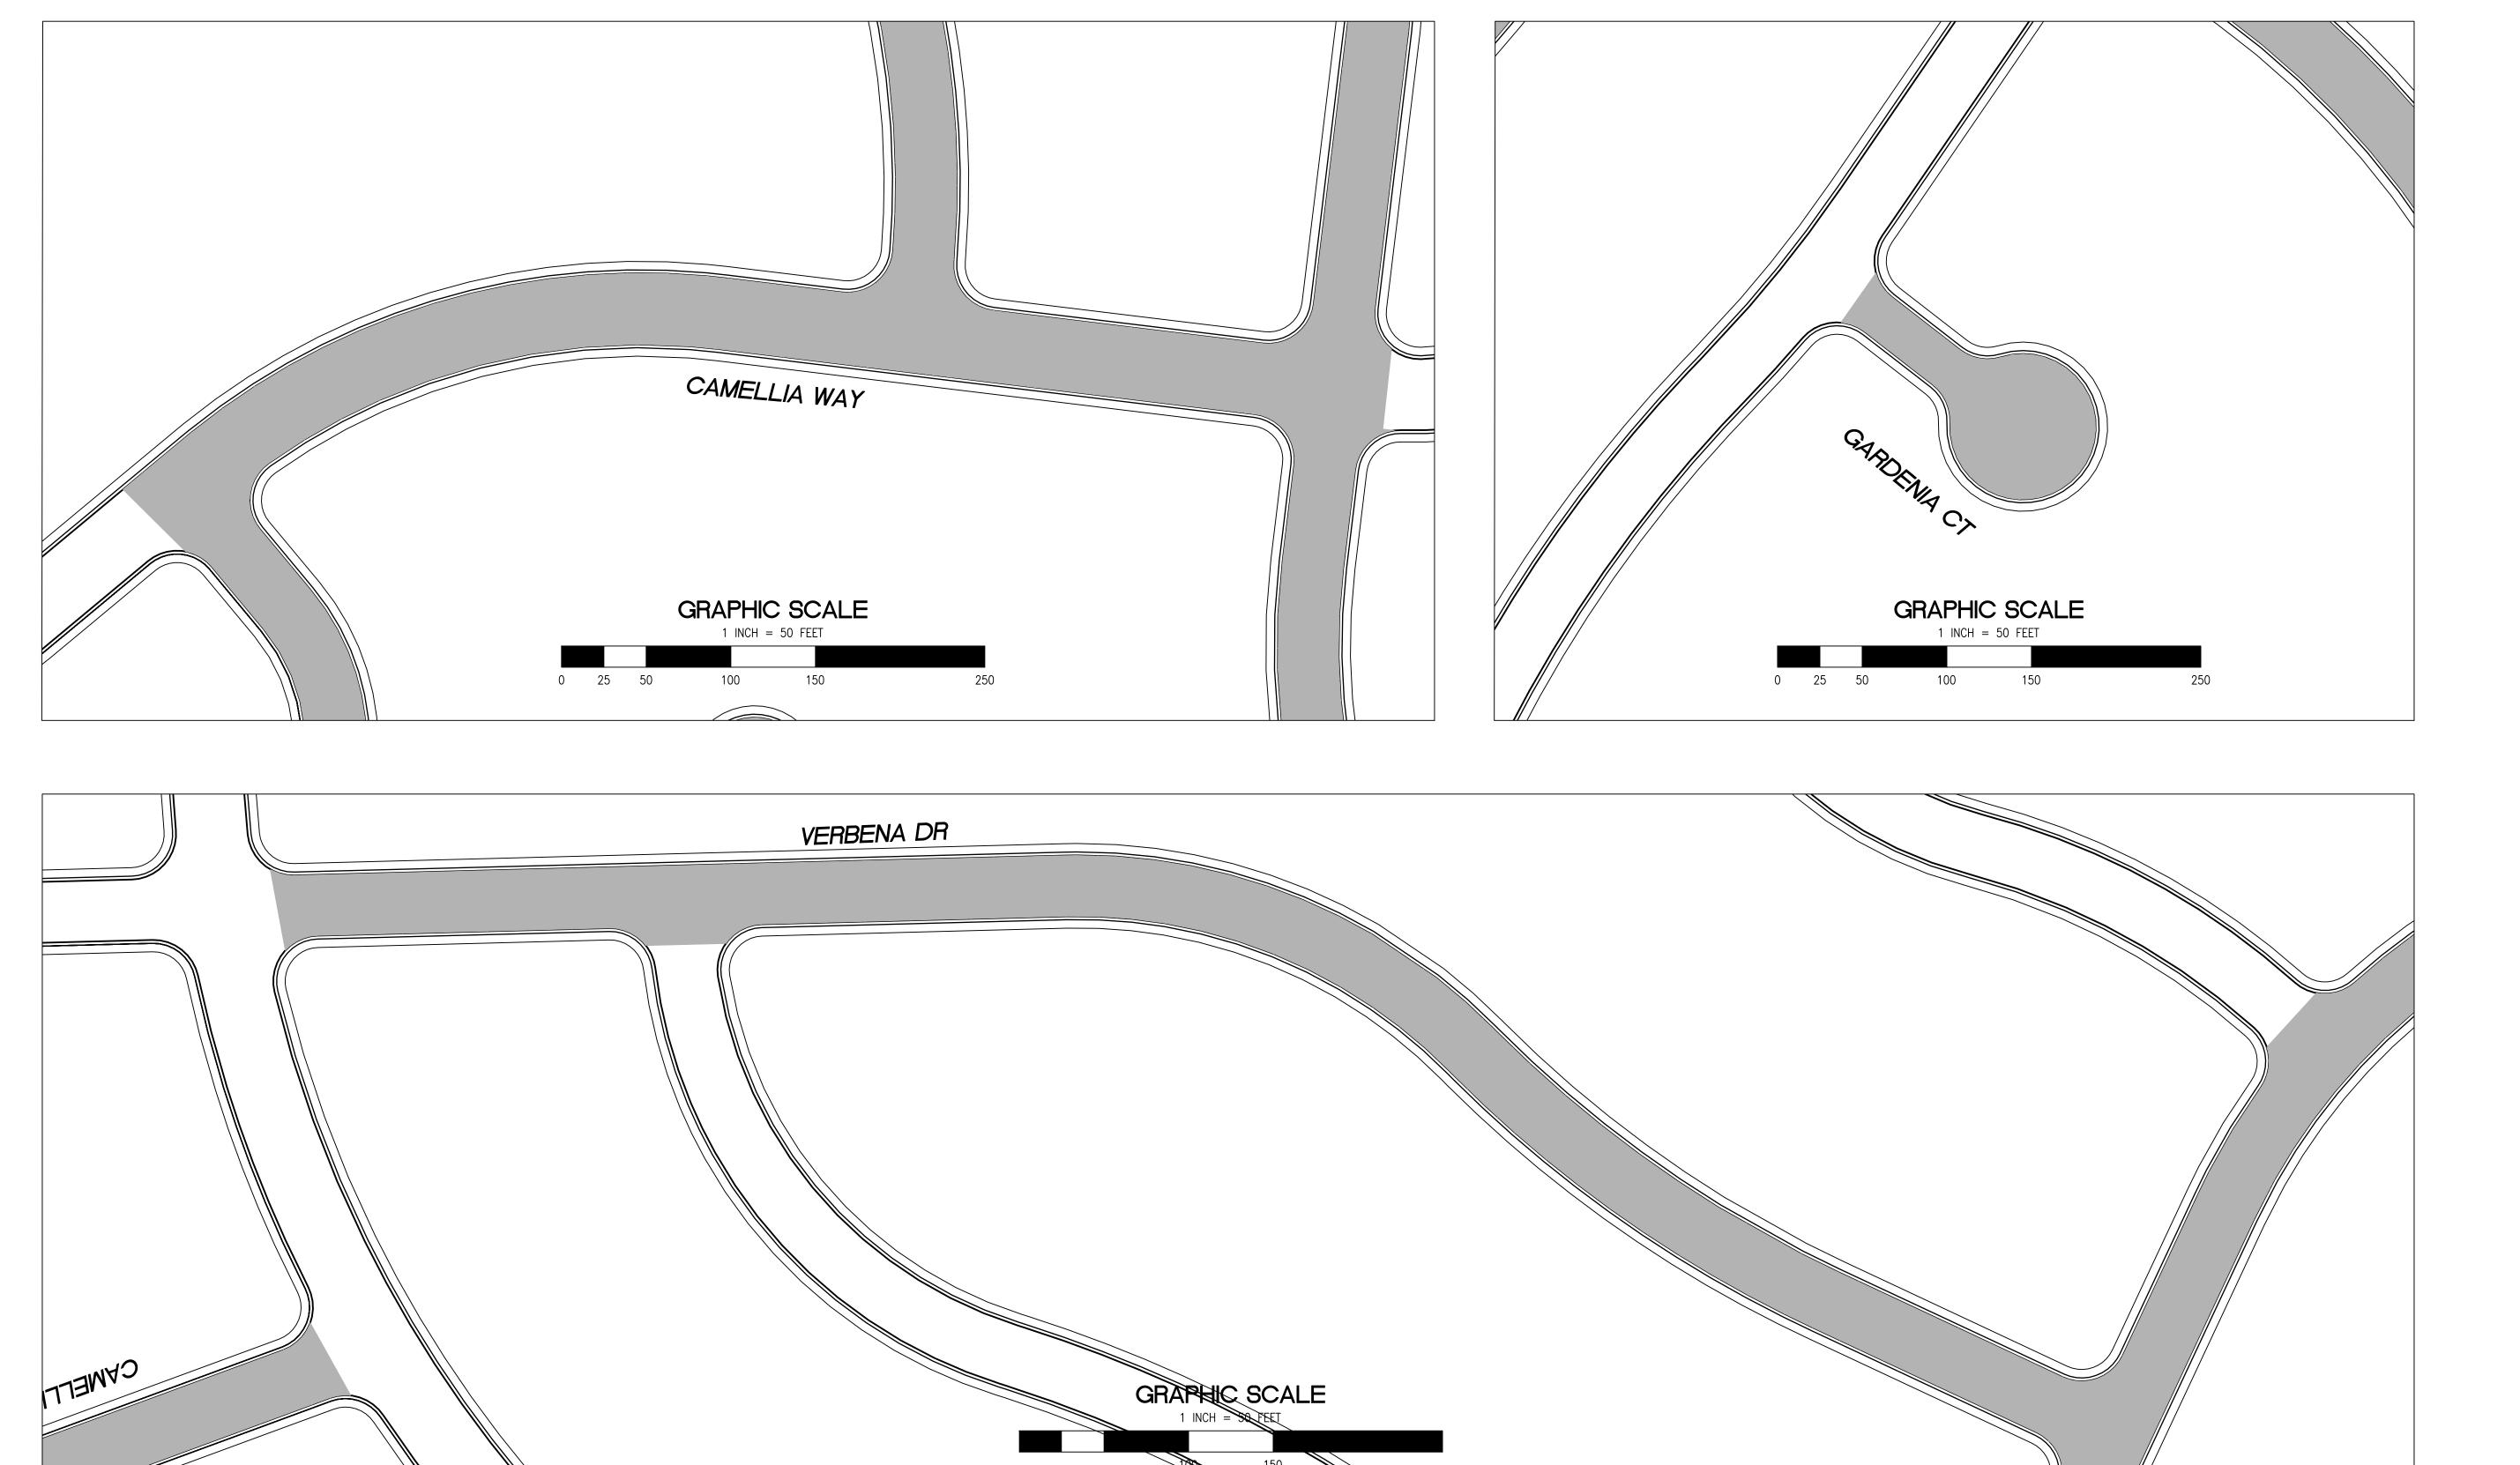

2" GRIND AND 2" OVERLAY

2" A.C. OVERLAY


SHEET NOTES


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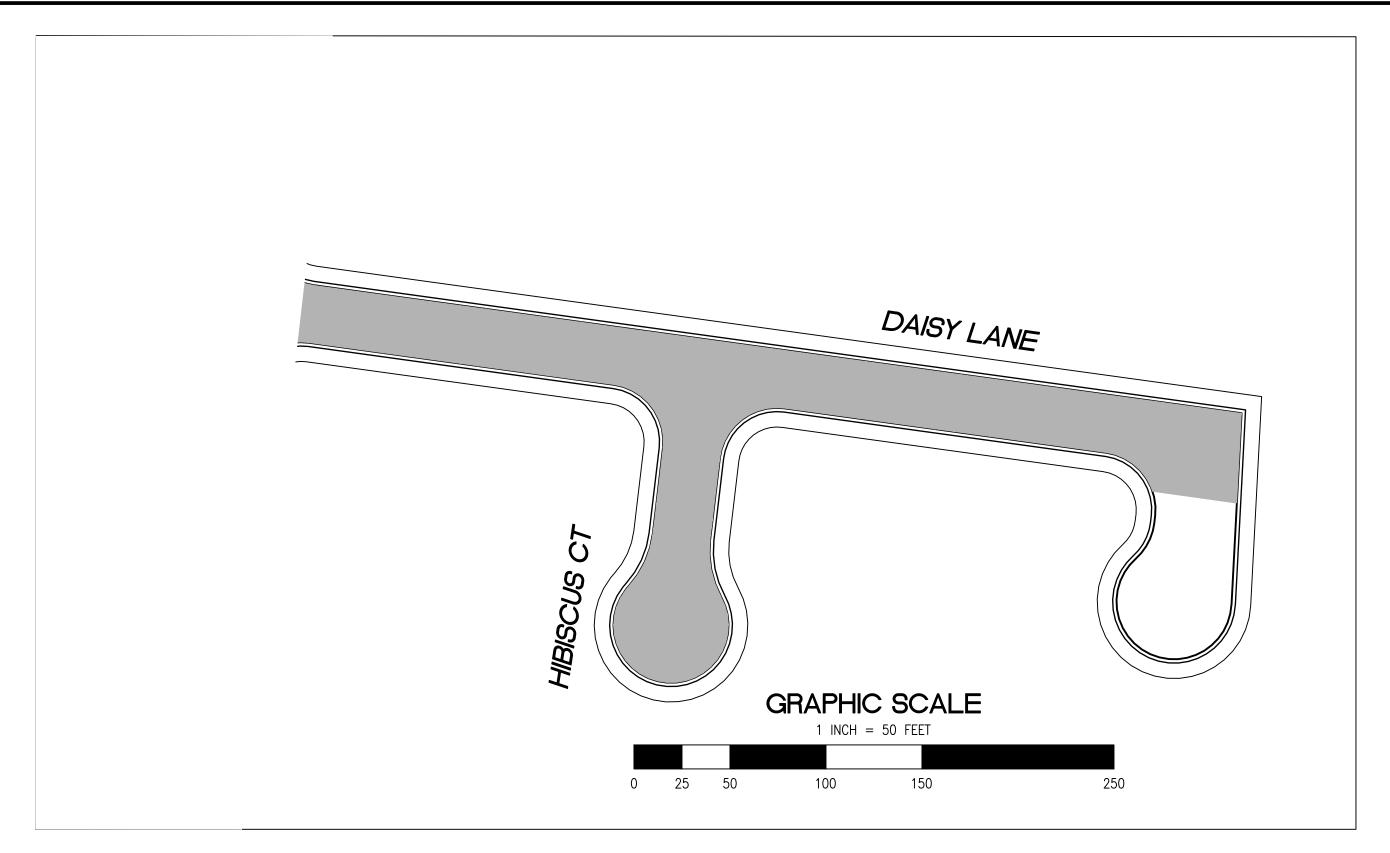





PROJECT/JOB NUMBER

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2" GRIND AND 2" OVERLAY

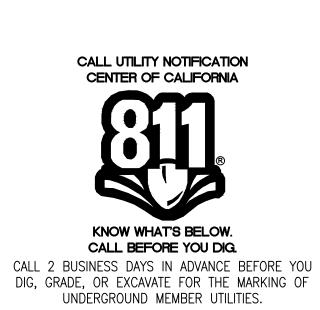
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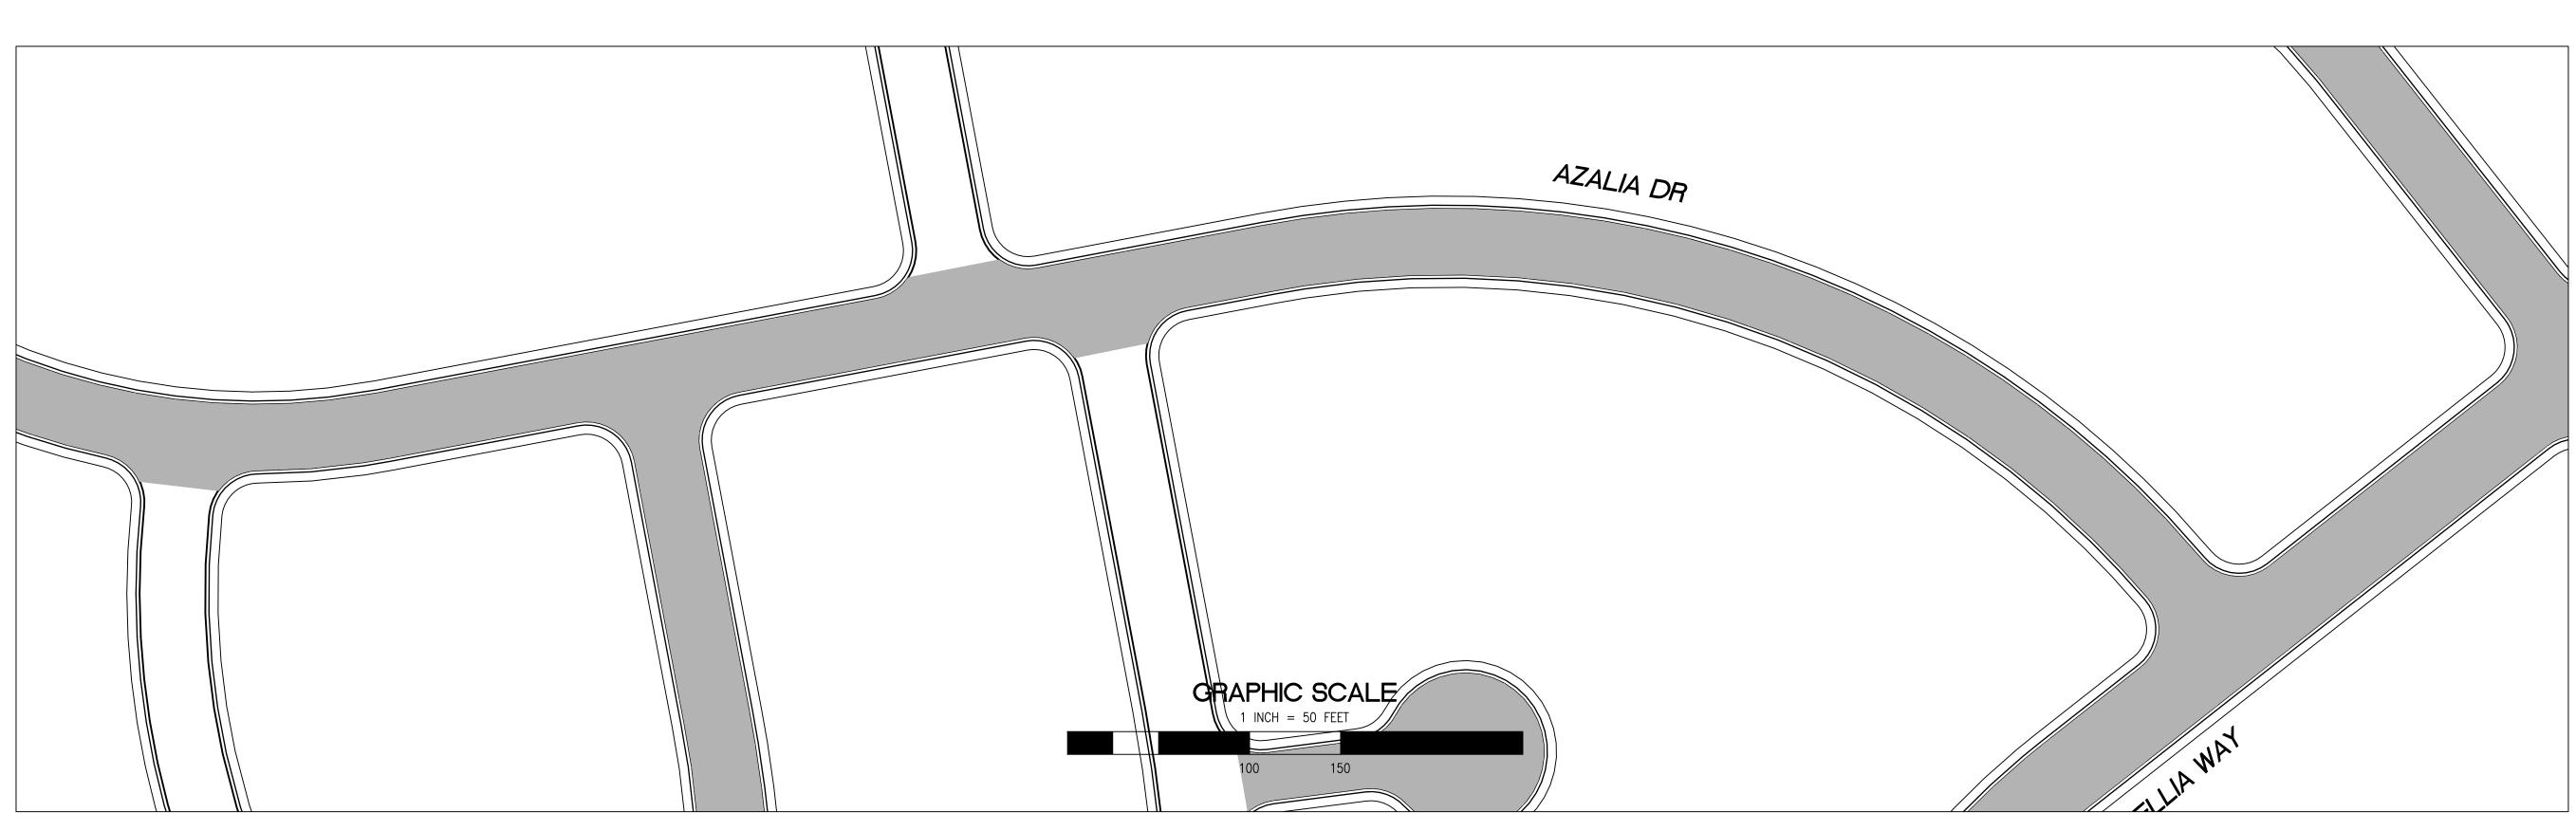


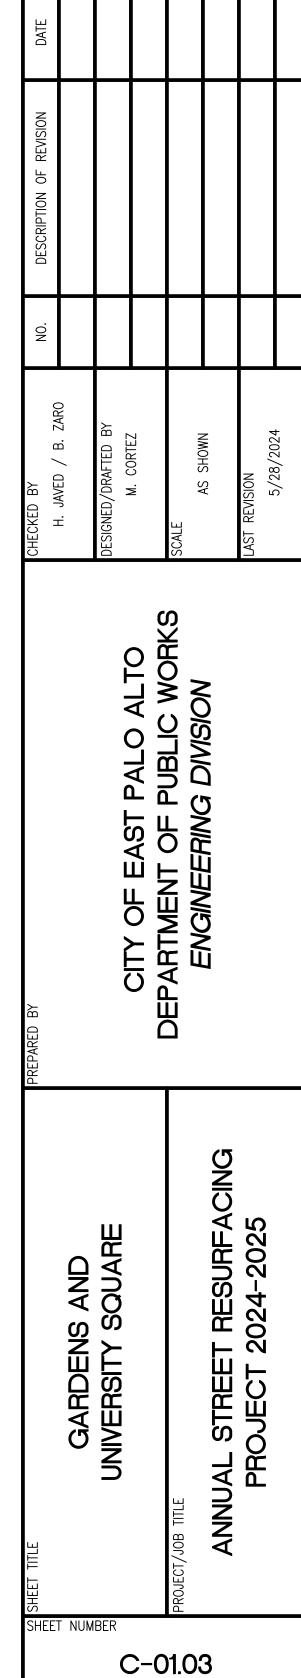CHECKED BY NO. DESCRIPTION OF REVISION	n. JAVED / B. ZANO	DESIGNED,	O ALIO	SCALE SCALE AS SHOWN		LAST REVISION	1/ 20/ 2024
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SHEET TITLE	GARDENS AND	UNIVERSITY SQUARE		PROJECT/JOB TITLE	ANNUAL STREET RESURFACING	PROJECT 2024-2025	
SHEET	T NUM		D-0	1.04	4		

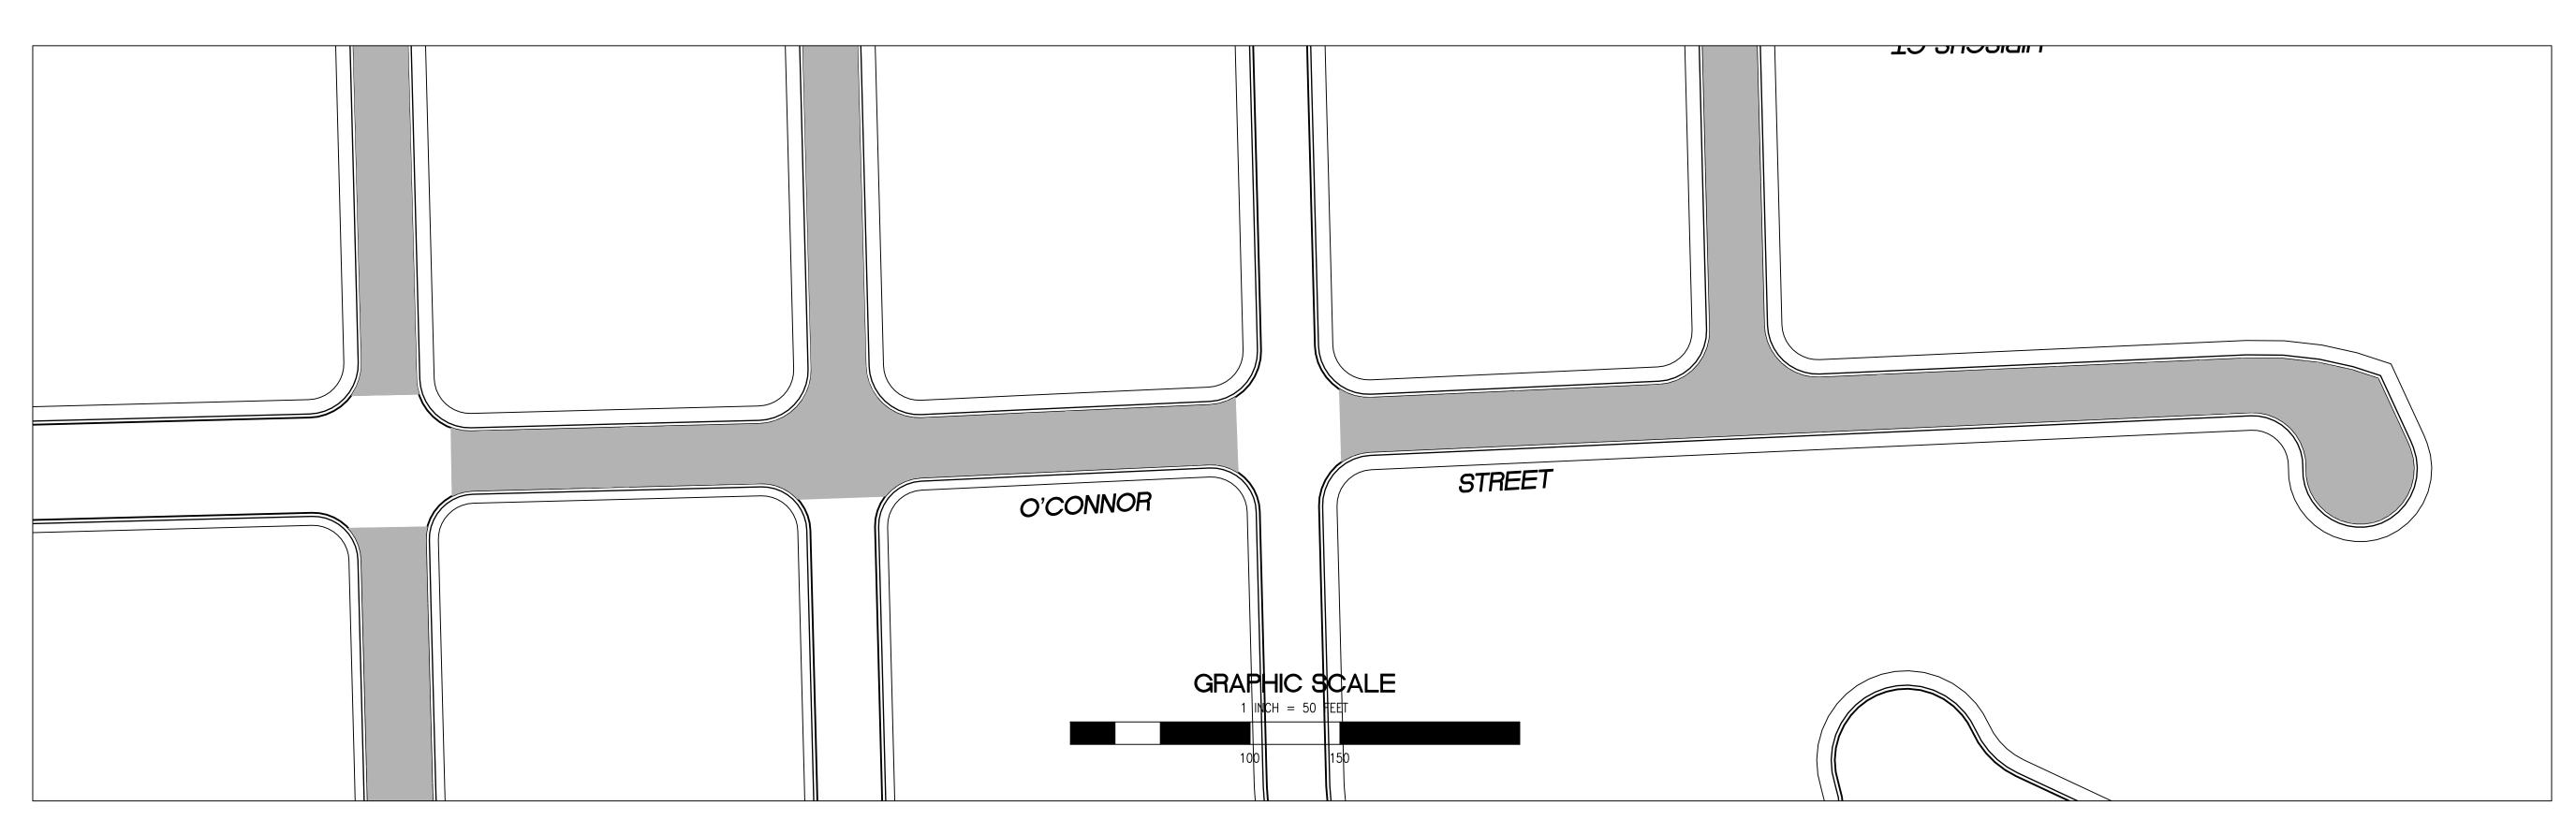PROJECT/JOB NUMBER

ST-07-25



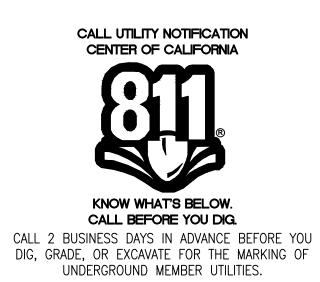

2" GRIND AND 2" OVERLAY

2" A.C. OVERLAY


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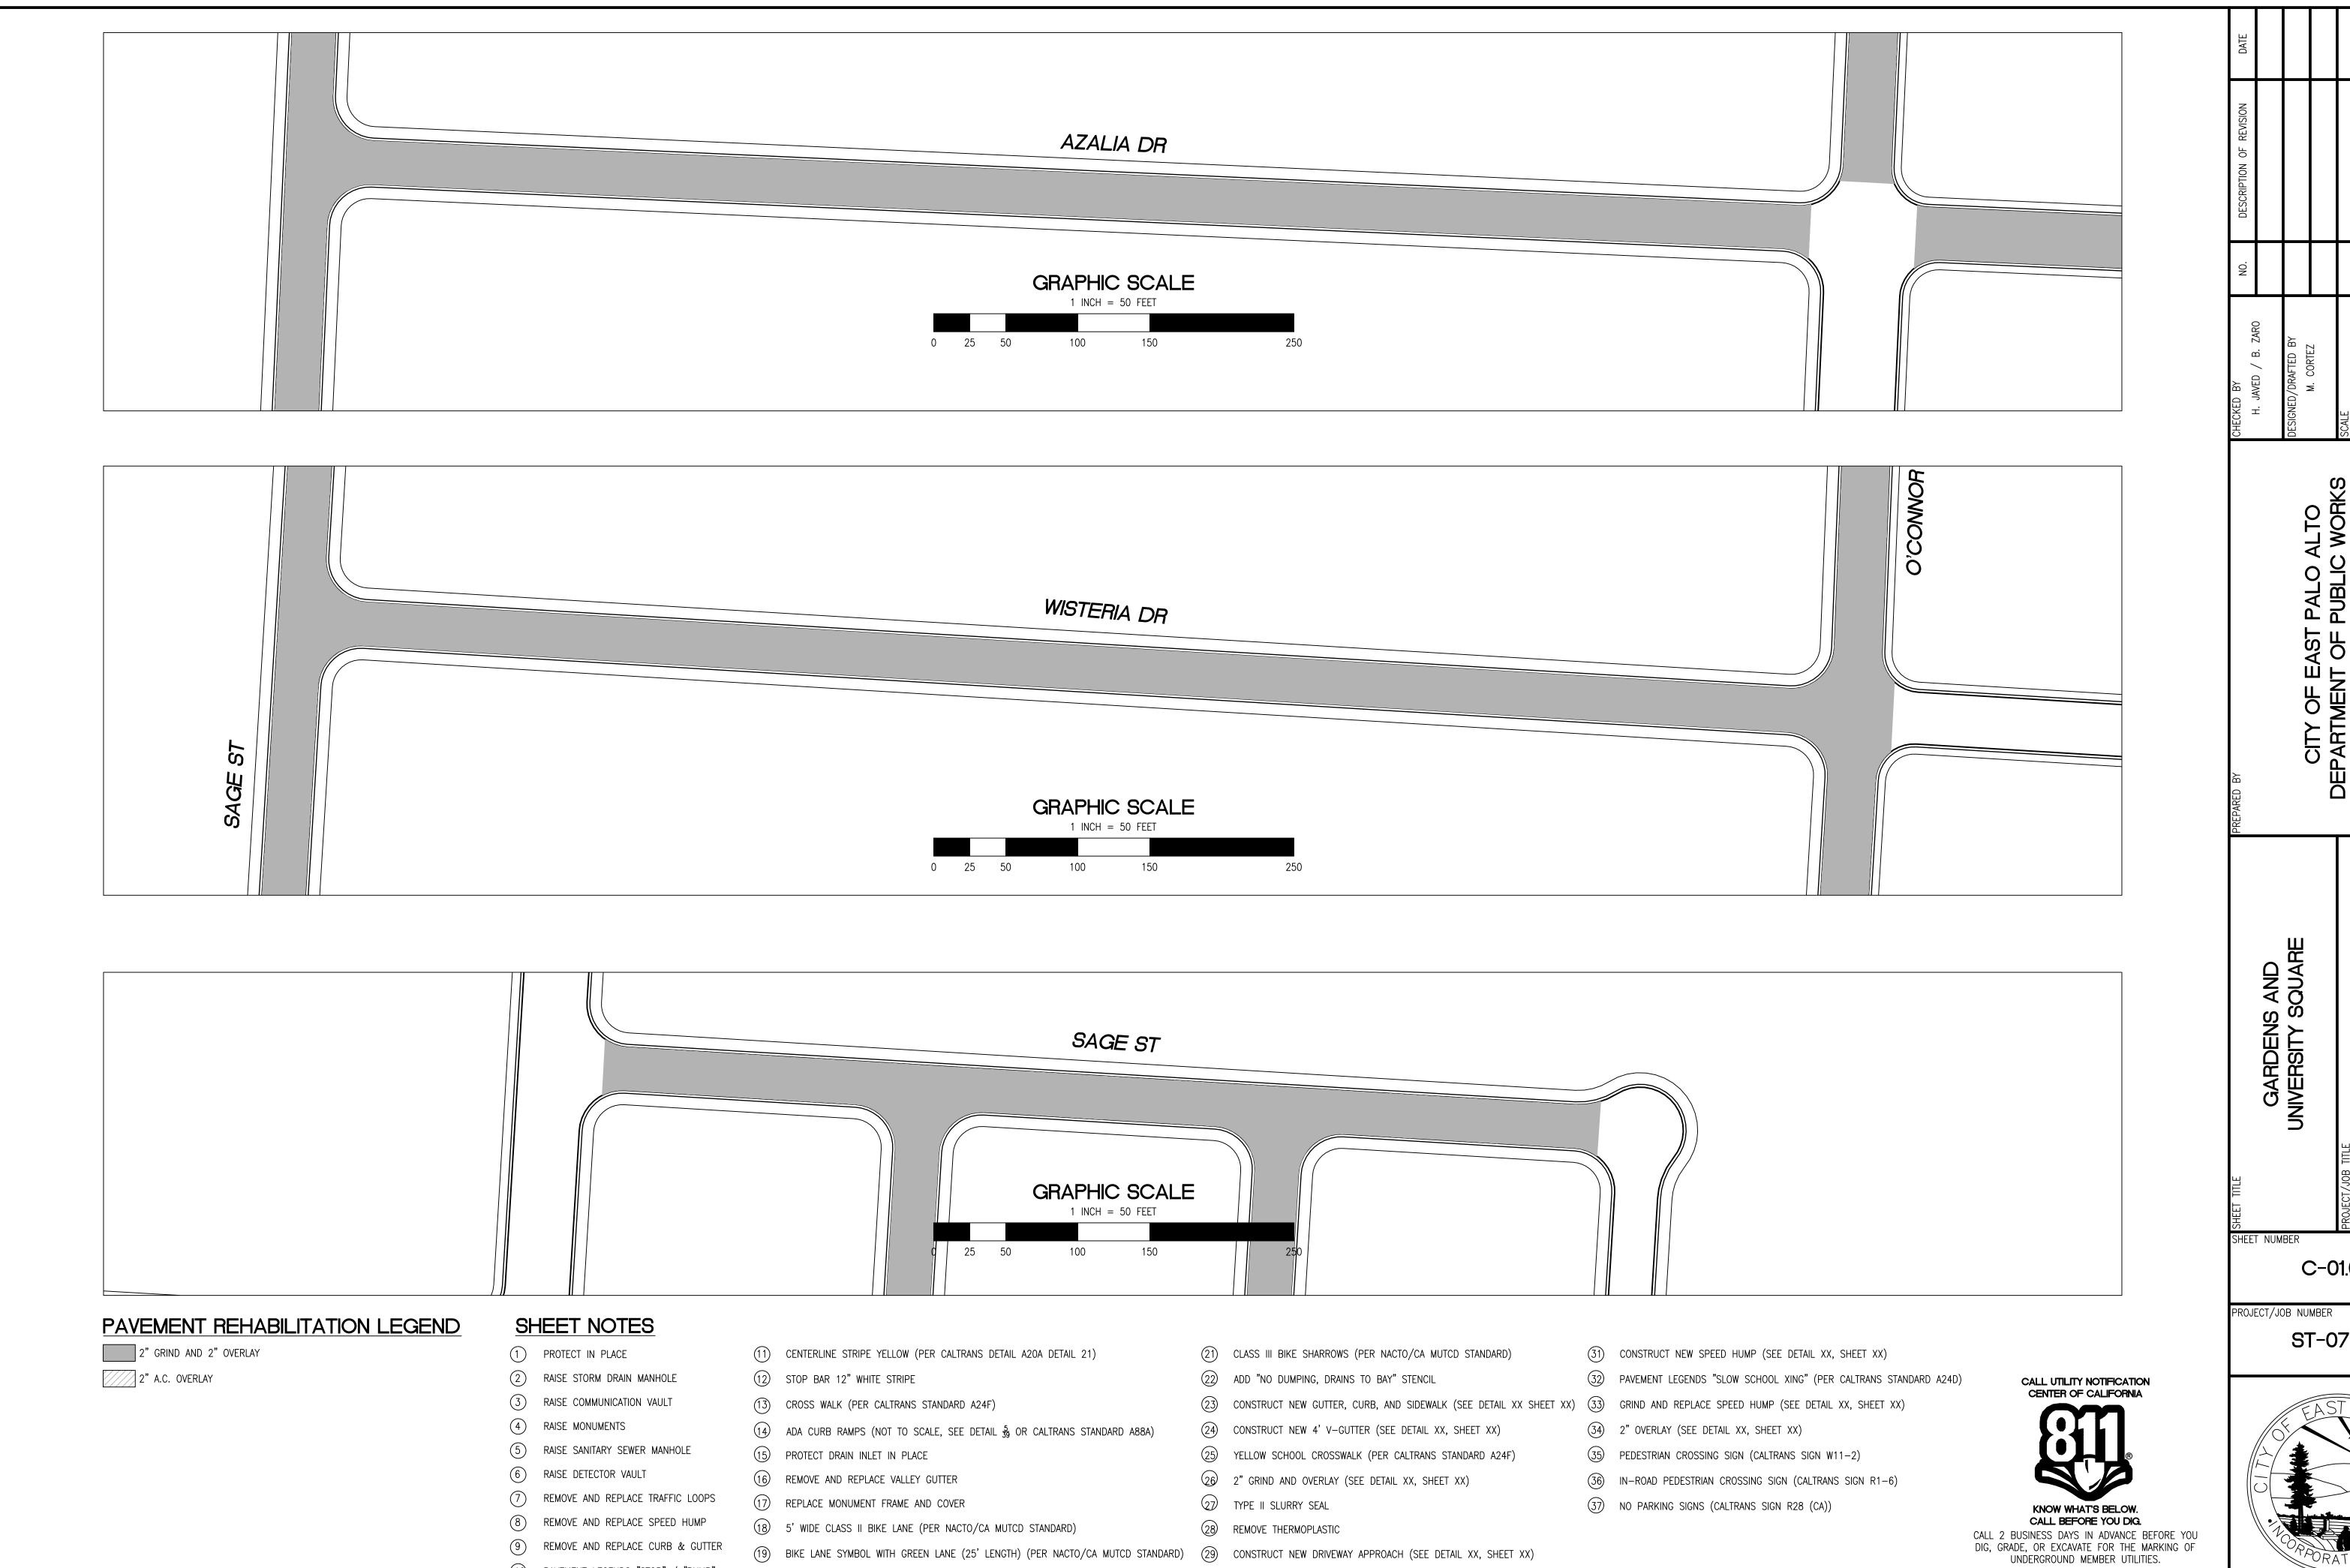


GARDENS AND UNIVERSITY SQUARE SHEET NUMBER C-01.05

PROJECT/JOB NUMBER

ST-07-25



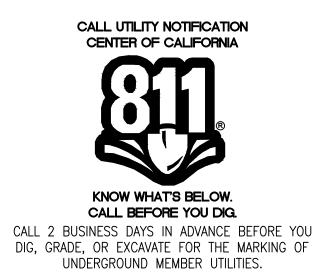


C-01.06 ST-07-25

RELATIVE BORDER SCALE IS IN INCHES 0 0.5 1.0

30 CONSTRUCT NEW 2" MIN. A.C. OVER COMPACTED SUBBASE (2% SLOPE)

20 BIKE LANE DASHED GREEN LANE (PER NACTO/CA MUTCD STANDARD)


10 PAVEMENT LEGENDS "STOP" / "BUMP"

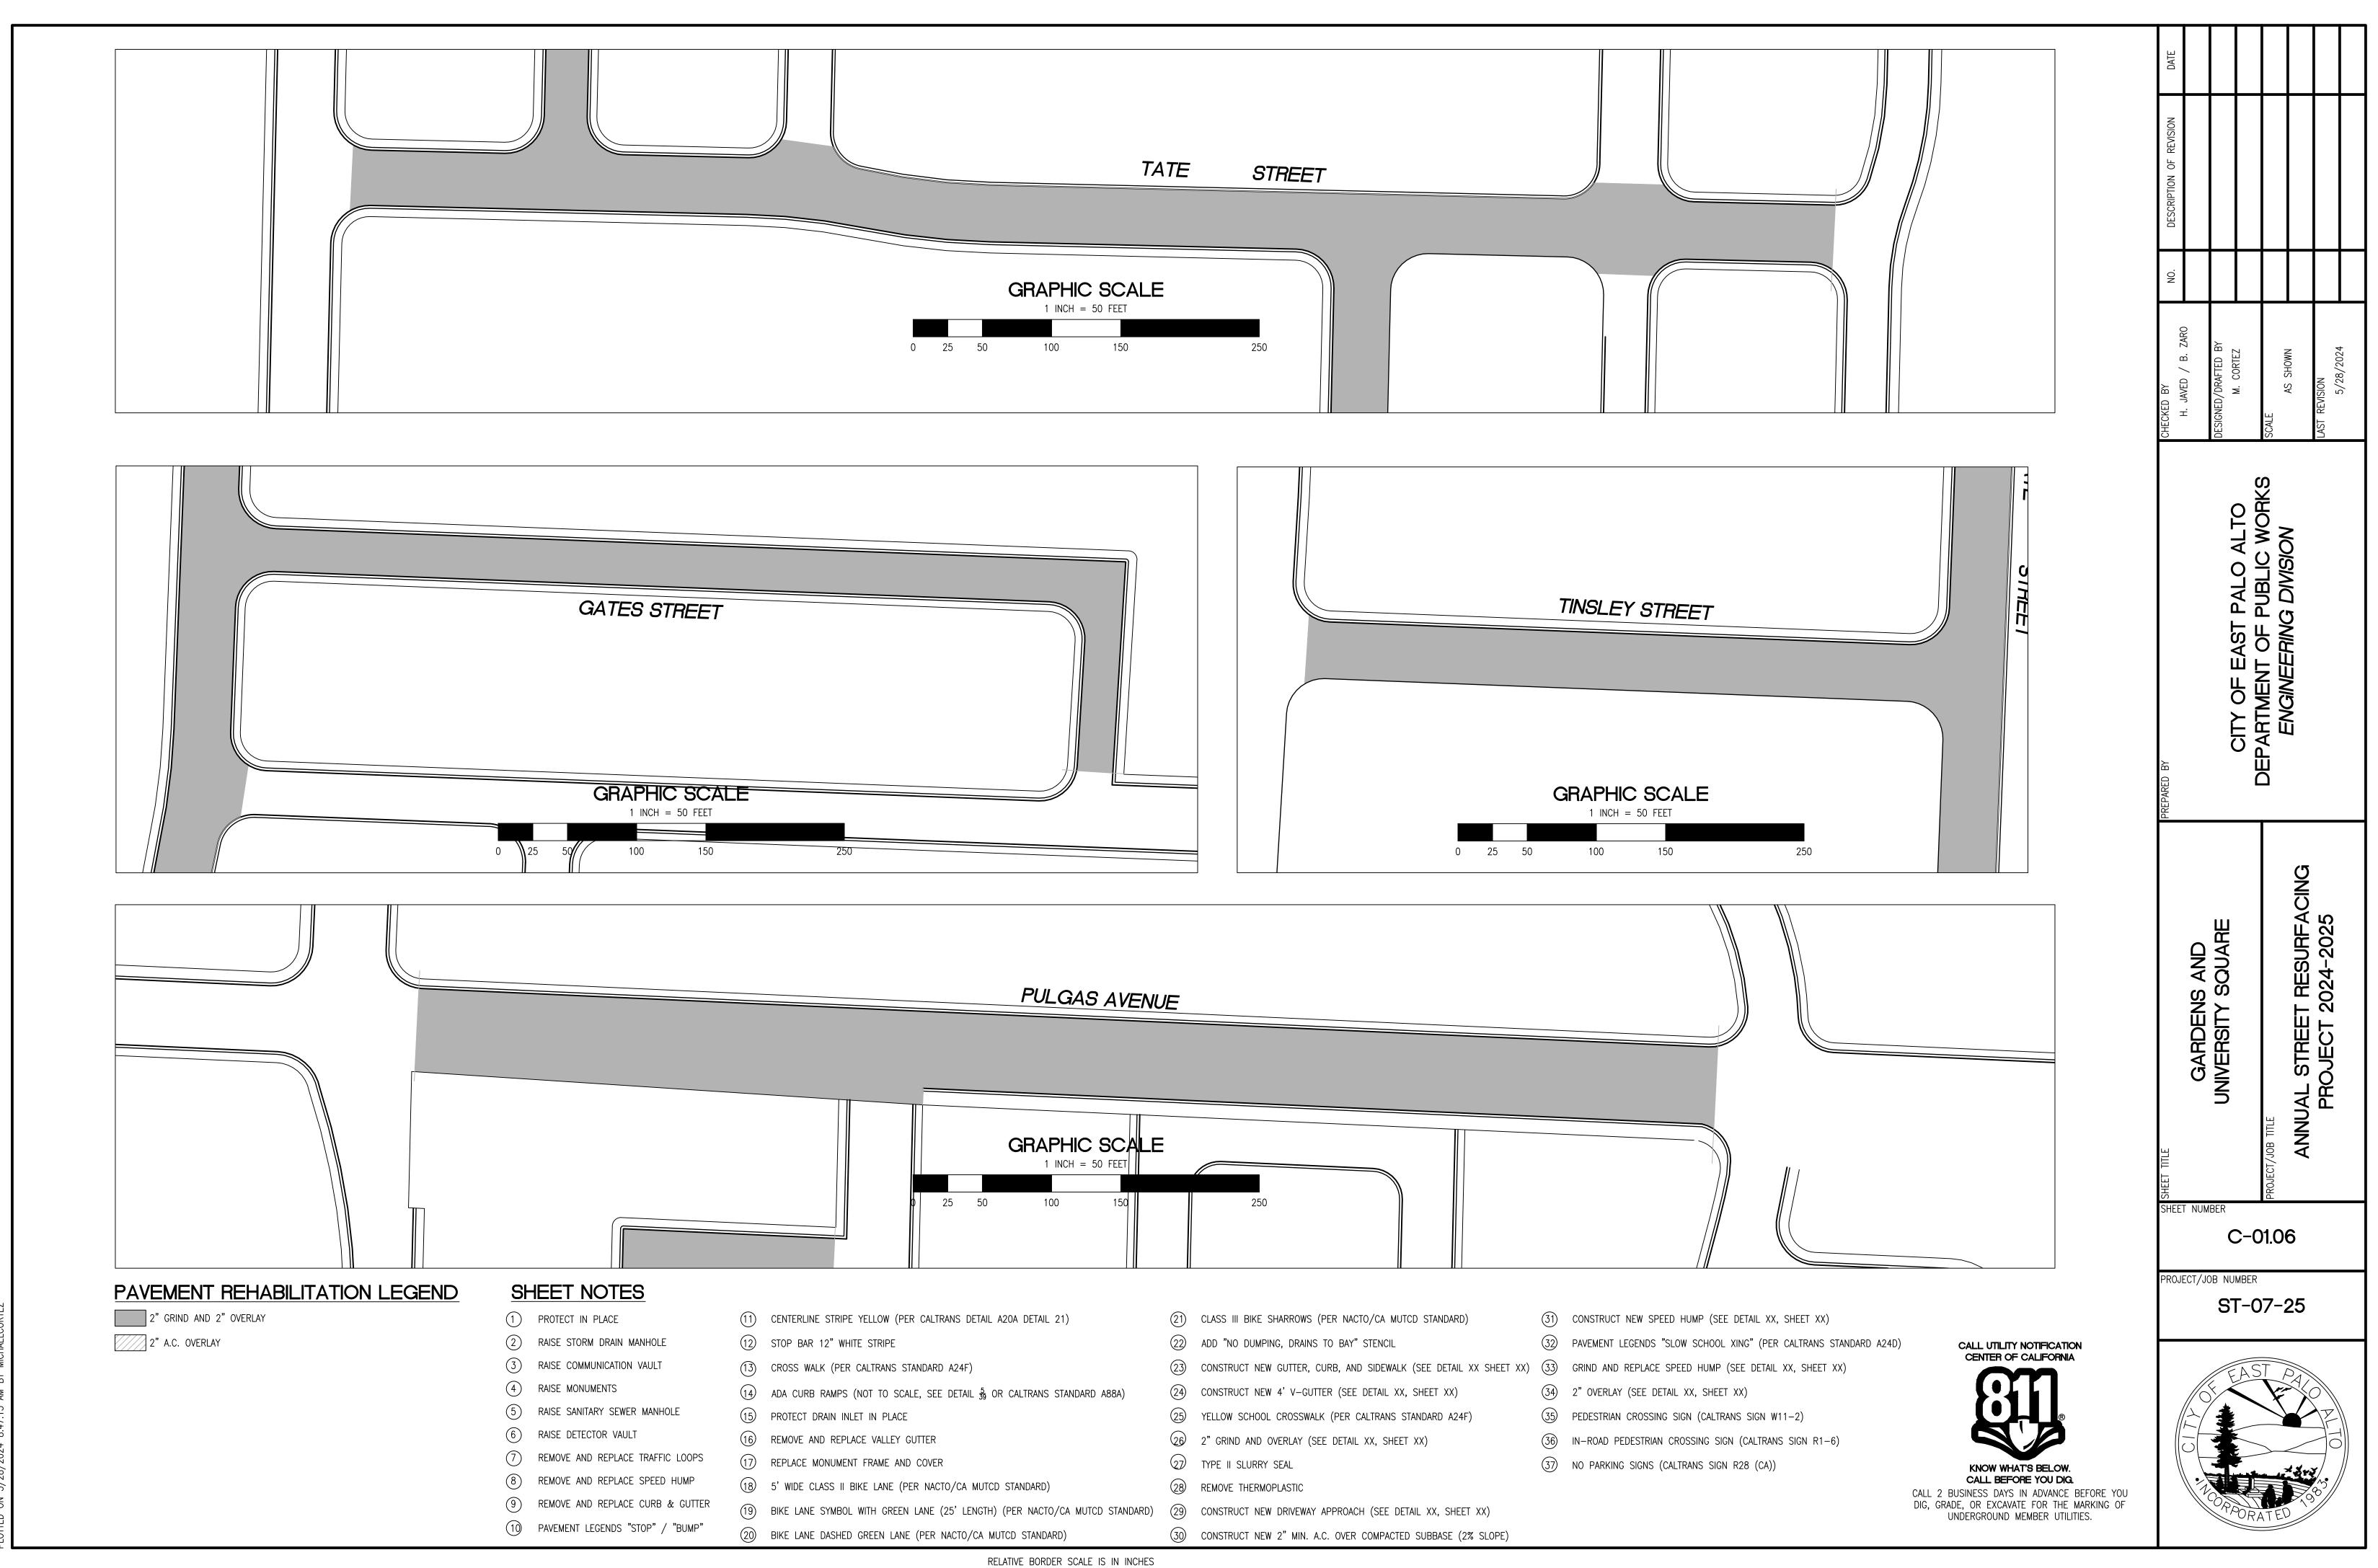

/USERS/MICHAELCORTEZ/LIBRARY/CLOUDSTORAGE/ONEDRIVE—CITYOFEASTPALOALTO/DOCUMENTS/PROJECTS/ST—07—25/CADD — PL


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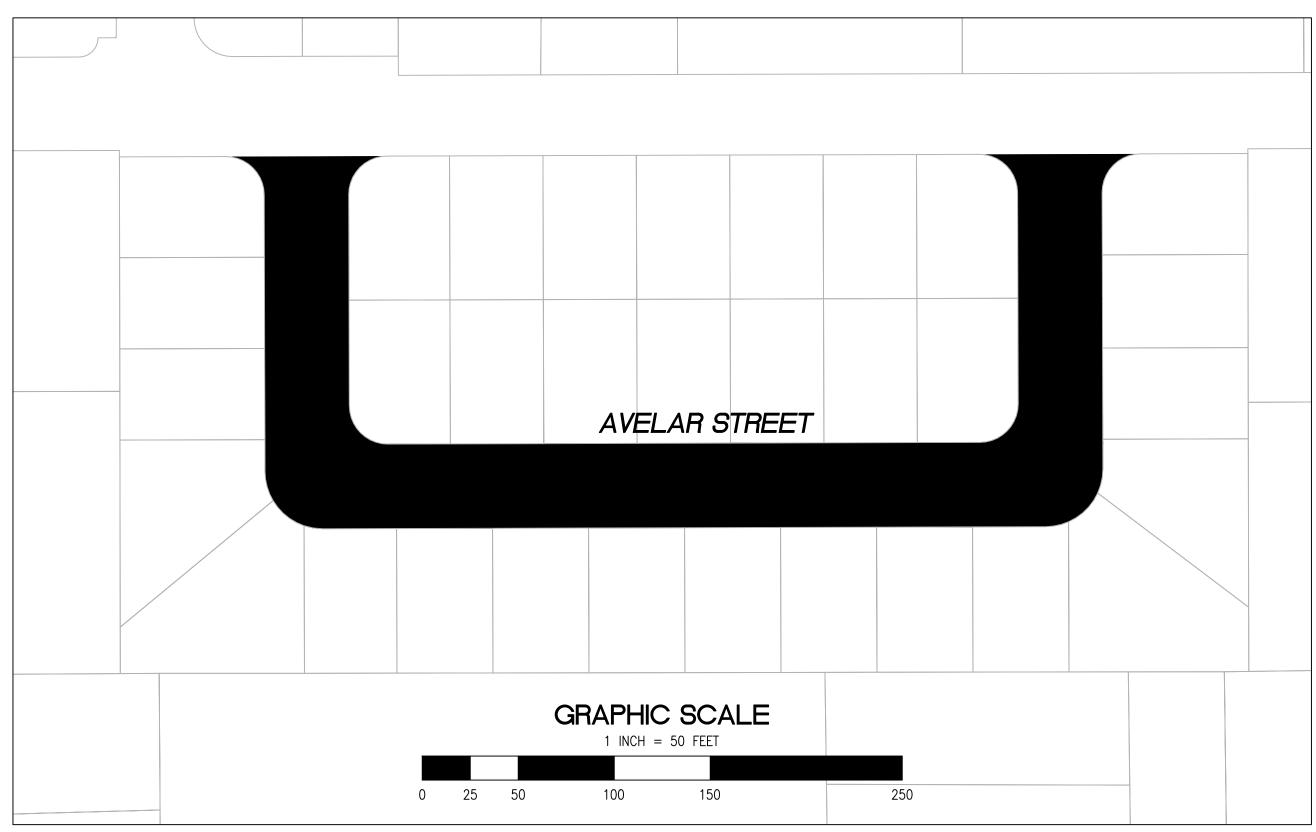
NOTE: IF THIS LINE DOES NOT MEASURE 1 INCH, THESE PLANS ARE NOT TO SCALE.

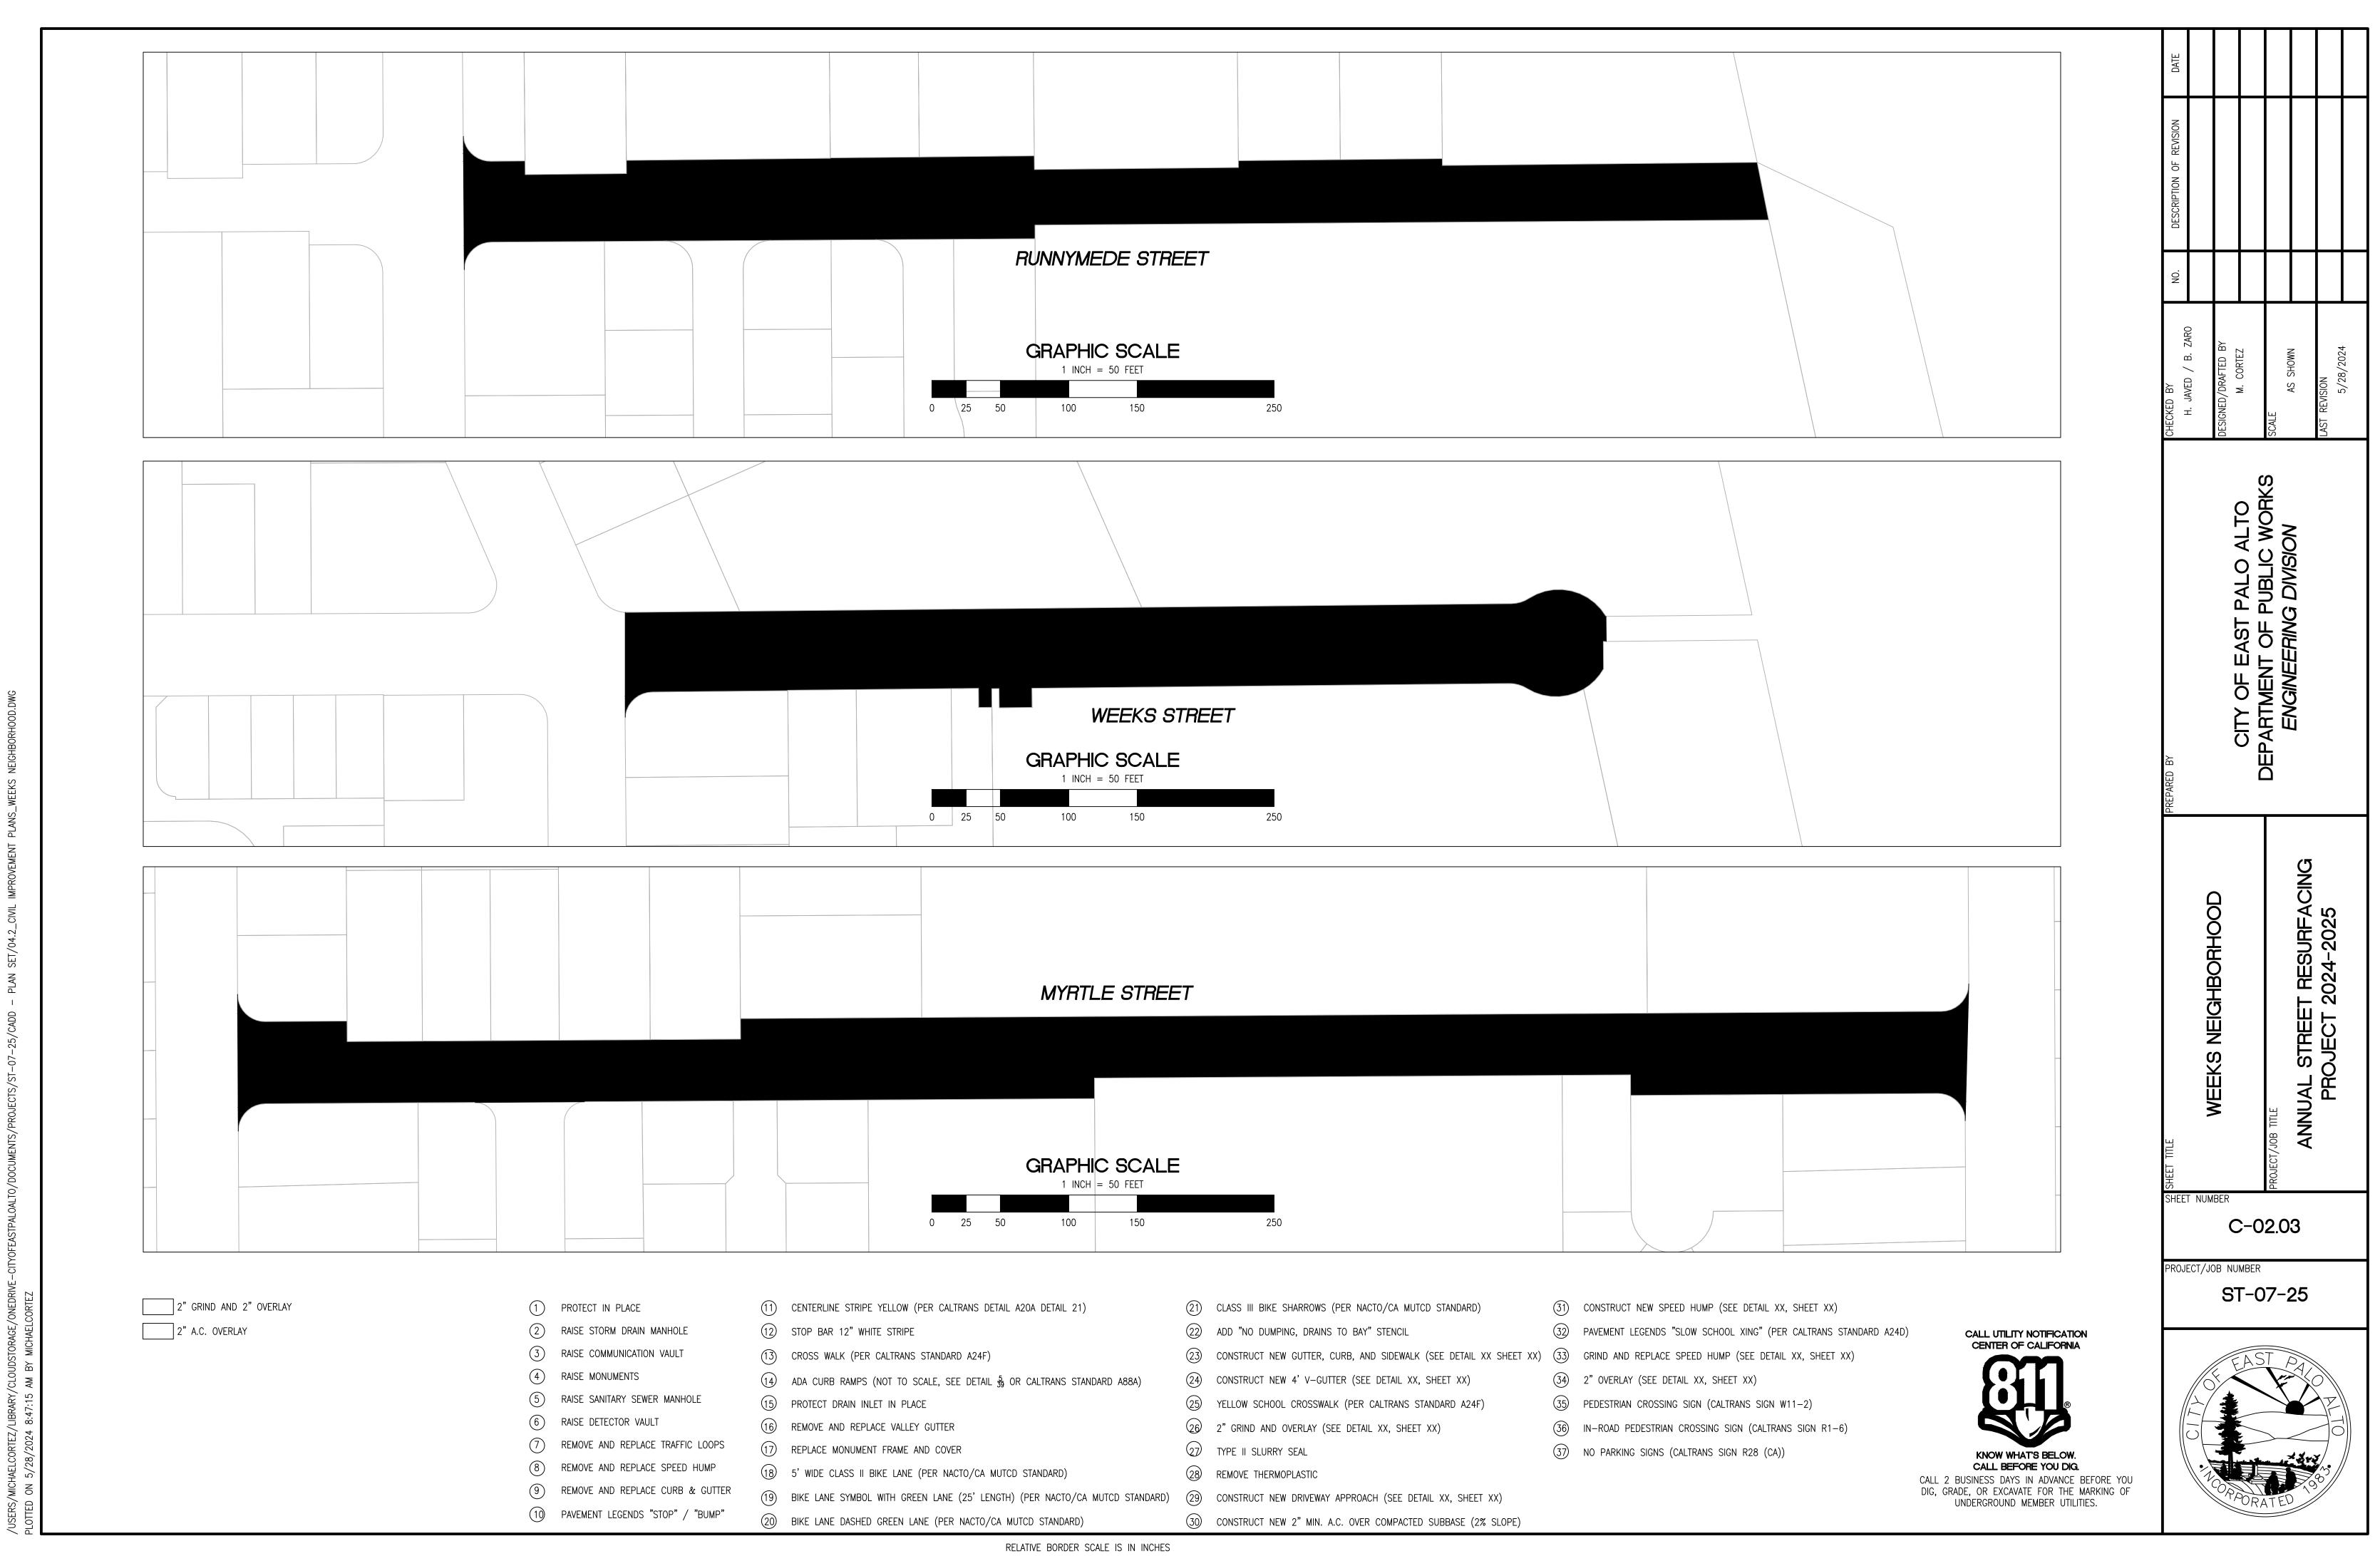


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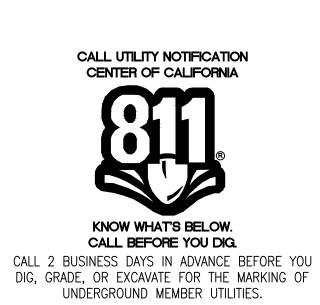
2" GRIND AND 2" OVERLAY 2" A.C. OVERLAY


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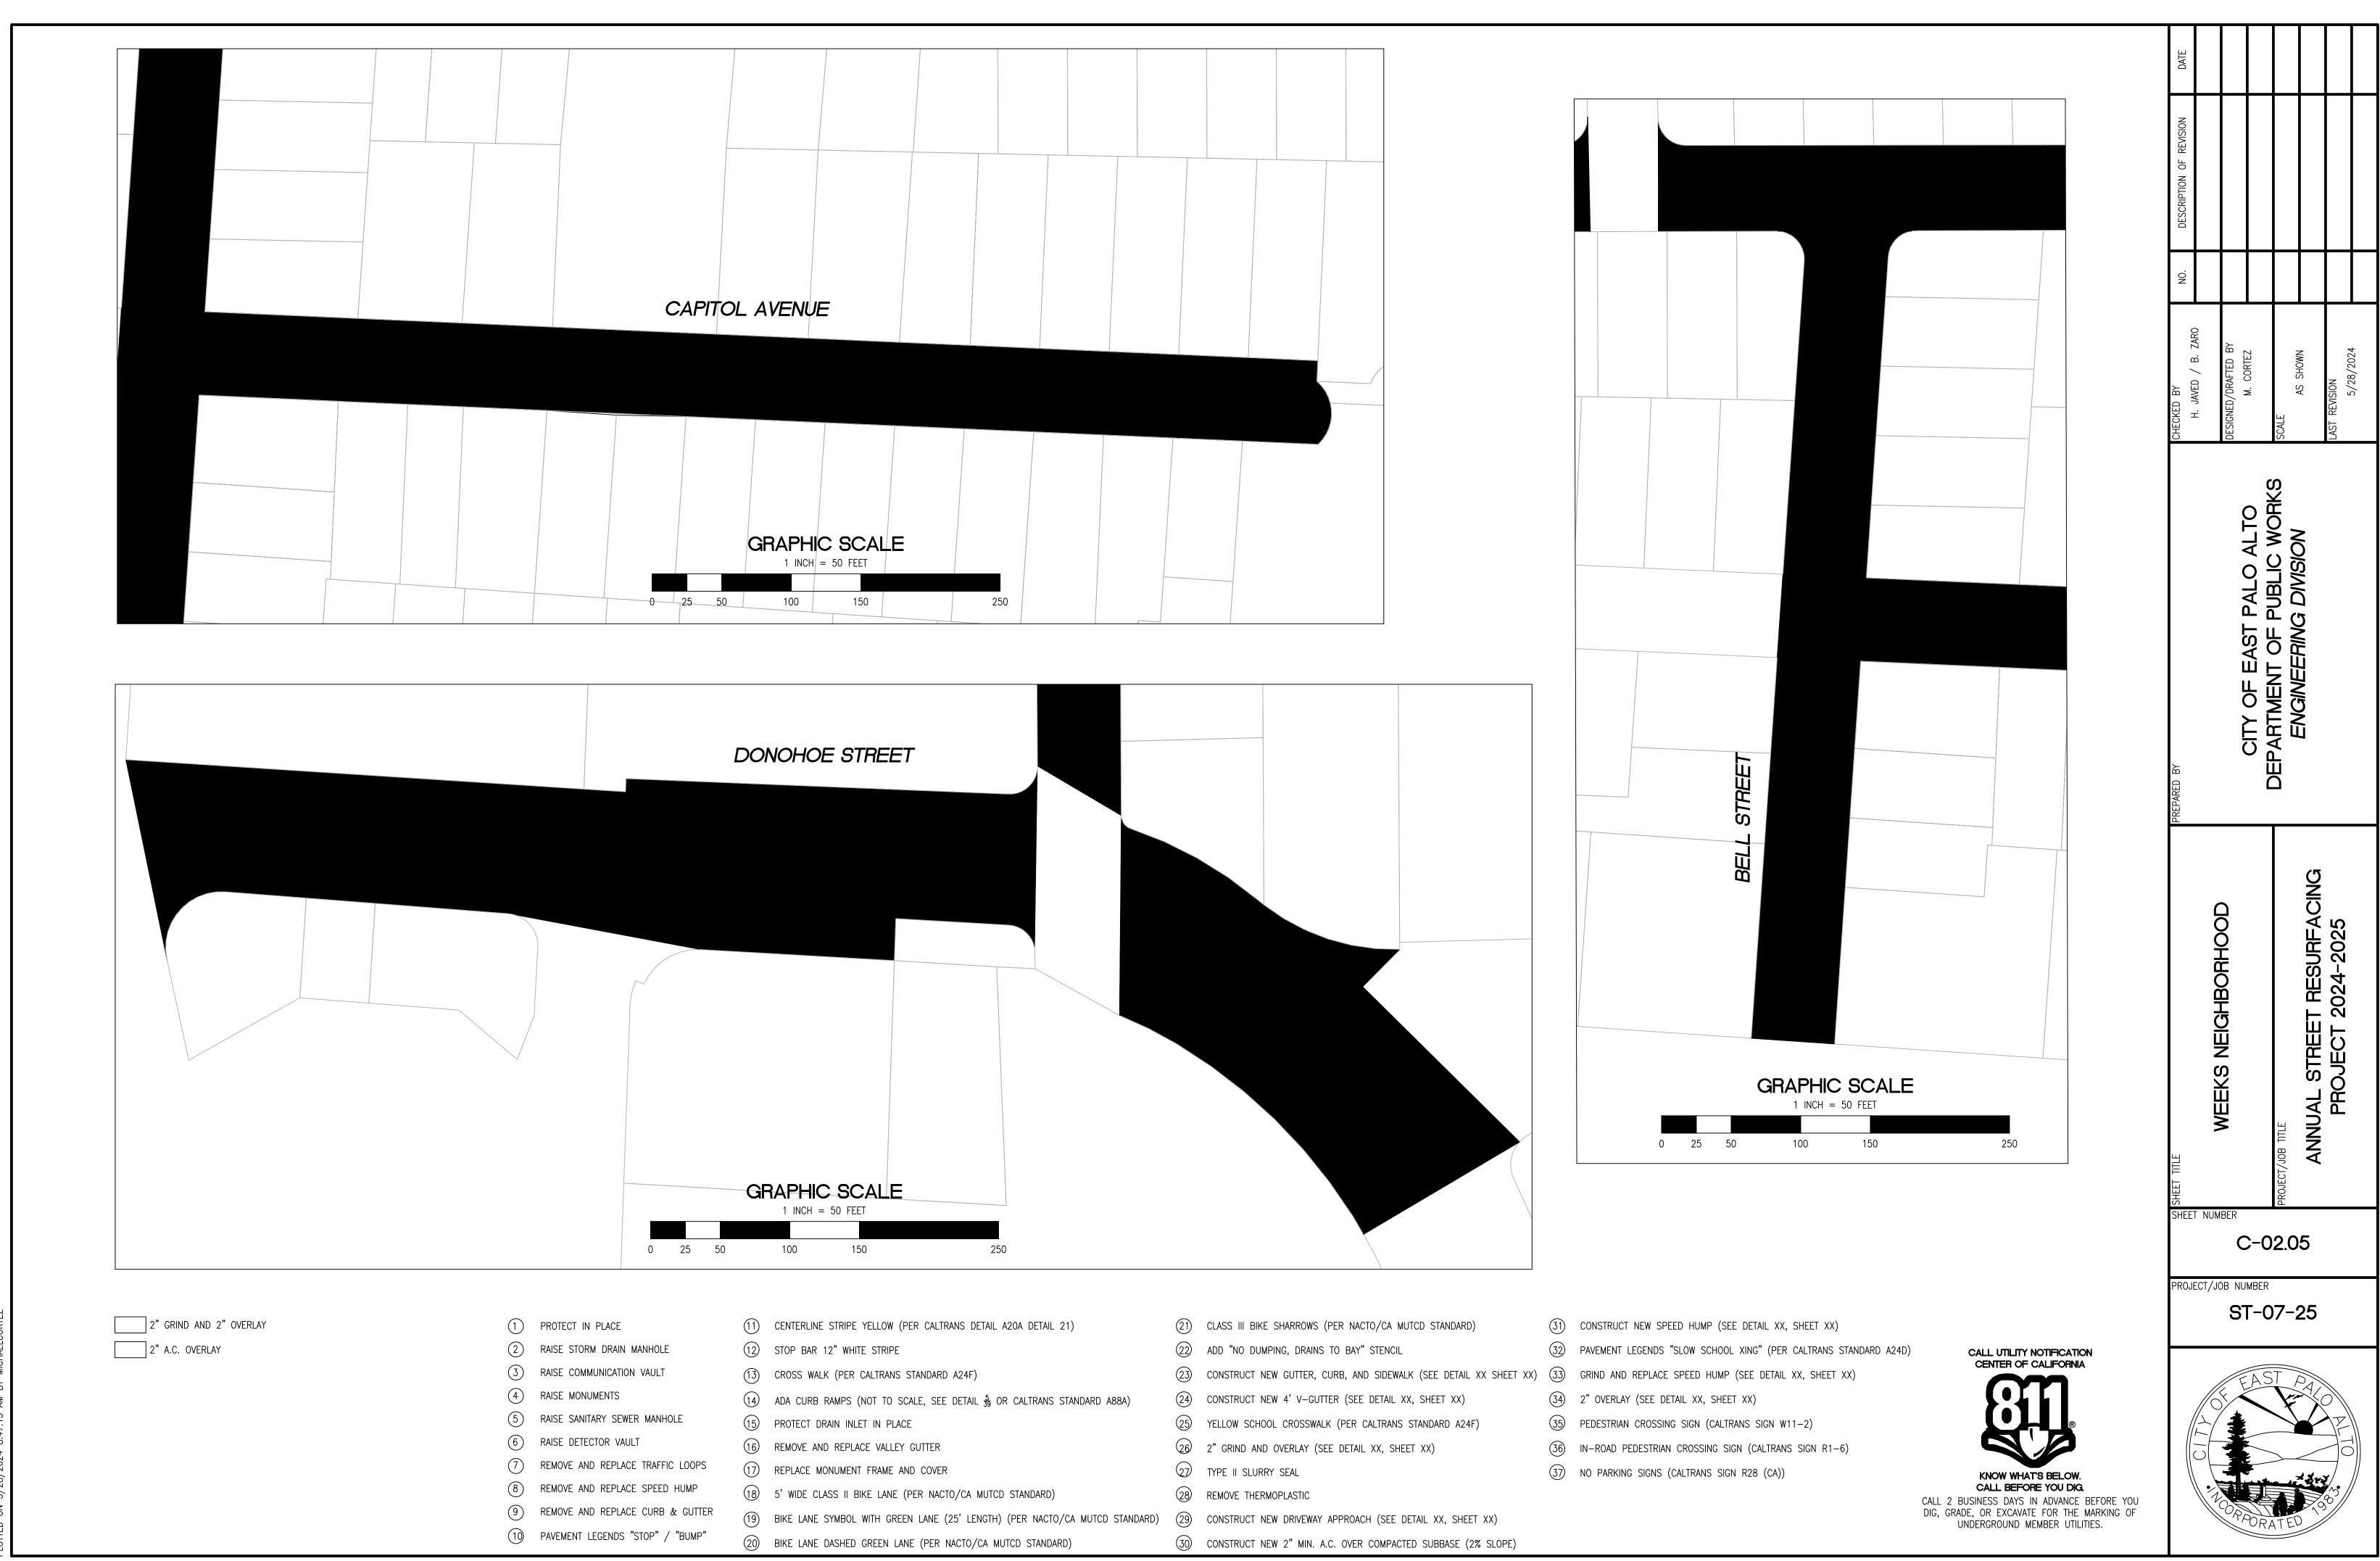
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ST-07-25




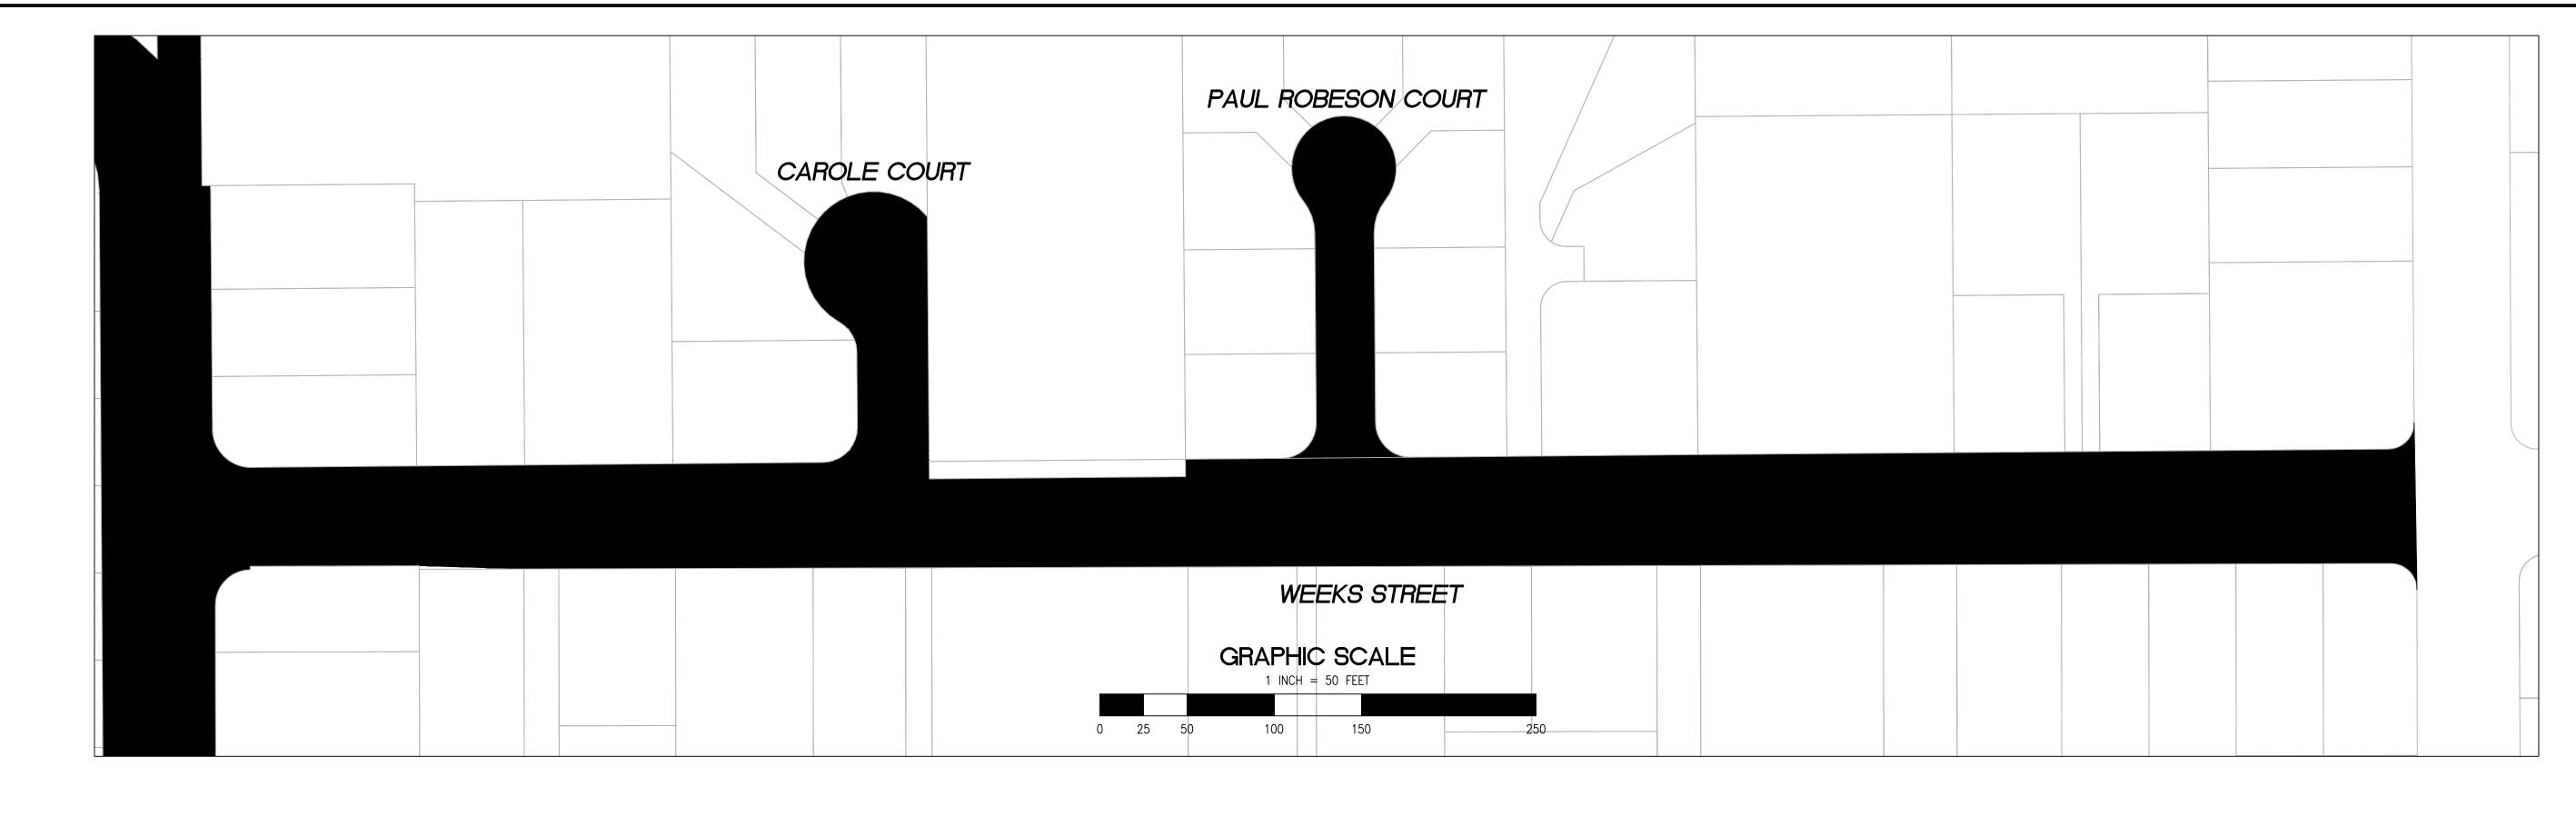
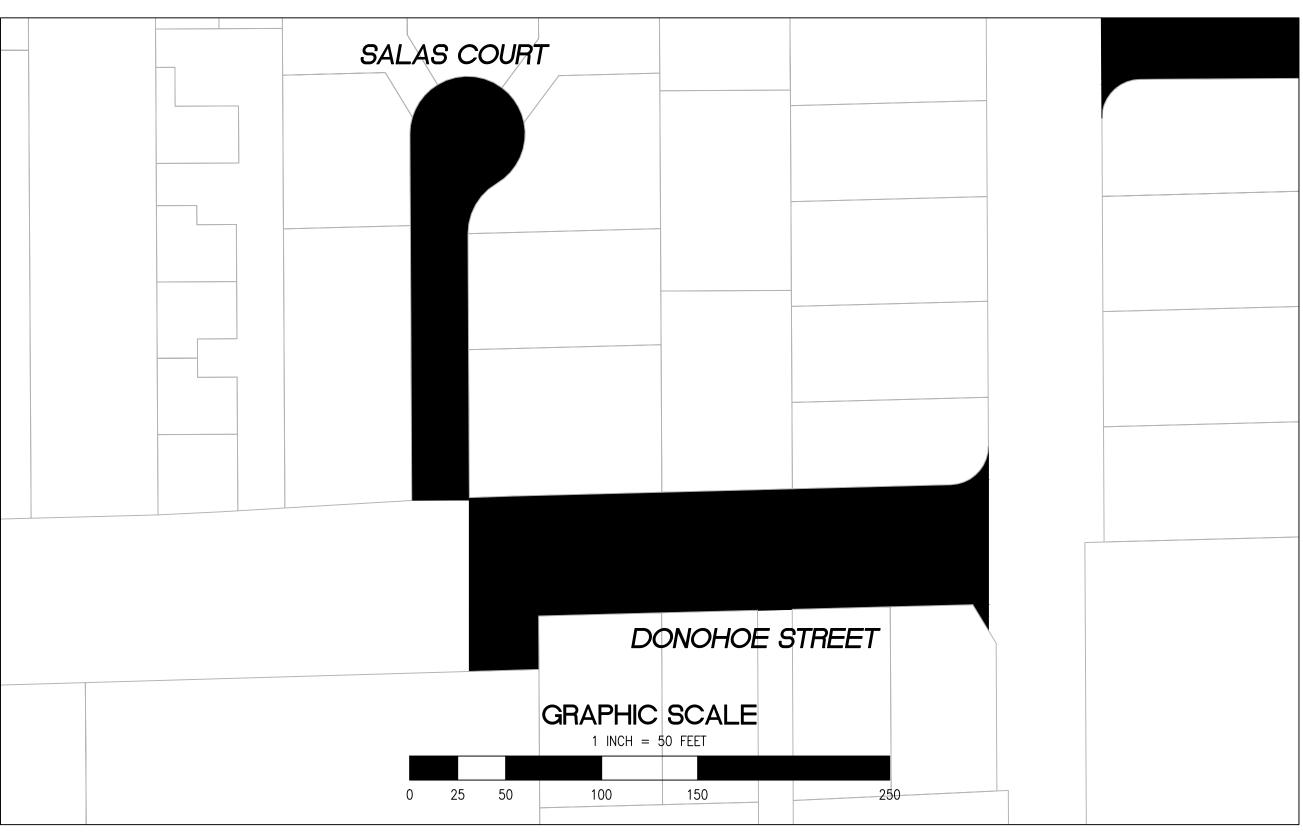
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RELATIVE BORDER SCALE IS IN INCHES

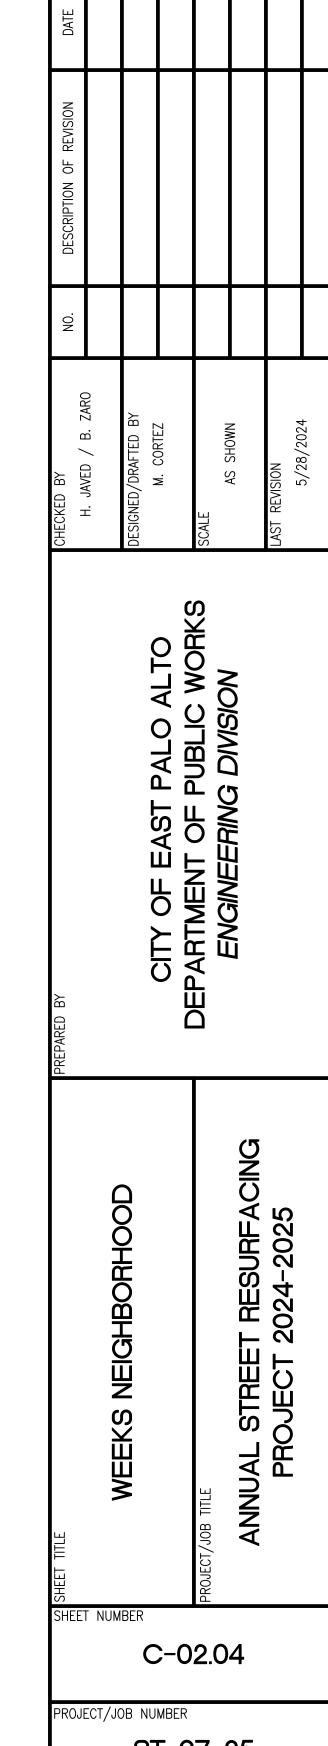

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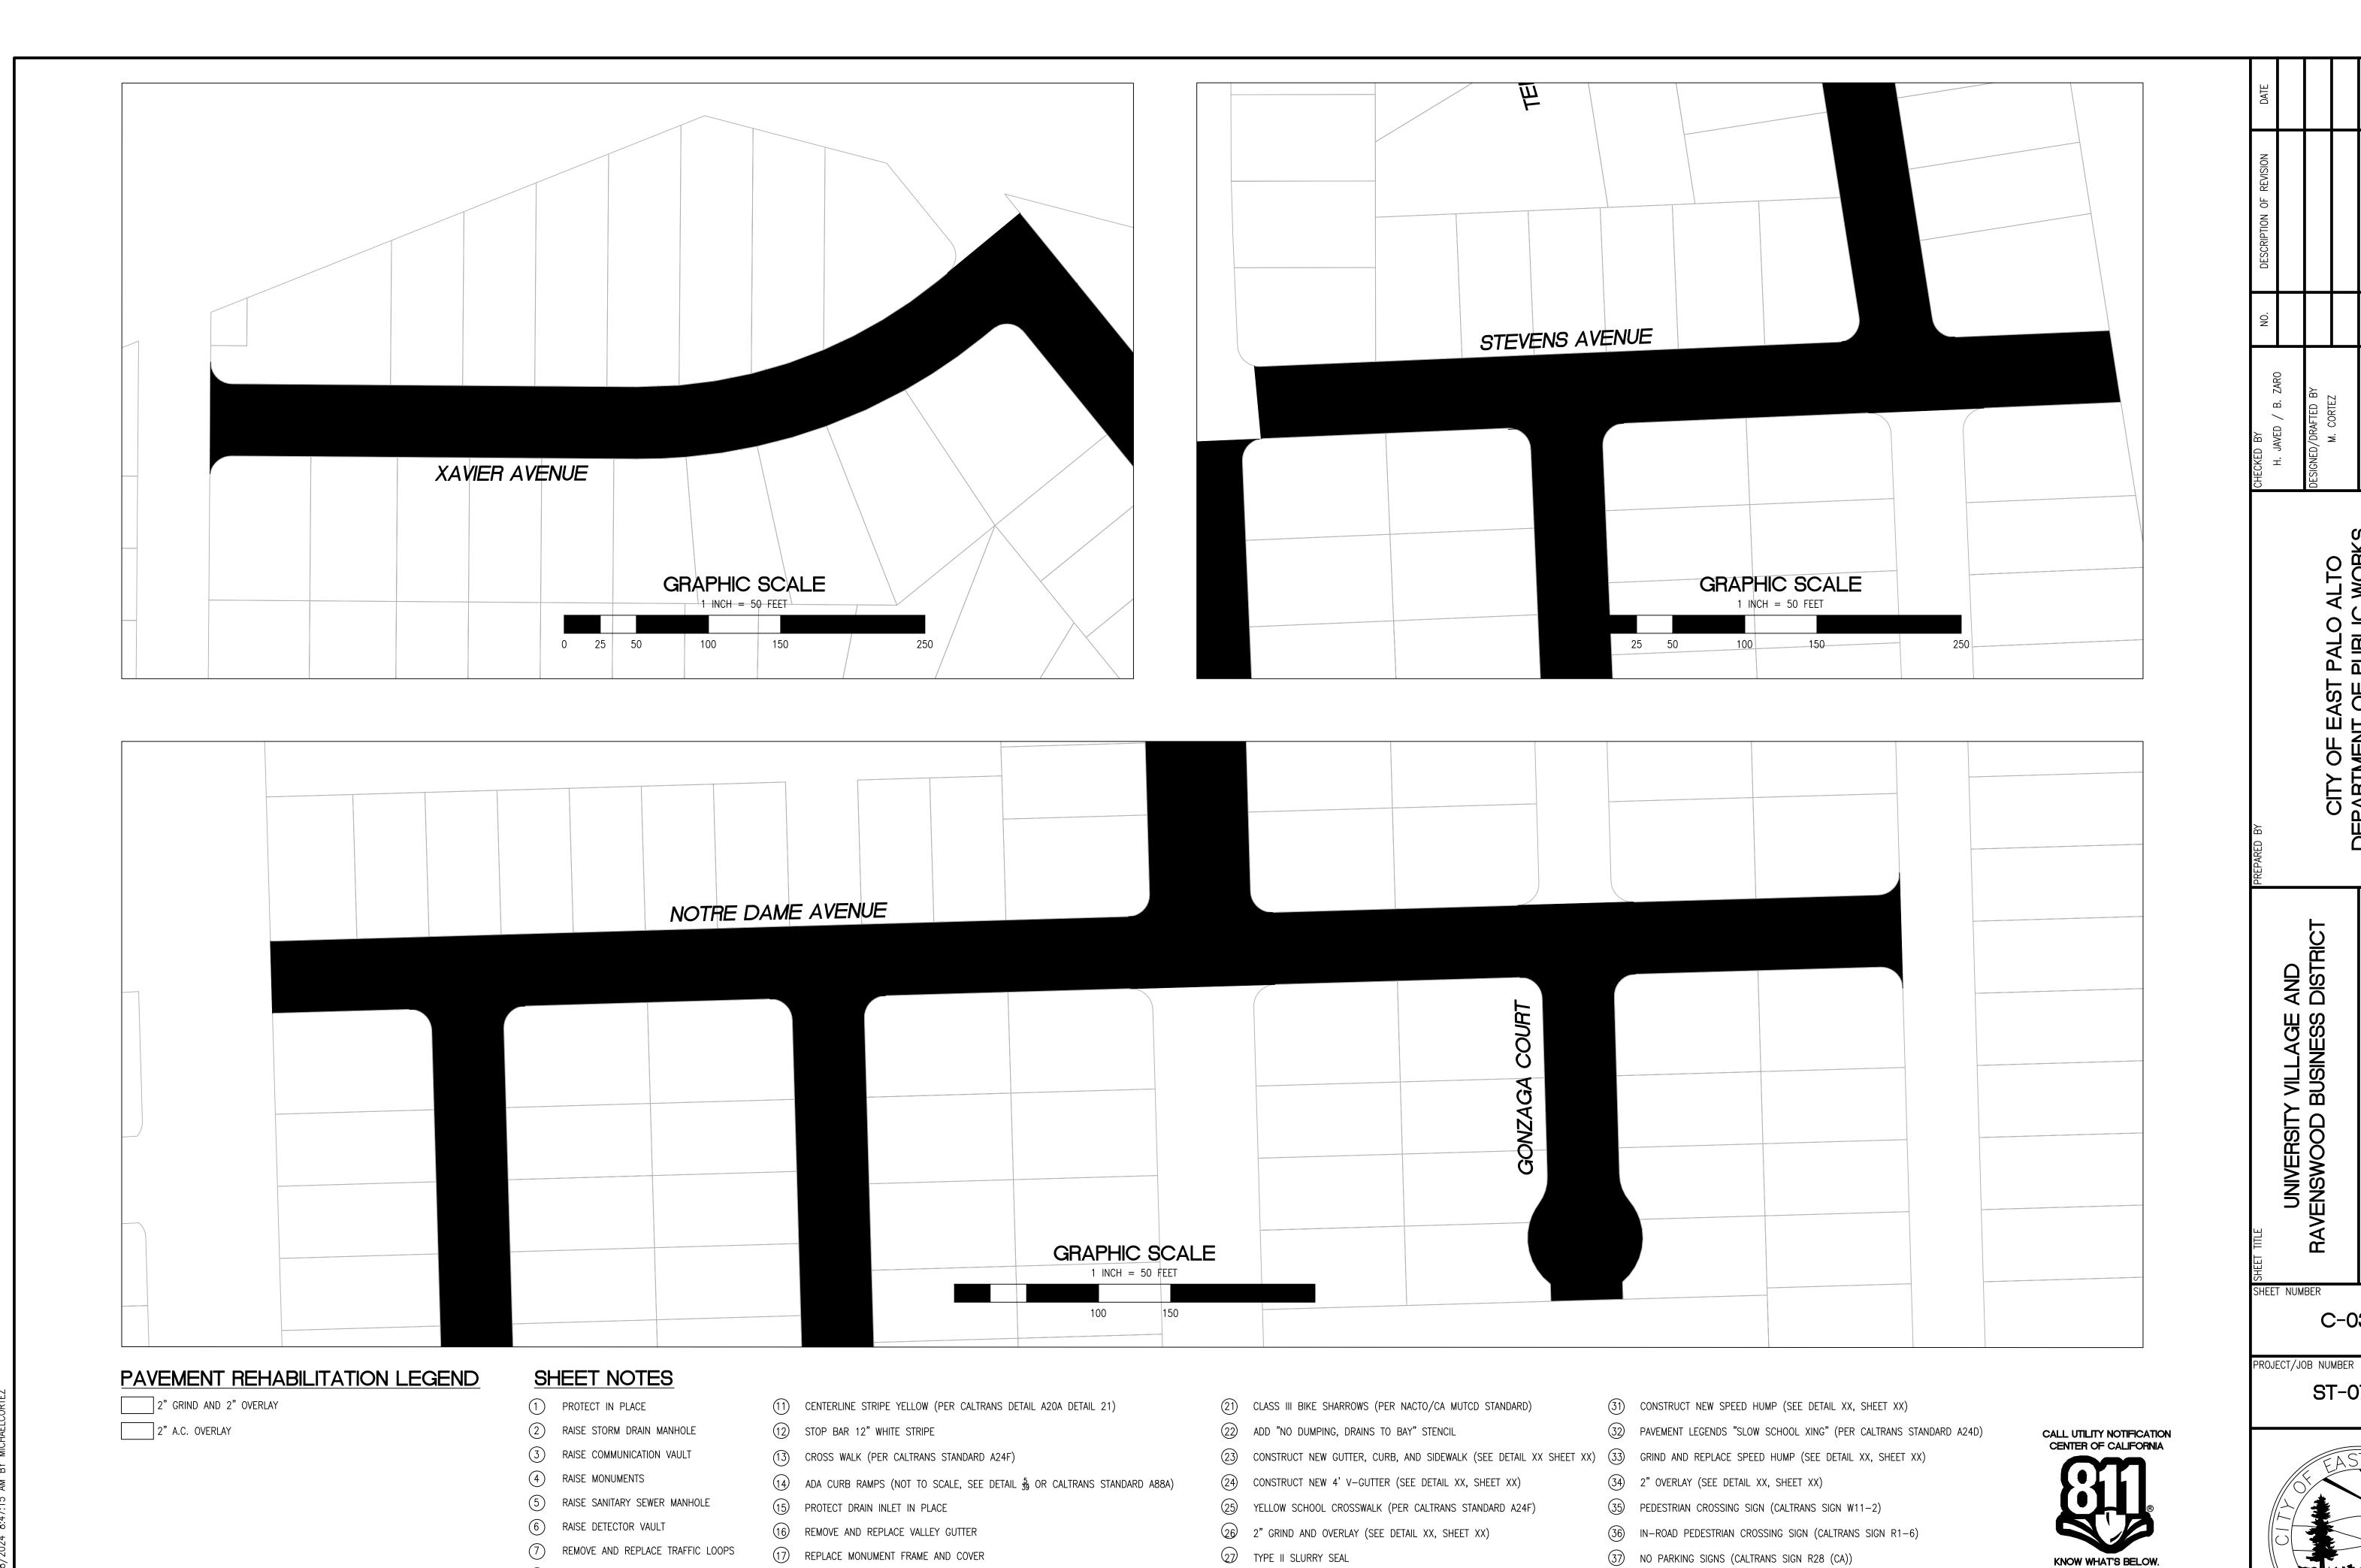
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10 PAVEMENT LEGENDS "STOP" / "BUMP"

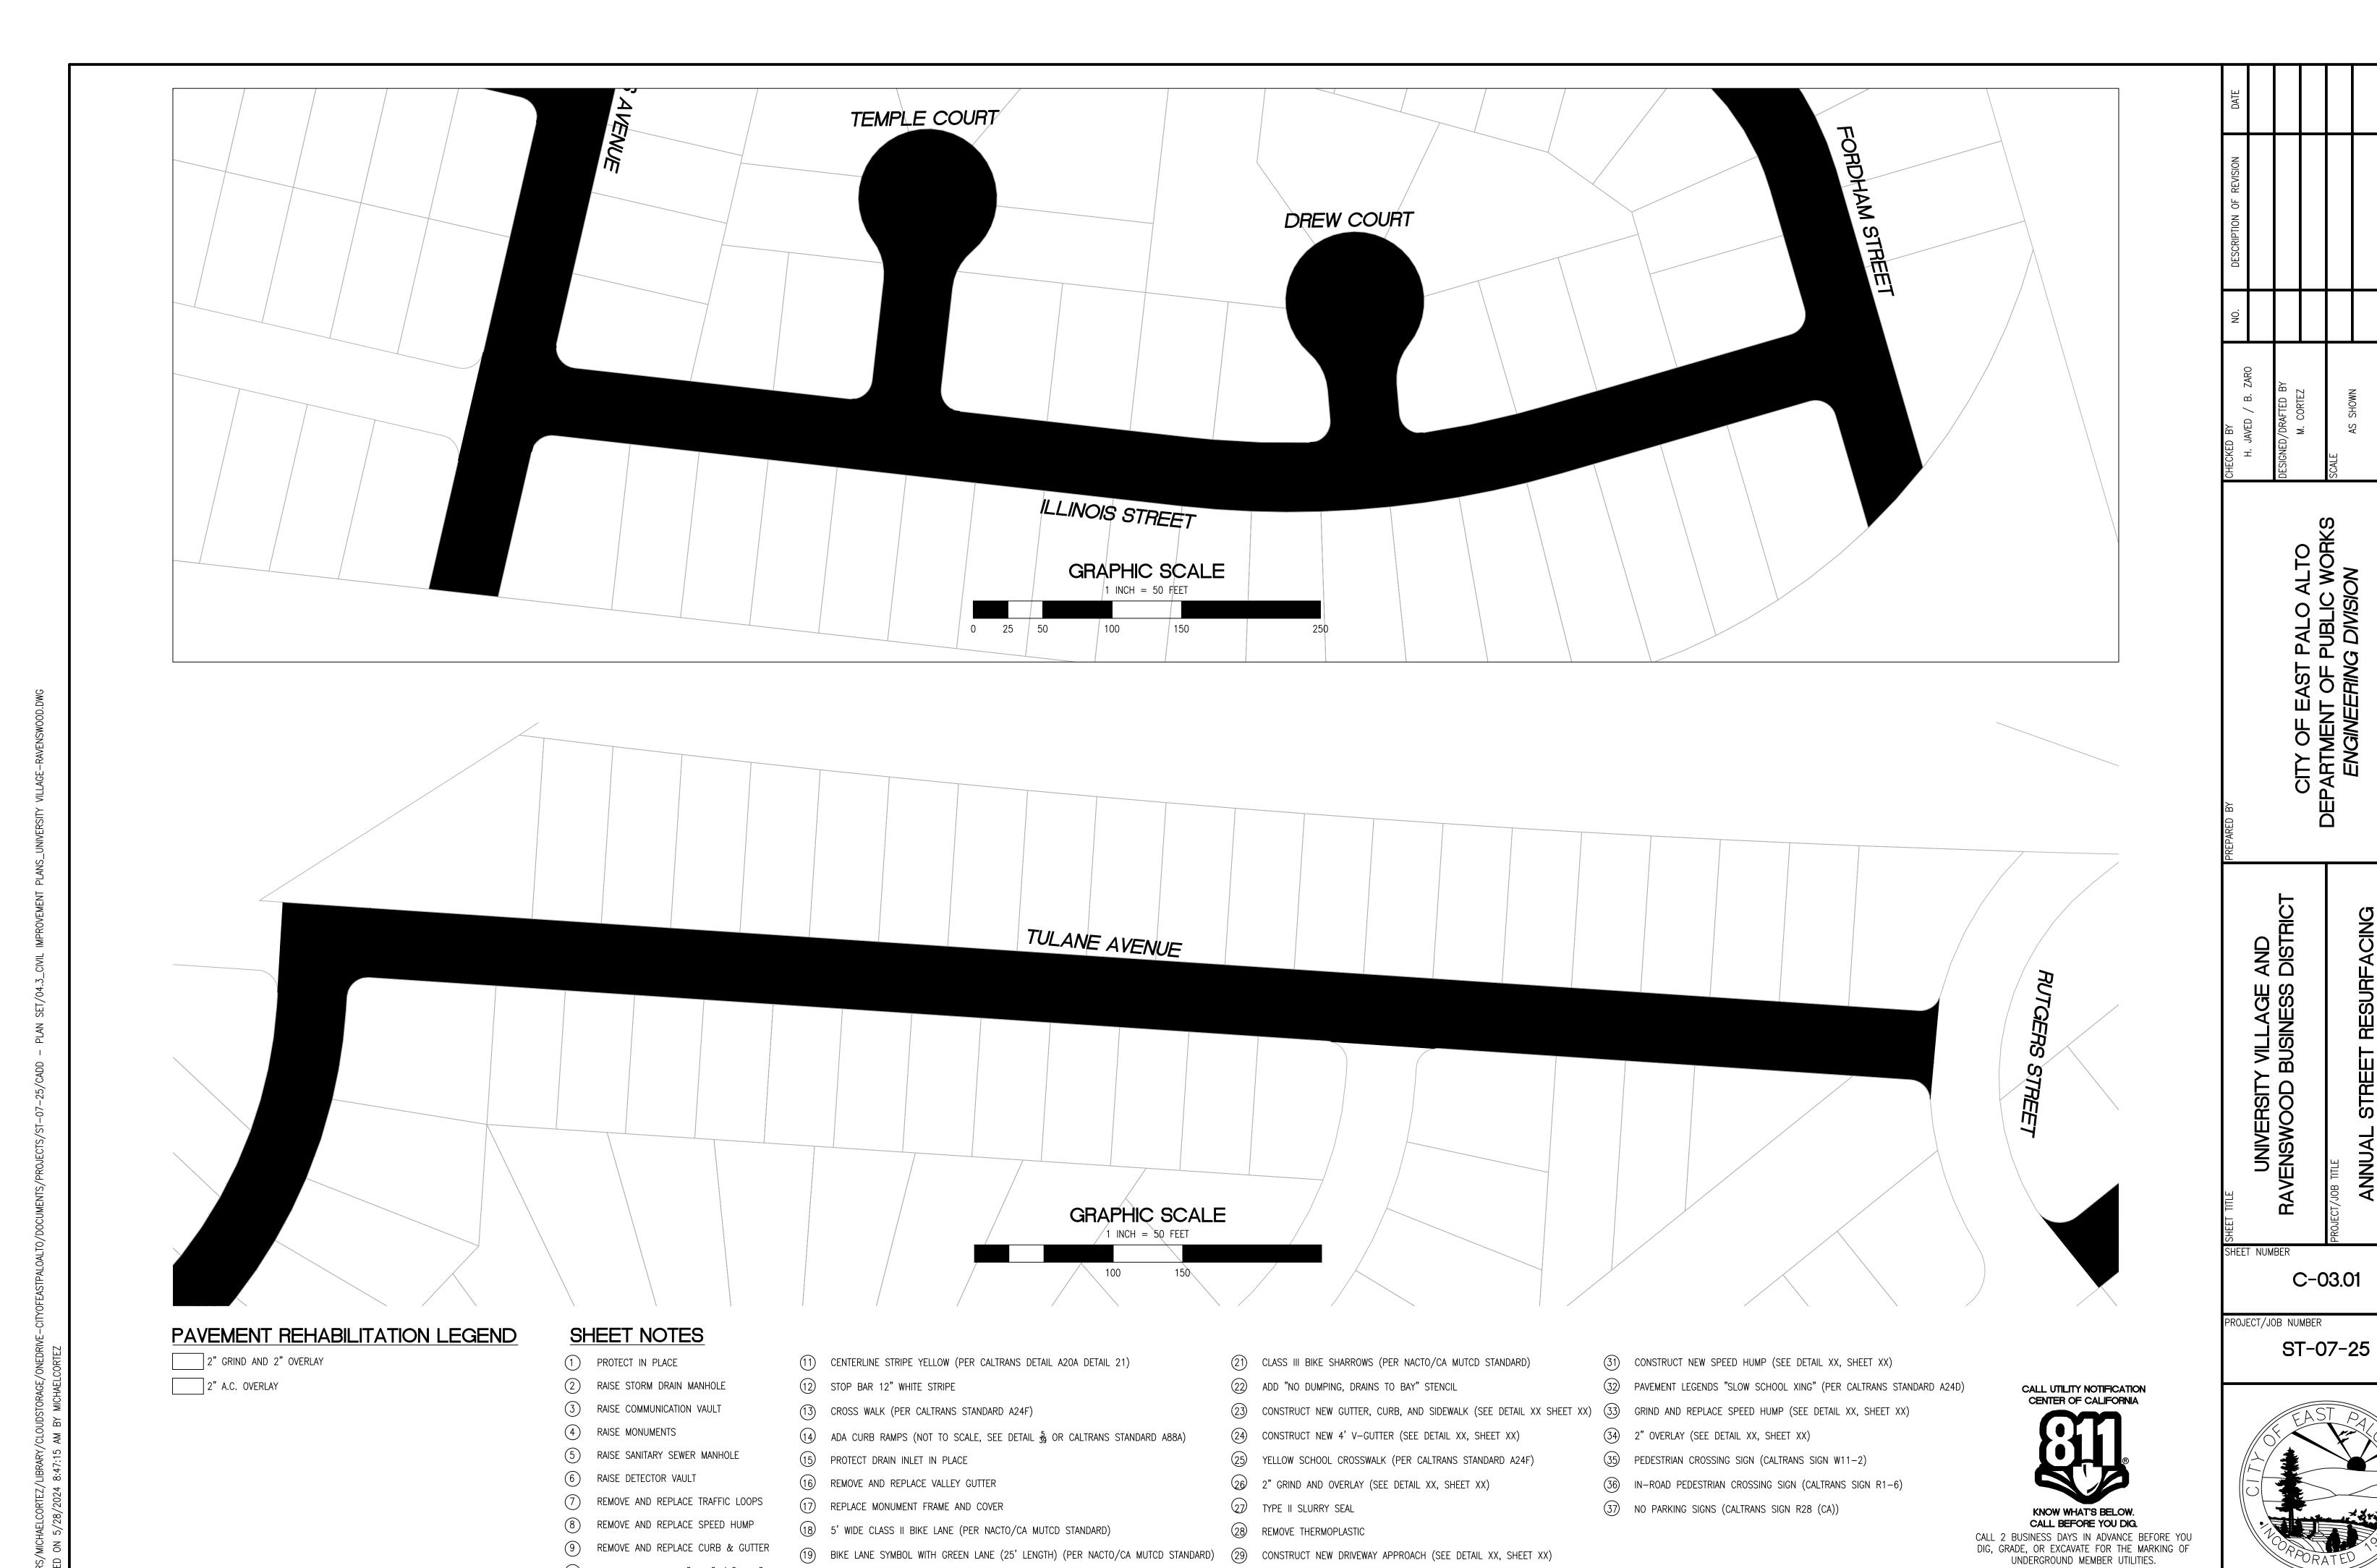

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30 CONSTRUCT NEW 2" MIN. A.C. OVER COMPACTED SUBBASE (2% SLOPE)

C-03.02

ST-07-25

KNOW WHAT'S BELOW. CALL BEFORE YOU DIG.

CALL 2 BUSINESS DAYS IN ADVANCE BEFORE YOU DIG, GRADE, OR EXCAVATE FOR THE MARKING OF UNDERGROUND MEMBER UTILITIES.

NOTE: IF THIS LINE DOES NOT MEASURE 1 INCH, THESE PLANS ARE NOT TO SCALE.


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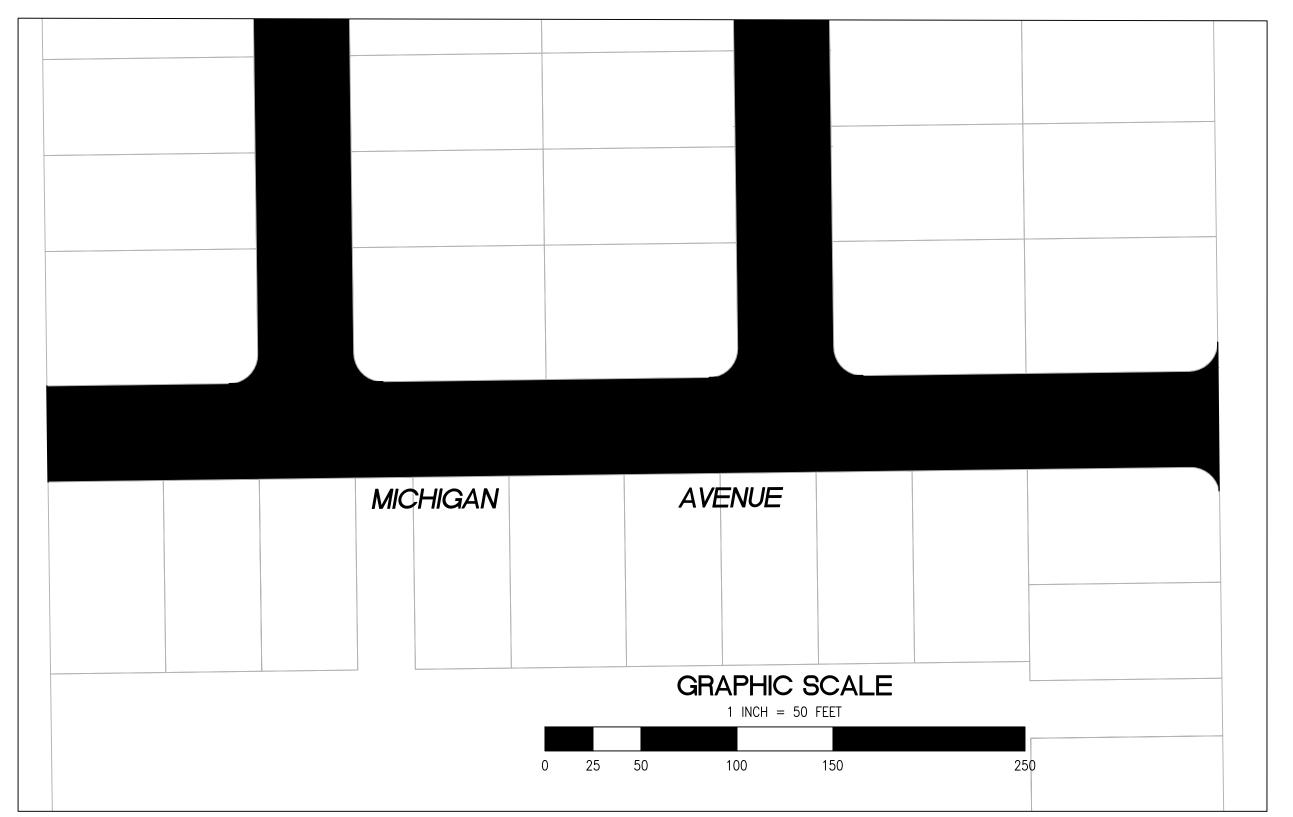
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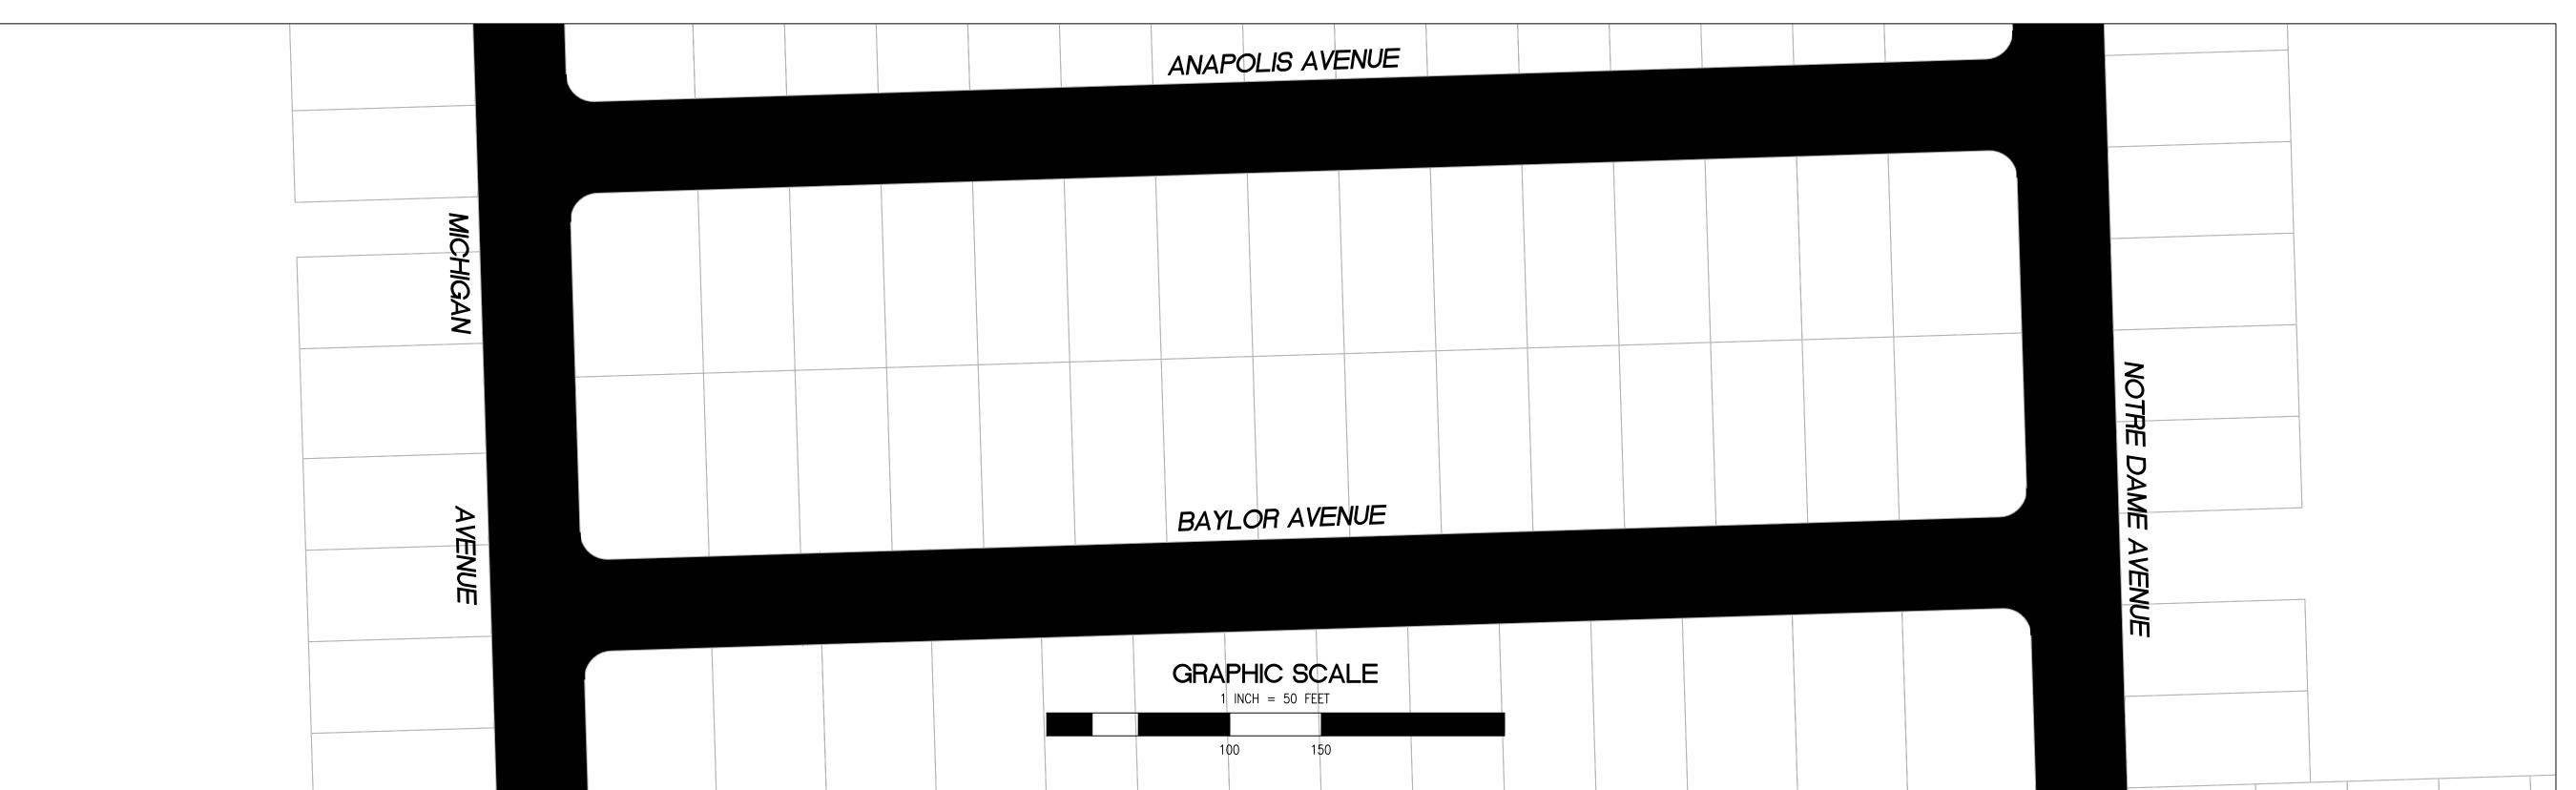
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2" GRIND AND 2" OVERLAY


2" A.C. OVERLAY


- SHEET NOTES
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- 27 TYPE II SLURRY SEAL 28) REMOVE THERMOPLASTIC
- 30 CONSTRUCT NEW 2" MIN. A.C. OVER COMPACTED SUBBASE (2% SLOPE)

- (31) CONSTRUCT NEW SPEED HUMP (SEE DETAIL XX, SHEET XX)
- 32) PAVEMENT LEGENDS "SLOW SCHOOL XING" (PER CALTRANS STANDARD A24D) (23) CONSTRUCT NEW GUTTER, CURB, AND SIDEWALK (SEE DETAIL XX SHEET XX) (33) GRIND AND REPLACE SPEED HUMP (SEE DETAIL XX, SHEET XX)
 - 34) 2" OVERLAY (SEE DETAIL XX, SHEET XX)
 - 35) PEDESTRIAN CROSSING SIGN (CALTRANS SIGN W11-2)
 - (36) IN-ROAD PEDESTRIAN CROSSING SIGN (CALTRANS SIGN R1-6)
 - 37) NO PARKING SIGNS (CALTRANS SIGN R28 (CA))



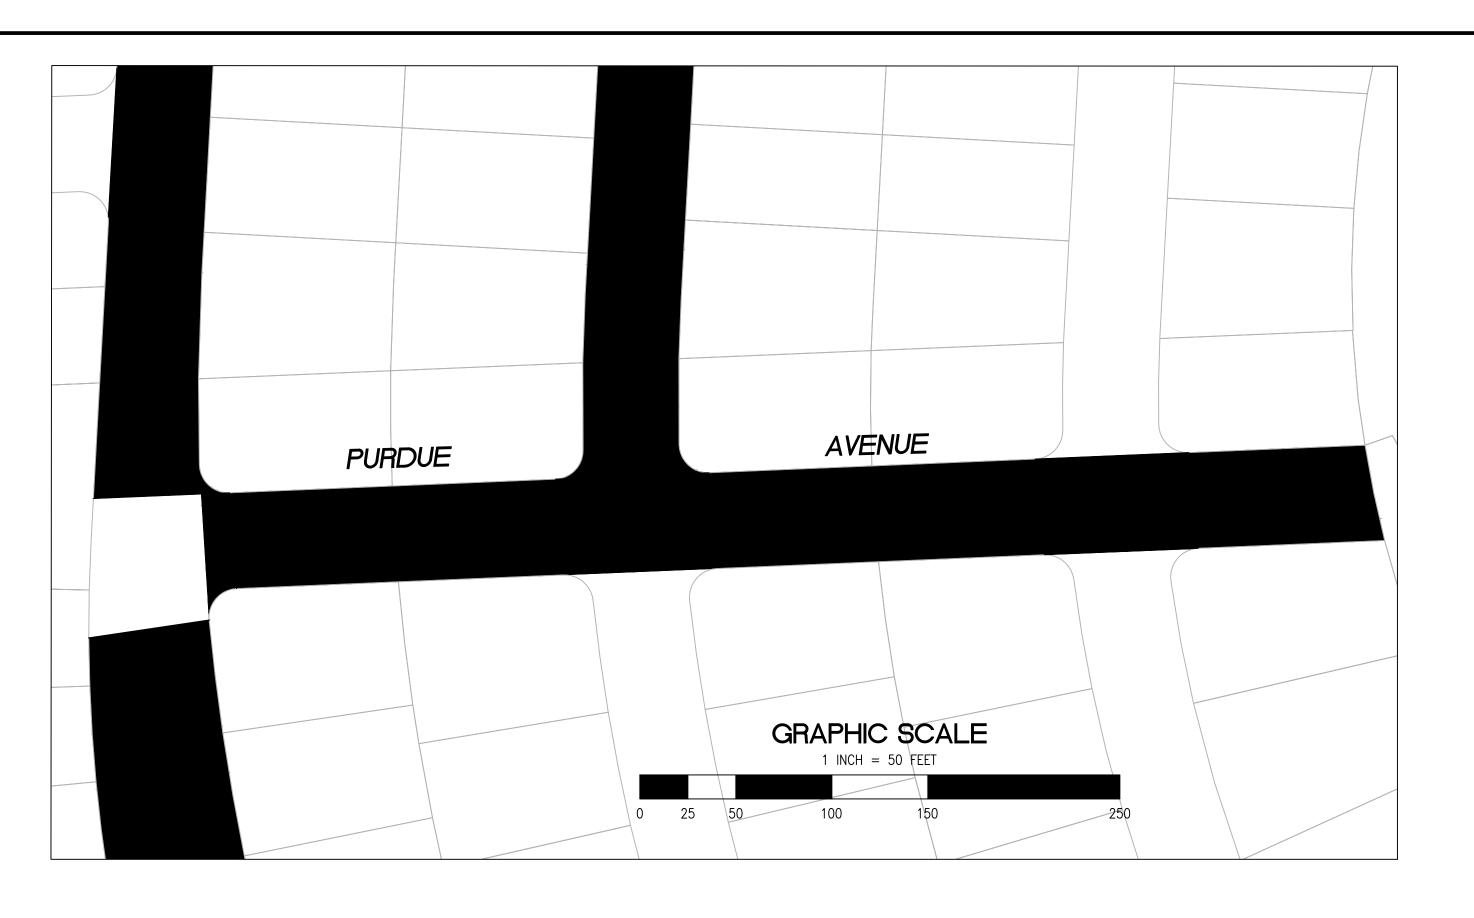


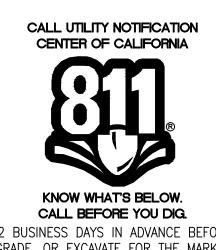C-03.03

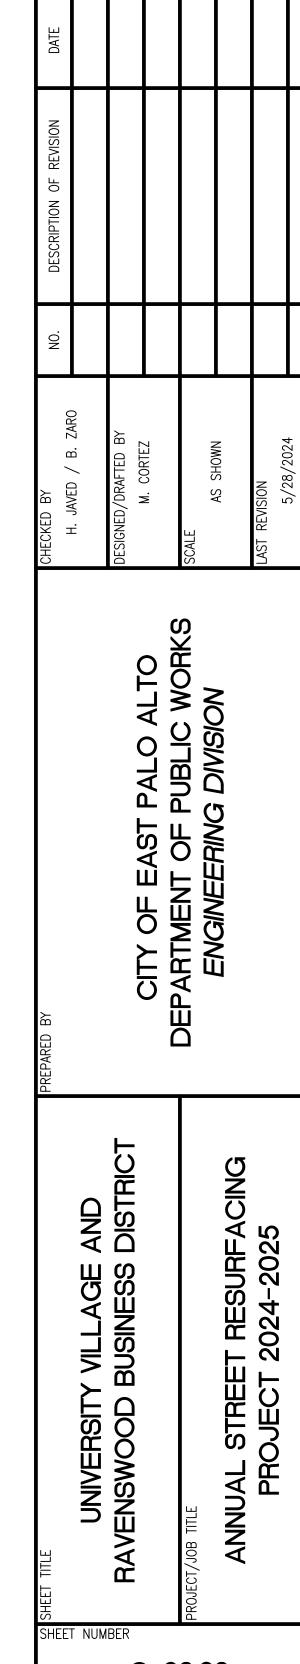PROJECT/JOB NUMBER

ST-07-25

CALL 2 BUSINESS DAYS IN ADVANCE BEFORE YOU DIG, GRADE, OR EXCAVATE FOR THE MARKING OF UNDERGROUND MEMBER UTILITIES.

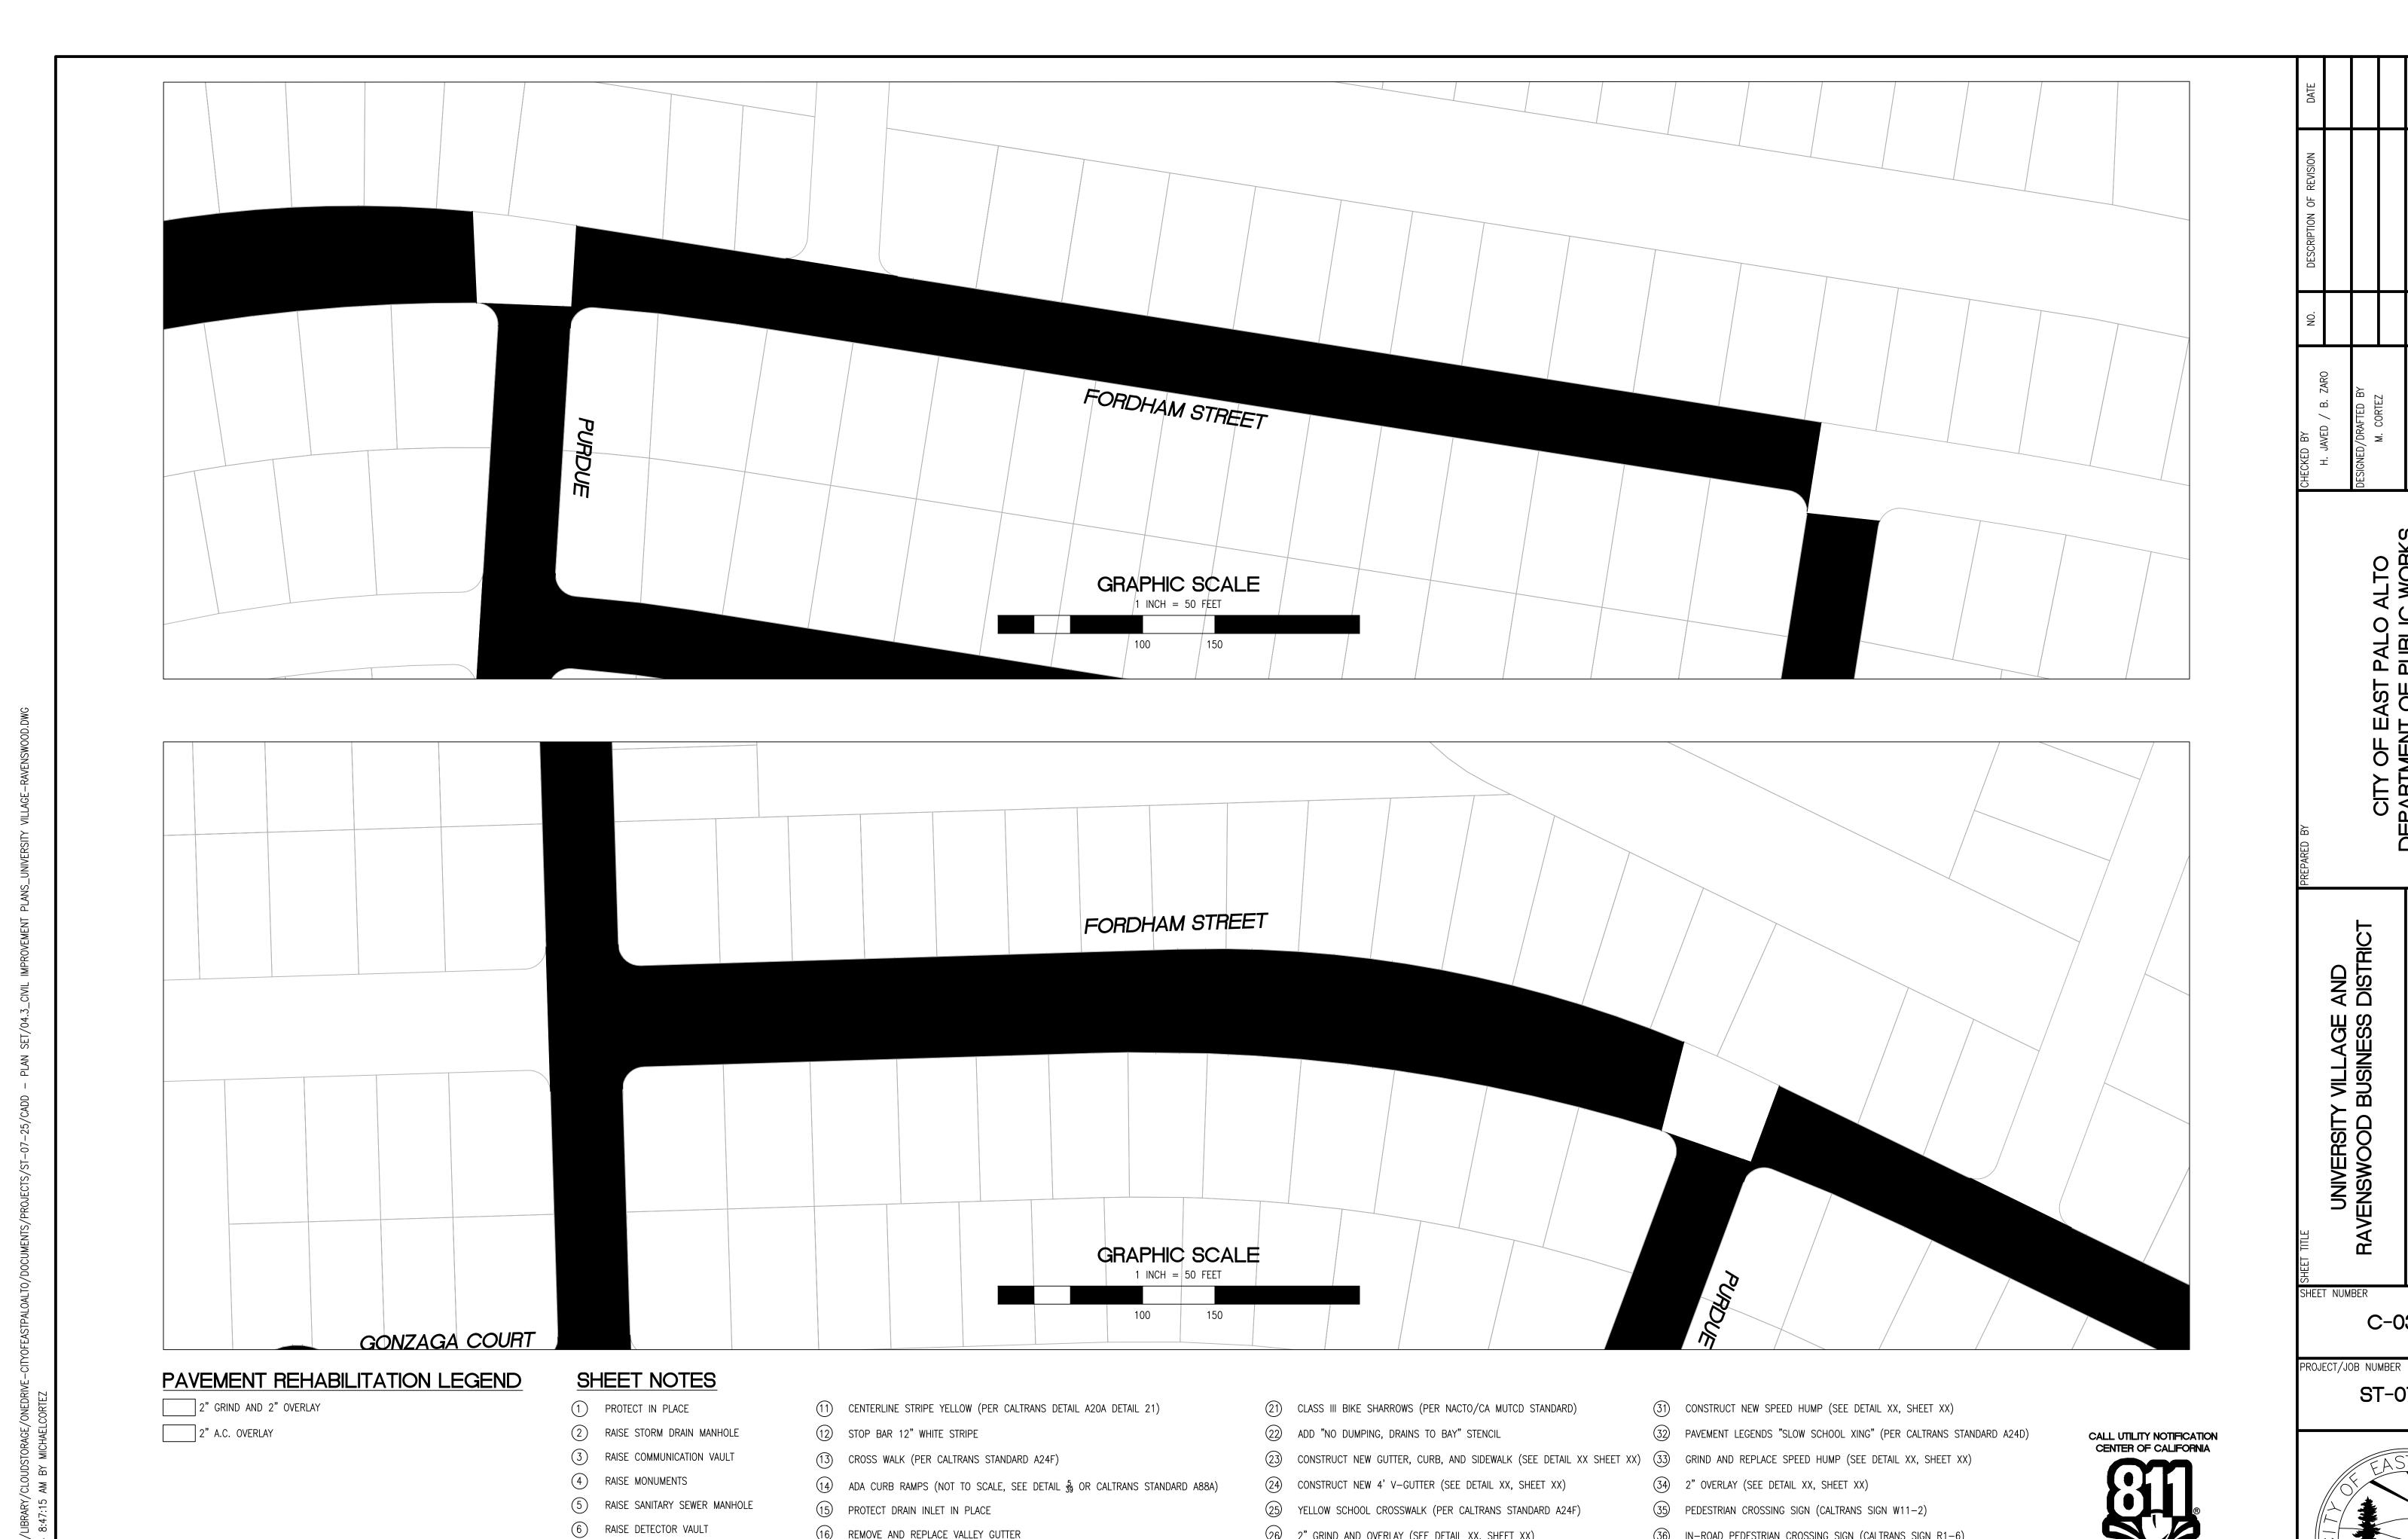

20 BIKE LANE DASHED GREEN LANE (PER NACTO/CA MUTCD STANDARD) 30 CONSTRUCT NEW 2" MIN. A.C. OVER COMPACTED SUBBASE (2% SLOPE) RELATIVE BORDER SCALE IS IN INCHES 0 0.5 1.0 NOTE: IF THIS LINE DOES NOT MEASURE 1 INCH, THESE PLANS ARE NOT TO SCALE.

19 BIKE LANE SYMBOL WITH GREEN LANE (25' LENGTH) (PER NACTO/CA MUTCD STANDARD) 29 CONSTRUCT NEW DRIVEWAY APPROACH (SEE DETAIL XX, SHEET XX)

26 2" GRIND AND OVERLAY (SEE DETAIL XX, SHEET XX)

27 TYPE II SLURRY SEAL

28) REMOVE THERMOPLASTIC

(36) IN-ROAD PEDESTRIAN CROSSING SIGN (CALTRANS SIGN R1-6)

37) NO PARKING SIGNS (CALTRANS SIGN R28 (CA))

16 REMOVE AND REPLACE VALLEY GUTTER

17 REPLACE MONUMENT FRAME AND COVER

18) 5' WIDE CLASS II BIKE LANE (PER NACTO/CA MUTCD STANDARD)

7 REMOVE AND REPLACE TRAFFIC LOOPS

9 REMOVE AND REPLACE CURB & GUTTER

10 PAVEMENT LEGENDS "STOP" / "BUMP"


8 REMOVE AND REPLACE SPEED HUMP

C-03.04

ST-07-25

KNOW WHAT'S BELOW. CALL BEFORE YOU DIG.

CALL 2 BUSINESS DAYS IN ADVANCE BEFORE YOU DIG, GRADE, OR EXCAVATE FOR THE MARKING OF UNDERGROUND MEMBER UTILITIES.

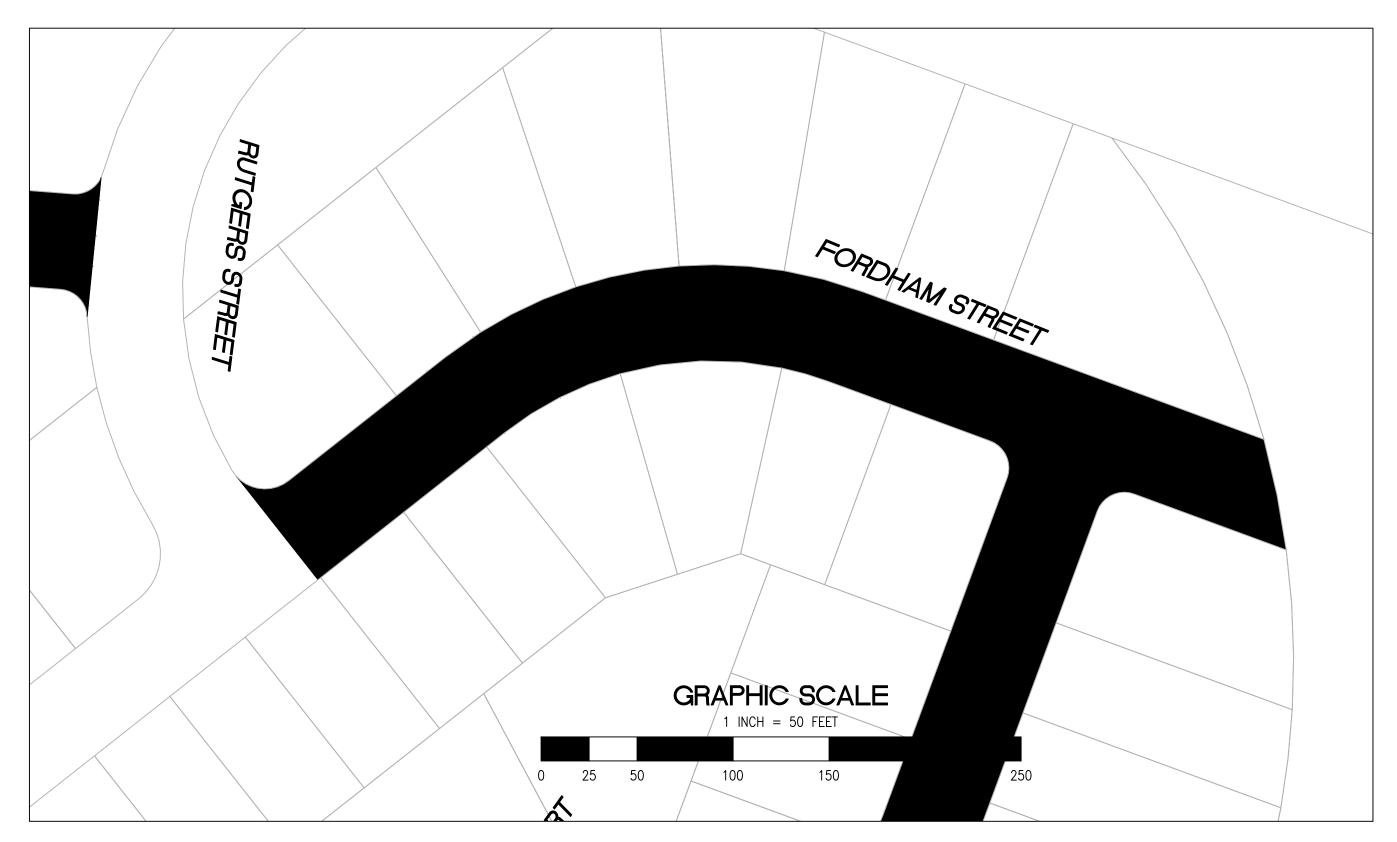



2" GRIND AND 2" OVERLAY

2" A.C. OVERLAY


SHEET NOTES

- 1) PROTECT IN PLACE
- 2 RAISE STORM DRAIN MANHOLE
- 3 RAISE COMMUNICATION VAULT
- 4 RAISE MONUMENTS
- 5 RAISE SANITARY SEWER MANHOLE
- 6 RAISE DETECTOR VAULT
- 7 REMOVE AND REPLACE TRAFFIC LOOPS 8 REMOVE AND REPLACE SPEED HUMP
- 9 REMOVE AND REPLACE CURB & GUTTER
- 10 PAVEMENT LEGENDS "STOP" / "BUMP"

- (11) CENTERLINE STRIPE YELLOW (PER CALTRANS DETAIL A20A DETAIL 21)
- 12) STOP BAR 12" WHITE STRIPE
- (13) CROSS WALK (PER CALTRANS STANDARD A24F)
- 14 ADA CURB RAMPS (NOT TO SCALE, SEE DETAIL $\frac{5}{39}$ OR CALTRANS STANDARD A88A)
- 15 PROTECT DRAIN INLET IN PLACE
- 16 REMOVE AND REPLACE VALLEY GUTTER
- 17) REPLACE MONUMENT FRAME AND COVER
- 18) 5' WIDE CLASS II BIKE LANE (PER NACTO/CA MUTCD STANDARD)
- 20 BIKE LANE DASHED GREEN LANE (PER NACTO/CA MUTCD STANDARD)

- (21) CLASS III BIKE SHARROWS (PER NACTO/CA MUTCD STANDARD)
- 22 ADD "NO DUMPING, DRAINS TO BAY" STENCIL
- (24) CONSTRUCT NEW 4' V-GUTTER (SEE DETAIL XX, SHEET XX)
- 25) YELLOW SCHOOL CROSSWALK (PER CALTRANS STANDARD A24F)
- 2° GRIND AND OVERLAY (SEE DETAIL XX, SHEET XX)
- 27) TYPE II SLURRY SEAL
- 28) REMOVE THERMOPLASTIC
- 19 BIKE LANE SYMBOL WITH GREEN LANE (25' LENGTH) (PER NACTO/CA MUTCD STANDARD) (29 CONSTRUCT NEW DRIVEWAY APPROACH (SEE DETAIL XX, SHEET XX)
 - 30 CONSTRUCT NEW 2" MIN. A.C. OVER COMPACTED SUBBASE (2% SLOPE)

- (31) CONSTRUCT NEW SPEED HUMP (SEE DETAIL XX, SHEET XX)
- 32) PAVEMENT LEGENDS "SLOW SCHOOL XING" (PER CALTRANS STANDARD A24D) (23) CONSTRUCT NEW GUTTER, CURB, AND SIDEWALK (SEE DETAIL XX SHEET XX) (33) GRIND AND REPLACE SPEED HUMP (SEE DETAIL XX, SHEET XX)
 - 34) 2" OVERLAY (SEE DETAIL XX, SHEET XX)
 - 35) PEDESTRIAN CROSSING SIGN (CALTRANS SIGN W11-2)
 - (36) IN-ROAD PEDESTRIAN CROSSING SIGN (CALTRANS SIGN R1-6)
 - 37) NO PARKING SIGNS (CALTRANS SIGN R28 (CA))

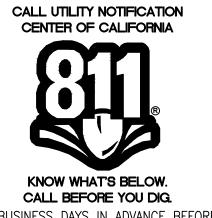


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UNIVERSITY VILLAGE RAVENSWOOD BUSINESS SHEET NUMBER C-03.05

PROJECT/JOB NUMBER

ST-07-25



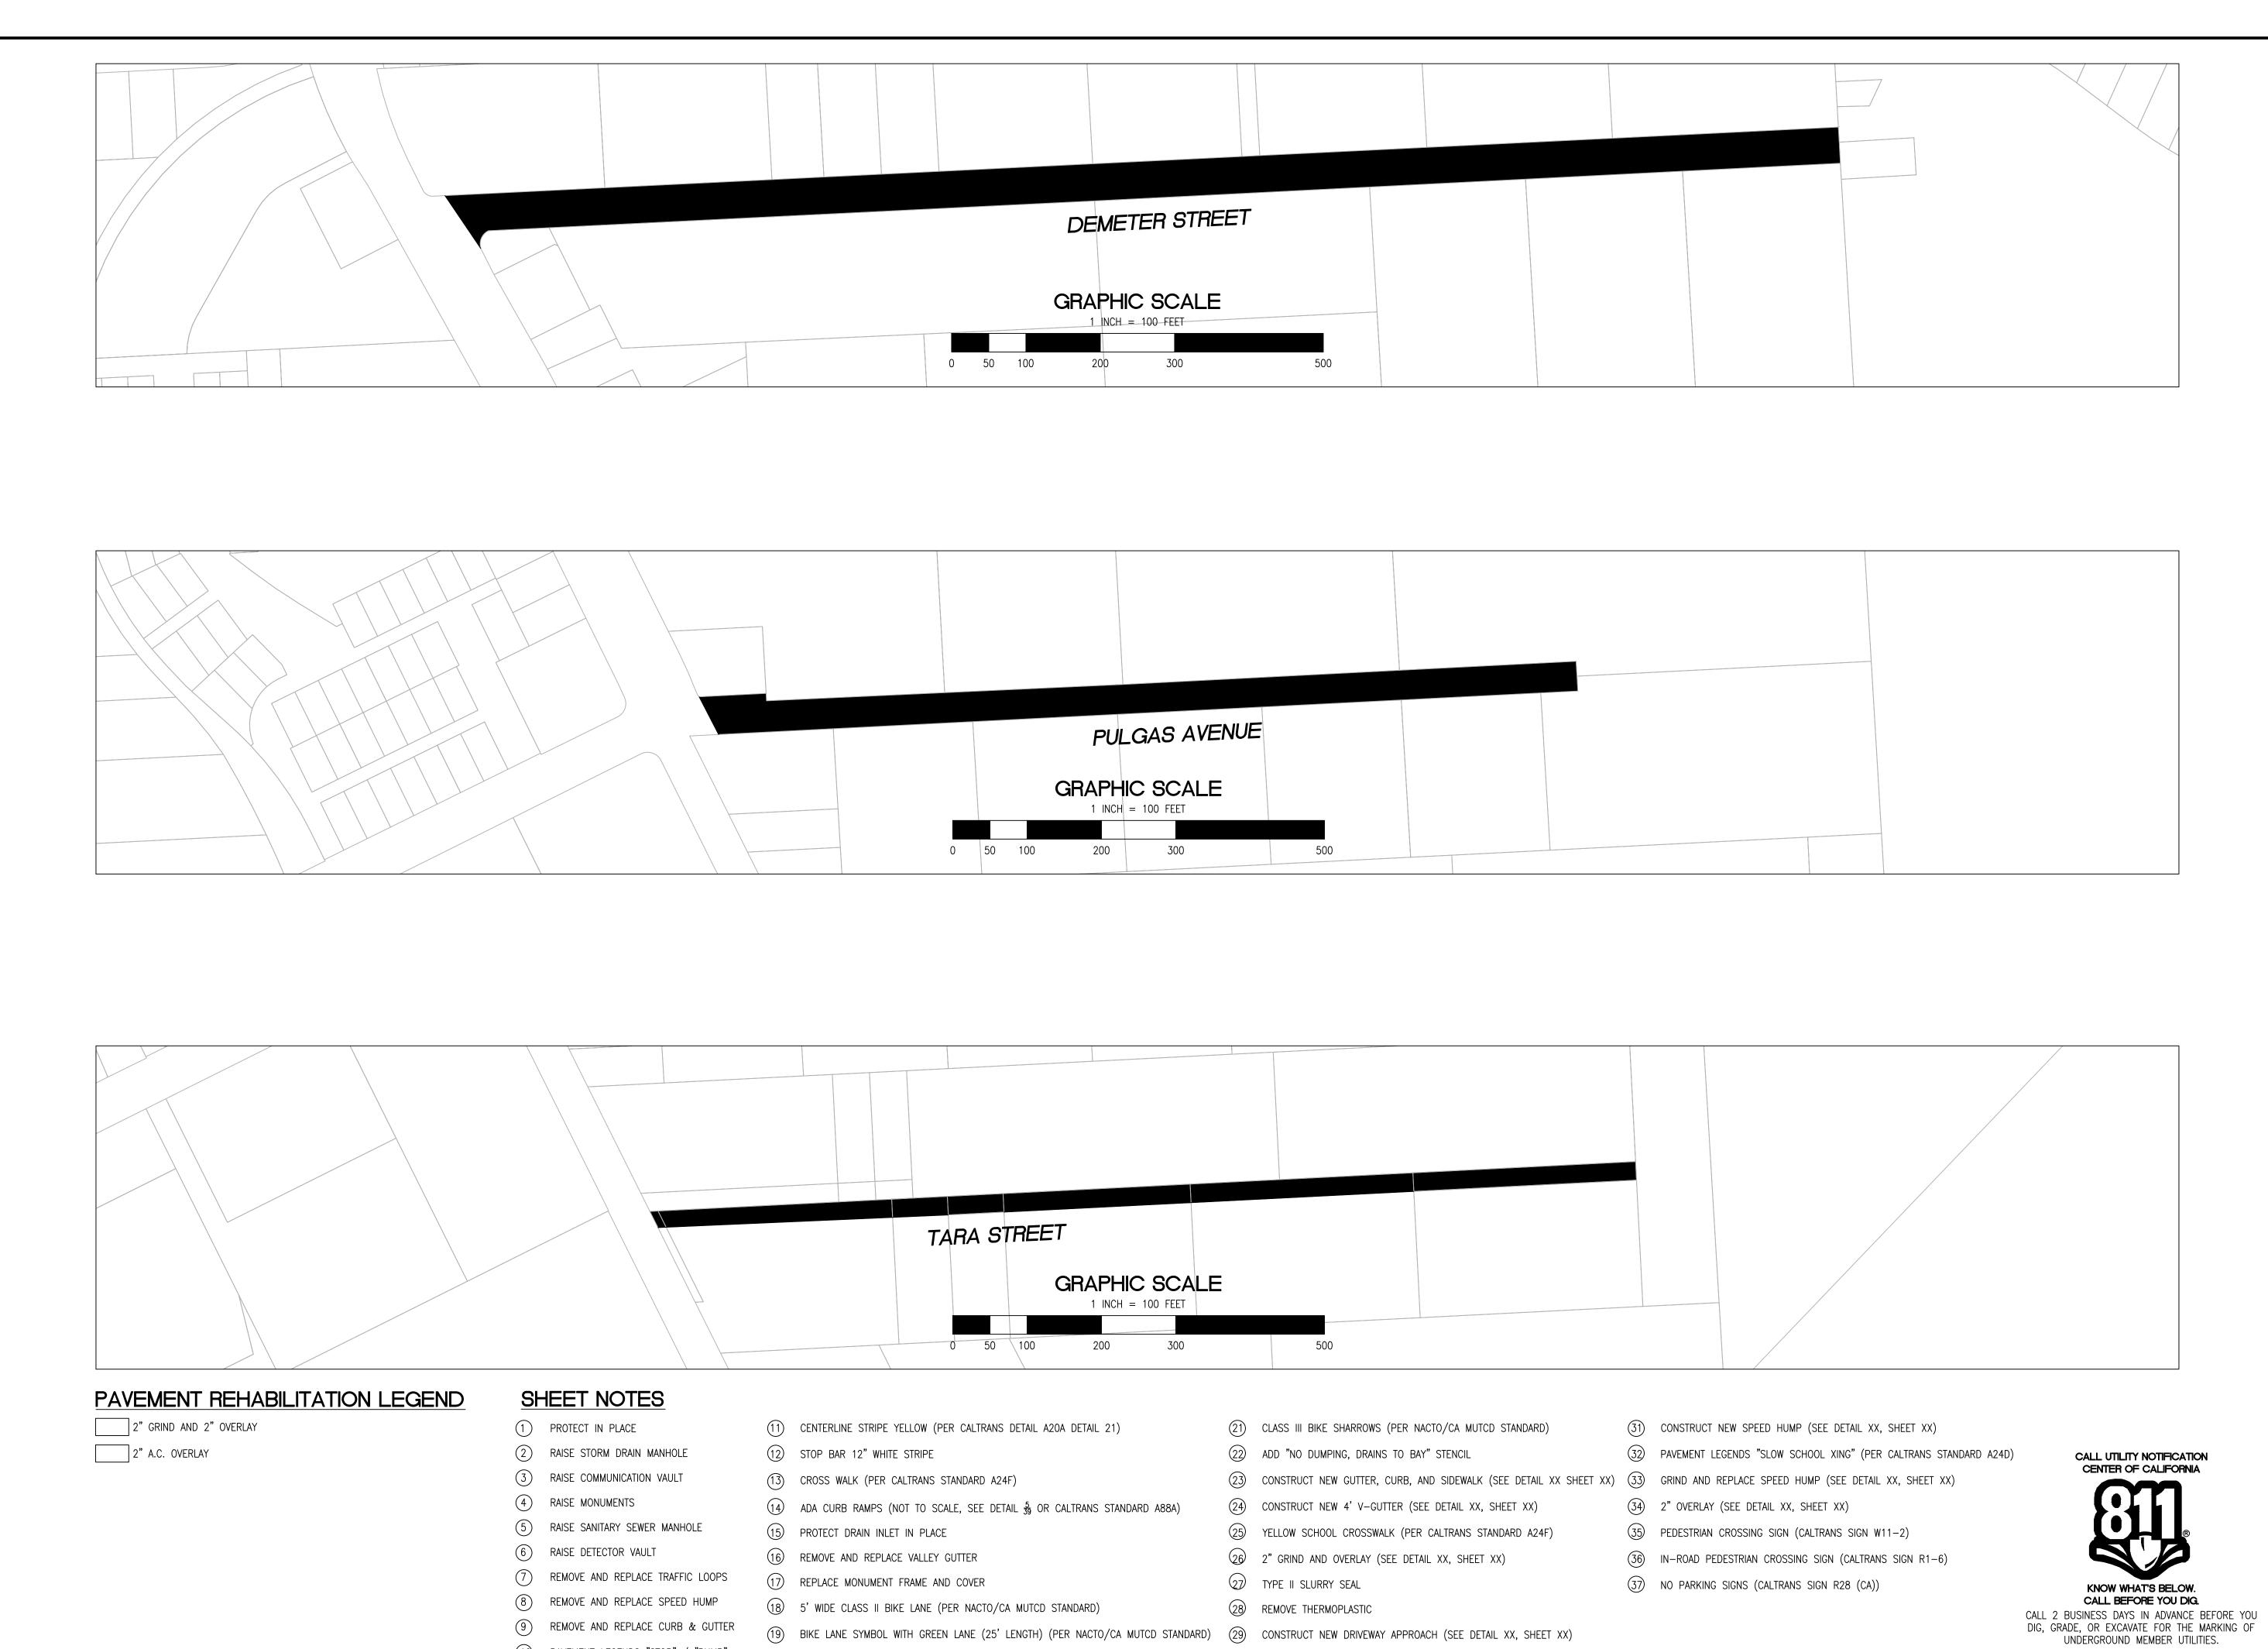

UNIVERSITY VILLAGE AND RAVENSWOOD BUSINESS DISTRIC

SHEET NUMBER

PROJECT/JOB NUMBER

C-03.06

ST-07-25


RELATIVE BORDER SCALE IS IN INCHES 0 0.5 1.0

20 BIKE LANE DASHED GREEN LANE (PER NACTO/CA MUTCD STANDARD)

10 PAVEMENT LEGENDS "STOP" / "BUMP"

19 BIKE LANE SYMBOL WITH GREEN LANE (25' LENGTH) (PER NACTO/CA MUTCD STANDARD) (29 CONSTRUCT NEW DRIVEWAY APPROACH (SEE DETAIL XX, SHEET XX)

30 CONSTRUCT NEW 2" MIN. A.C. OVER COMPACTED SUBBASE (2% SLOPE)

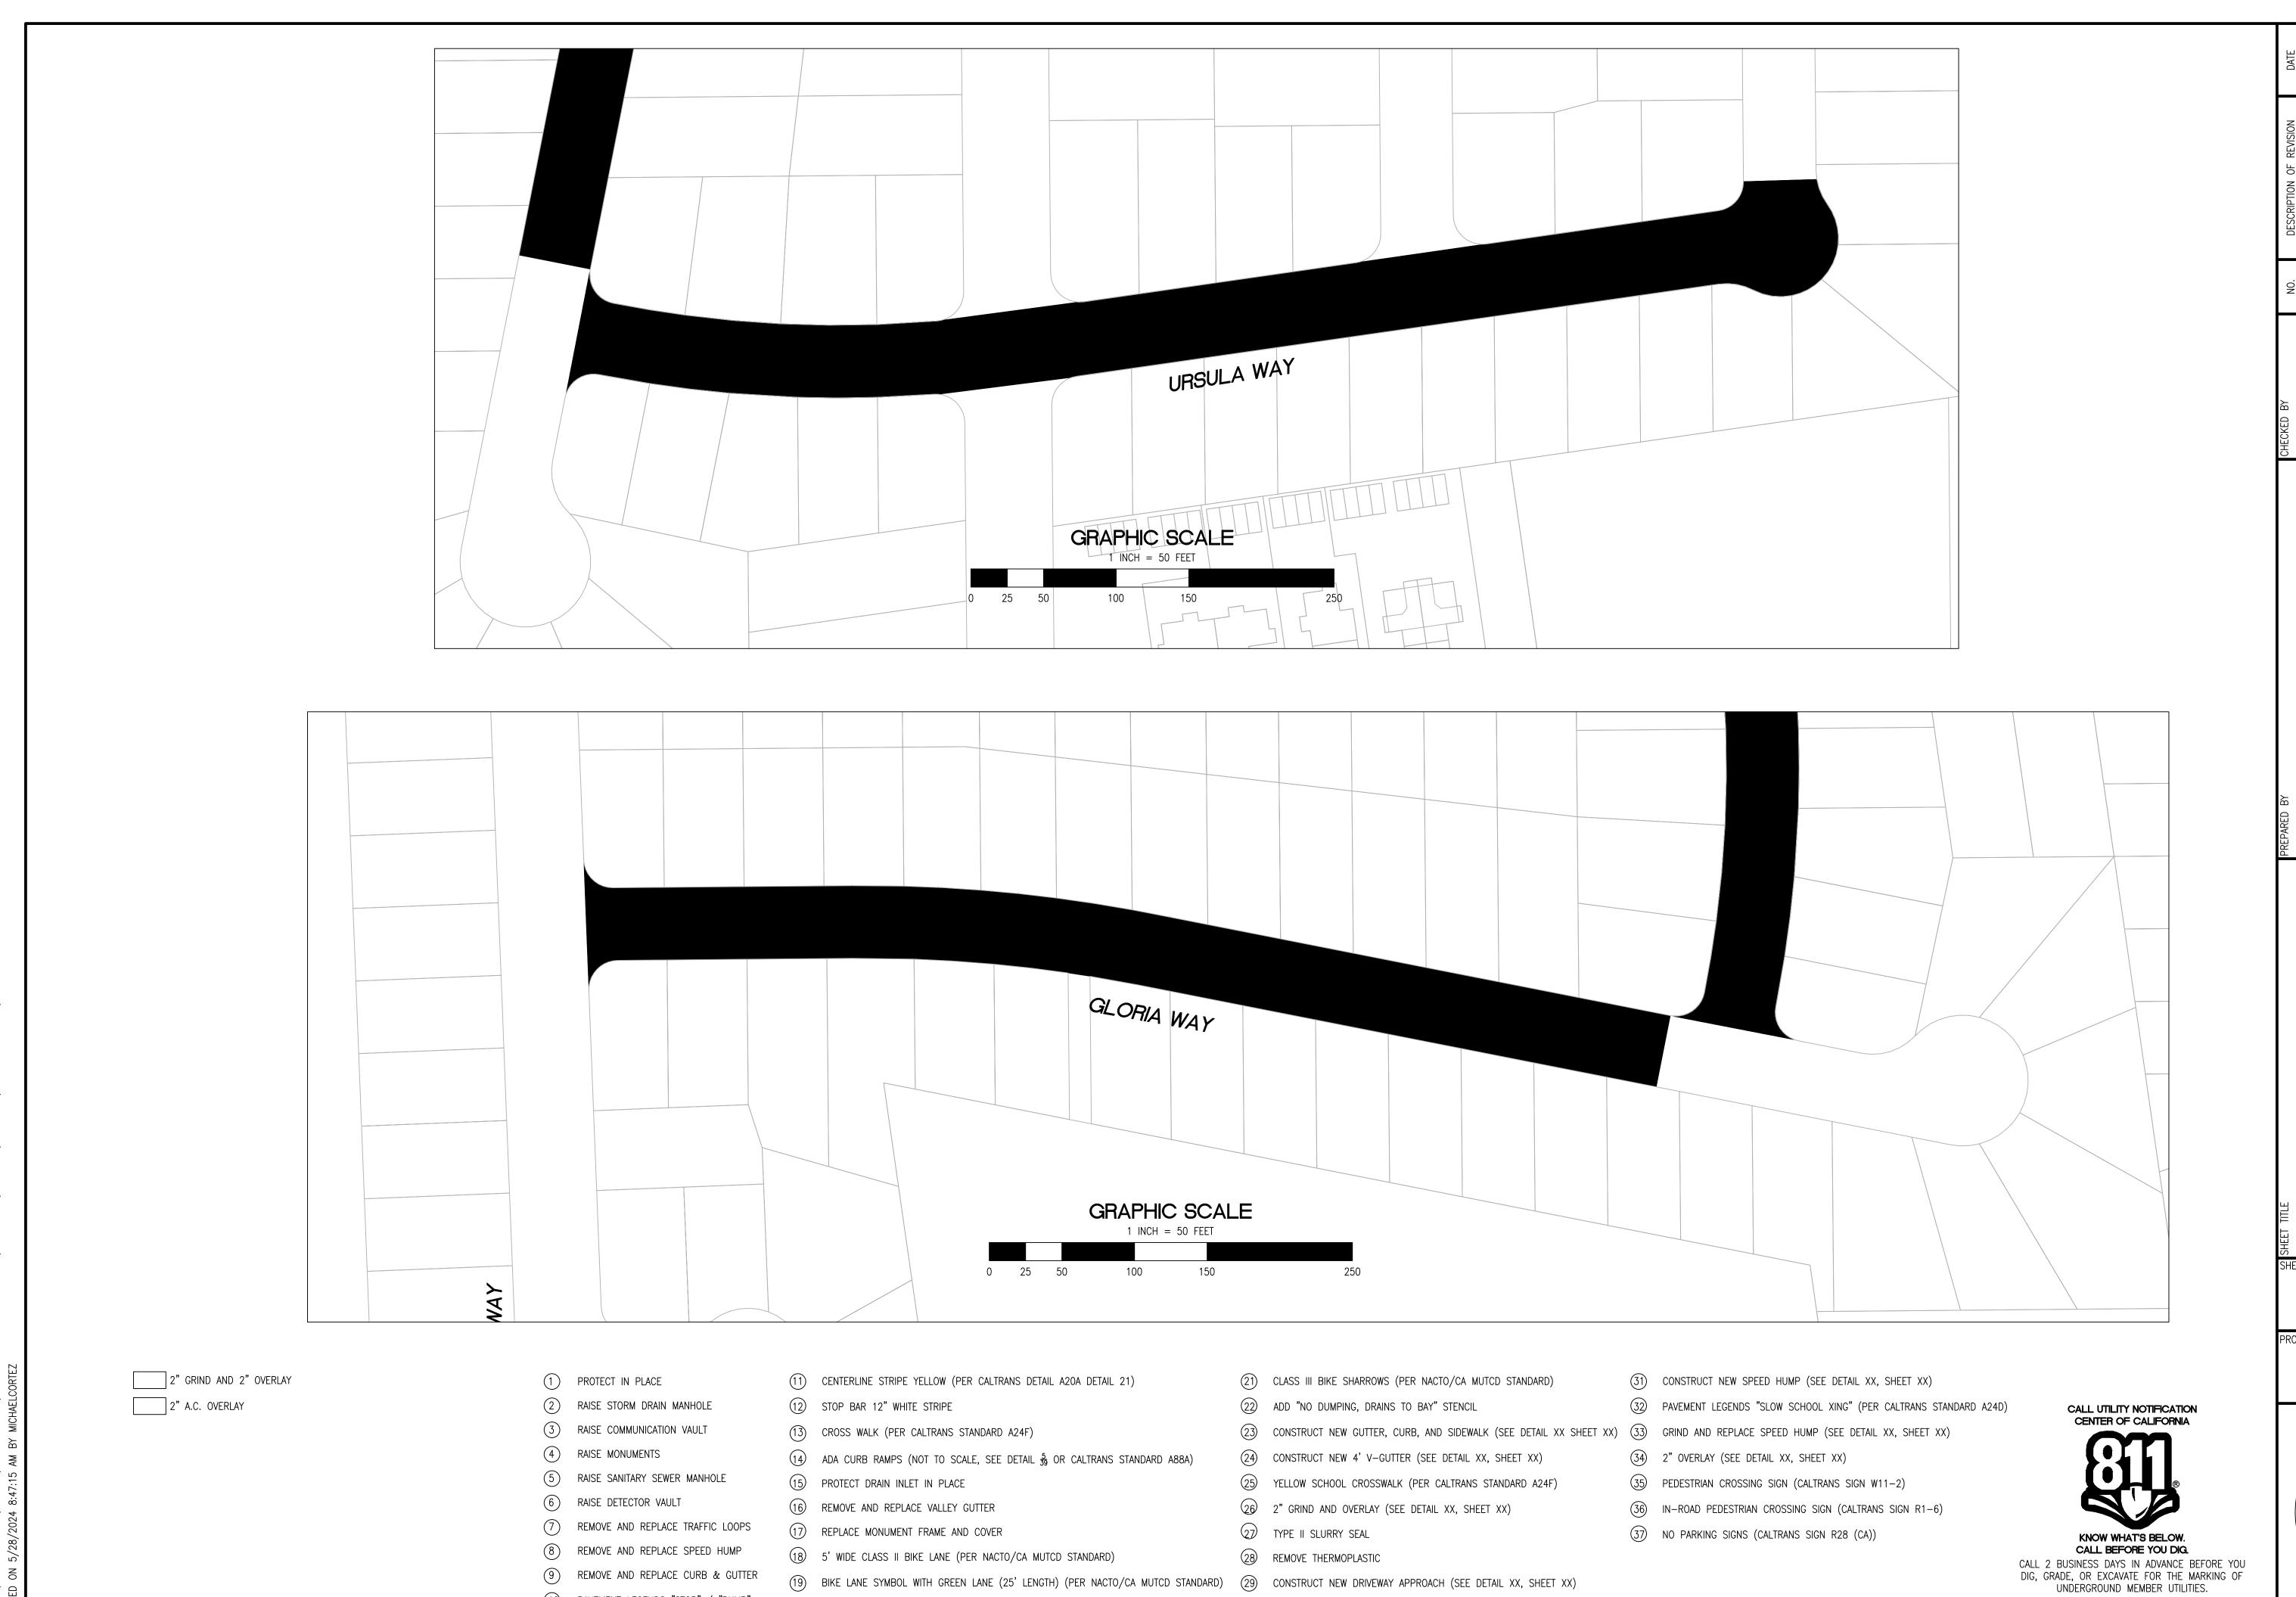

KAVANAUGH NEIGHBORHOOD SHEET NUMBER C-04.01 PROJECT/JOB NUMBER ST-07-25

RELATIVE BORDER SCALE IS IN INCHES 0 0.5 1.0


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20 BIKE LANE DASHED GREEN LANE (PER NACTO/CA MUTCD STANDARD)

9 REMOVE AND REPLACE CURB & GUTTER


10 PAVEMENT LEGENDS "STOP" / "BUMP"



0 0.5 1.0

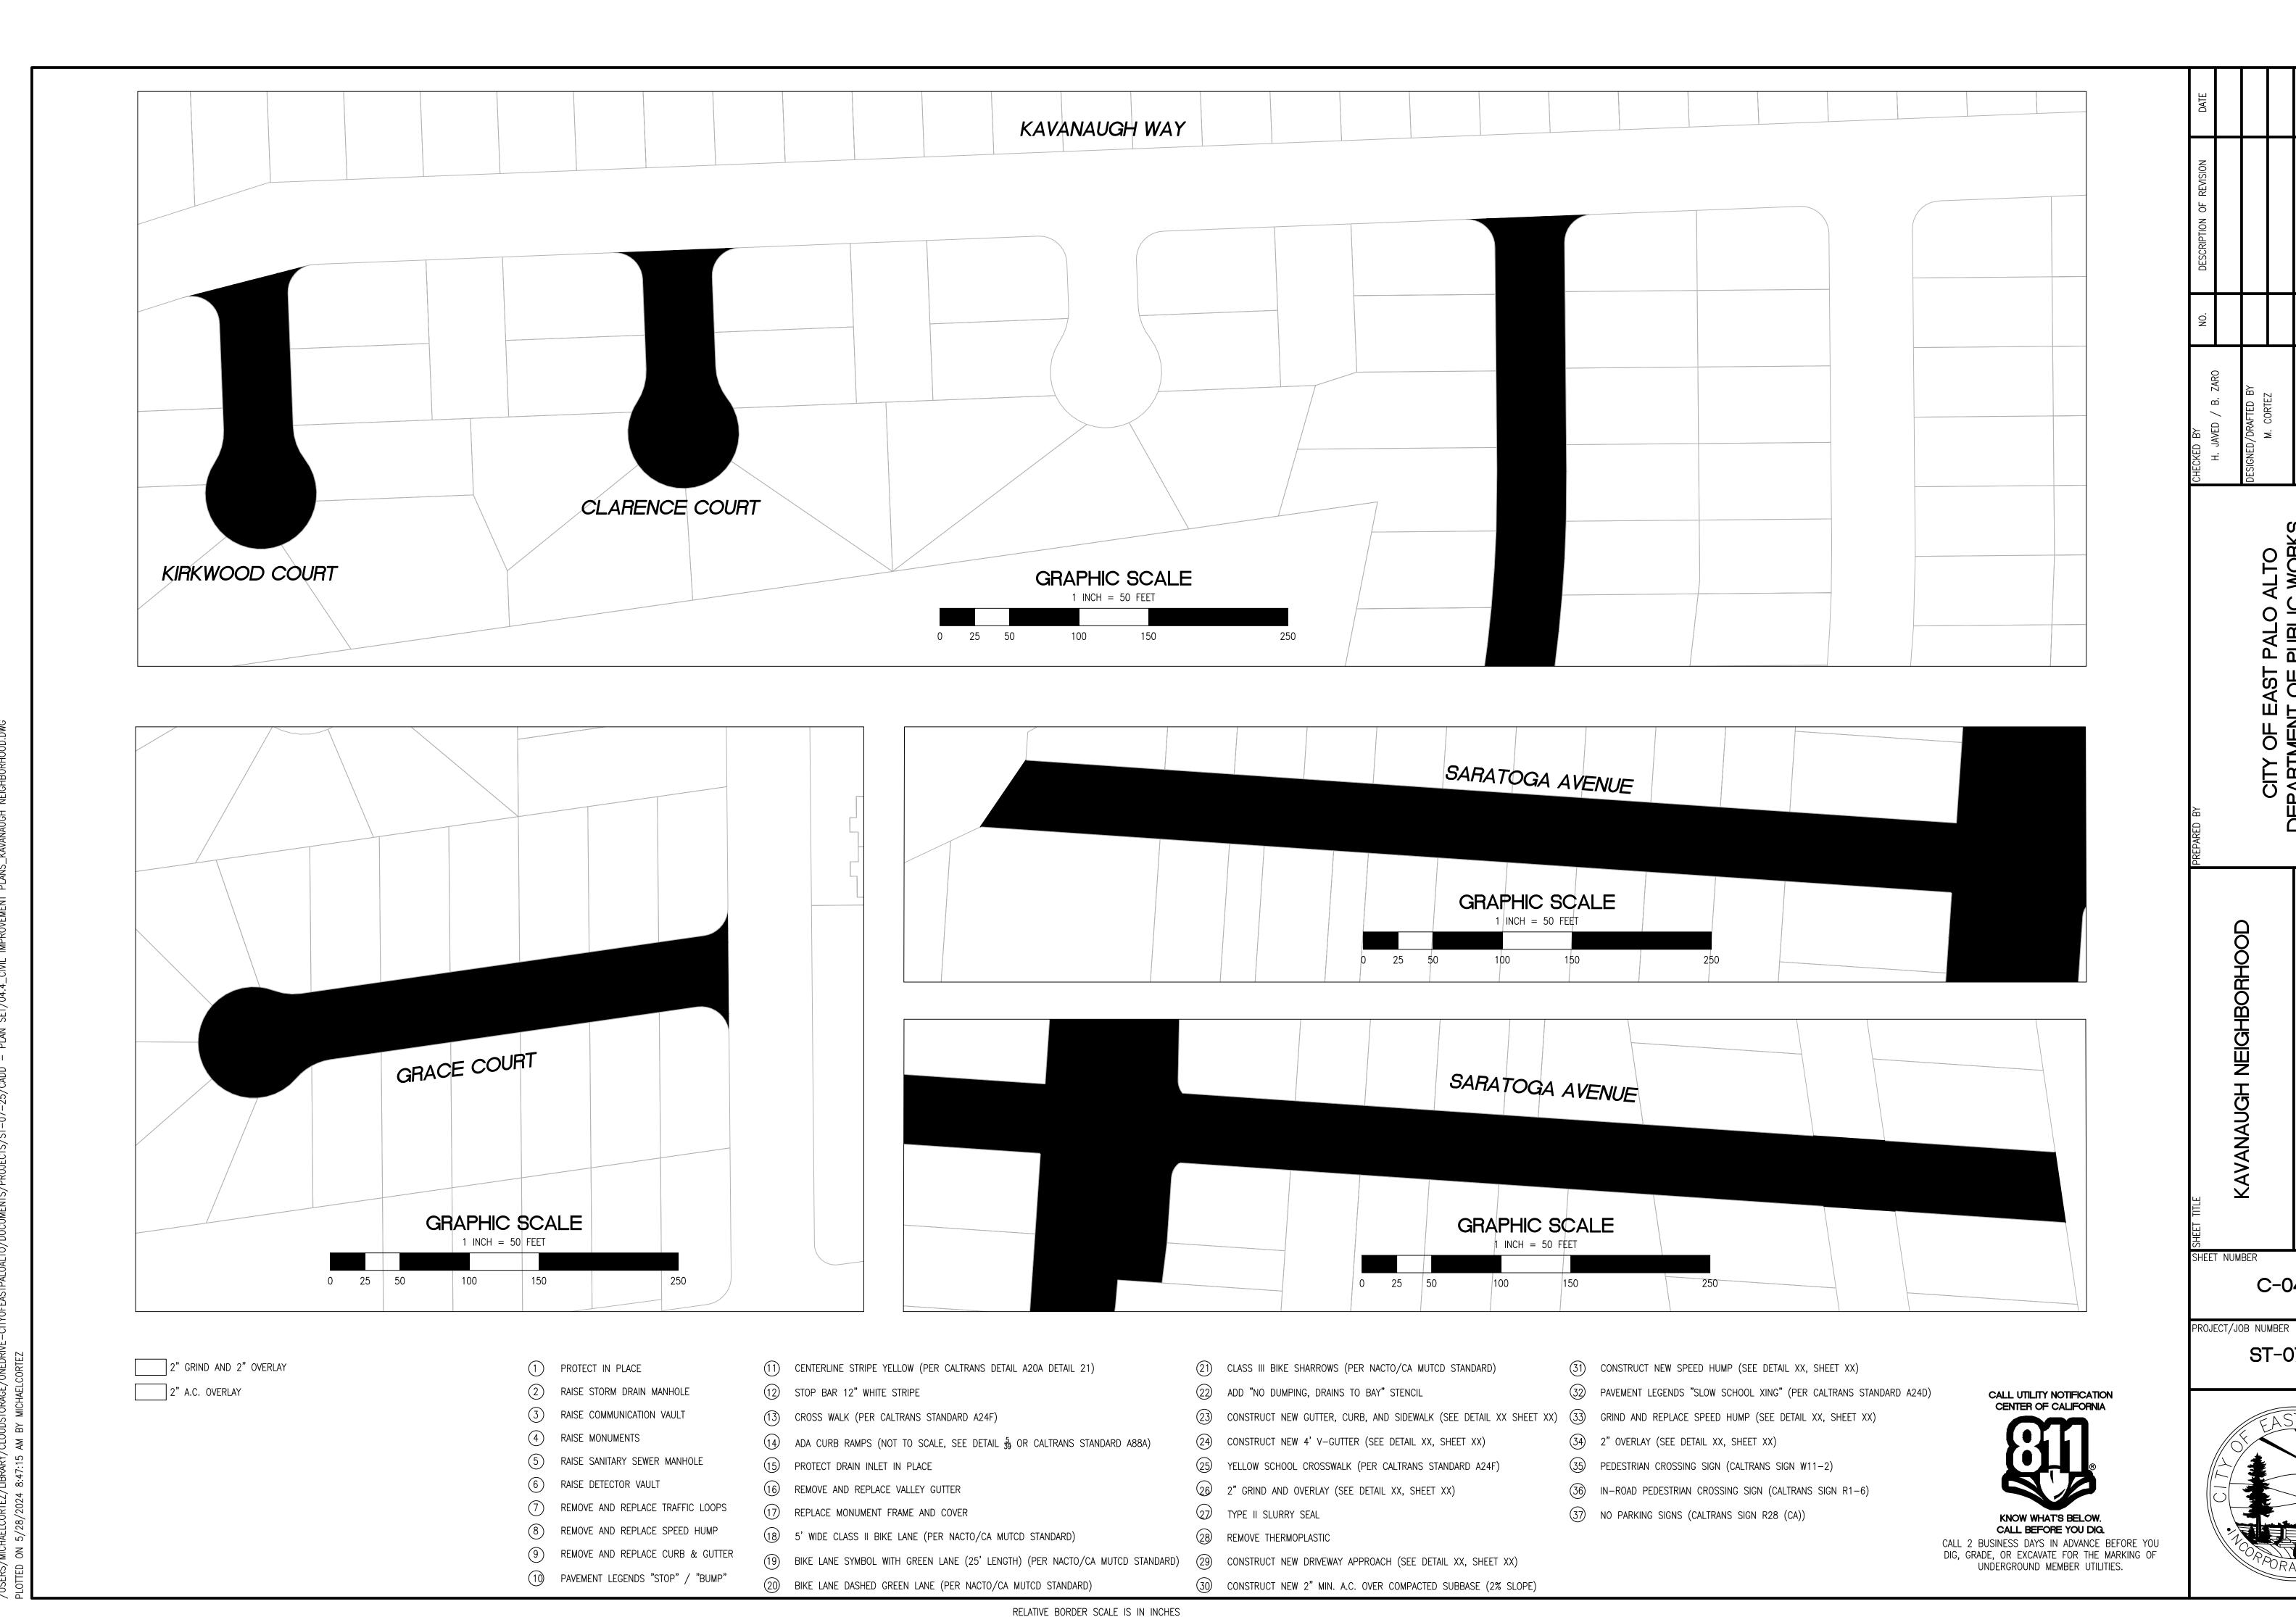C-04.02

ST-07-25

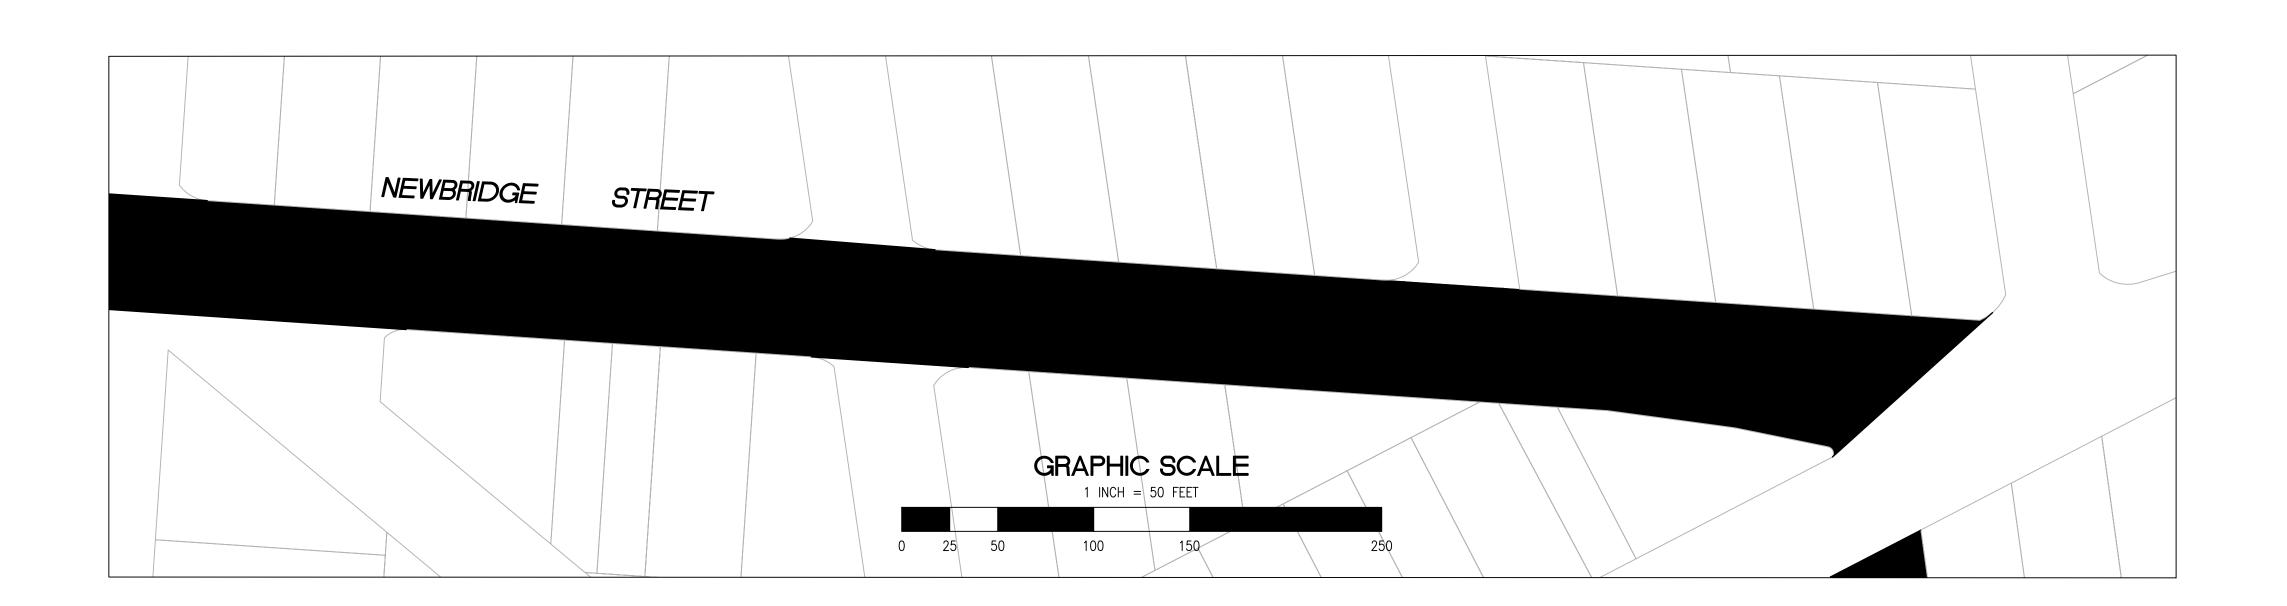

2" GRIND AND 2" OVERLAY 2" A.C. OVERLAY

1 PROTECT IN PLACE

2 RAISE STORM DRAIN MANHOLE

3 RAISE COMMUNICATION VAULT

4 RAISE MONUMENTS

5 RAISE SANITARY SEWER MANHOLE

6 RAISE DETECTOR VAULT

7 REMOVE AND REPLACE TRAFFIC LOOPS

9 REMOVE AND REPLACE CURB & GUTTER

8 REMOVE AND REPLACE SPEED HUMP

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12) STOP BAR 12" WHITE STRIPE

(13) CROSS WALK (PER CALTRANS STANDARD A24F)

14) ADA CURB RAMPS (NOT TO SCALE, SEE DETAIL $\frac{5}{39}$ OR CALTRANS STANDARD A88A)

15) PROTECT DRAIN INLET IN PLACE

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17) REPLACE MONUMENT FRAME AND COVER

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(23) CONSTRUCT NEW GUTTER, CURB, AND SIDEWALK (SEE DETAIL XX SHEET XX) (33) GRIND AND REPLACE SPEED HUMP (SEE DETAIL XX, SHEET XX)

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25) YELLOW SCHOOL CROSSWALK (PER CALTRANS STANDARD A24F)

26 2" GRIND AND OVERLAY (SEE DETAIL XX, SHEET XX)

TYPE II SLURRY SEAL

28) REMOVE THERMOPLASTIC

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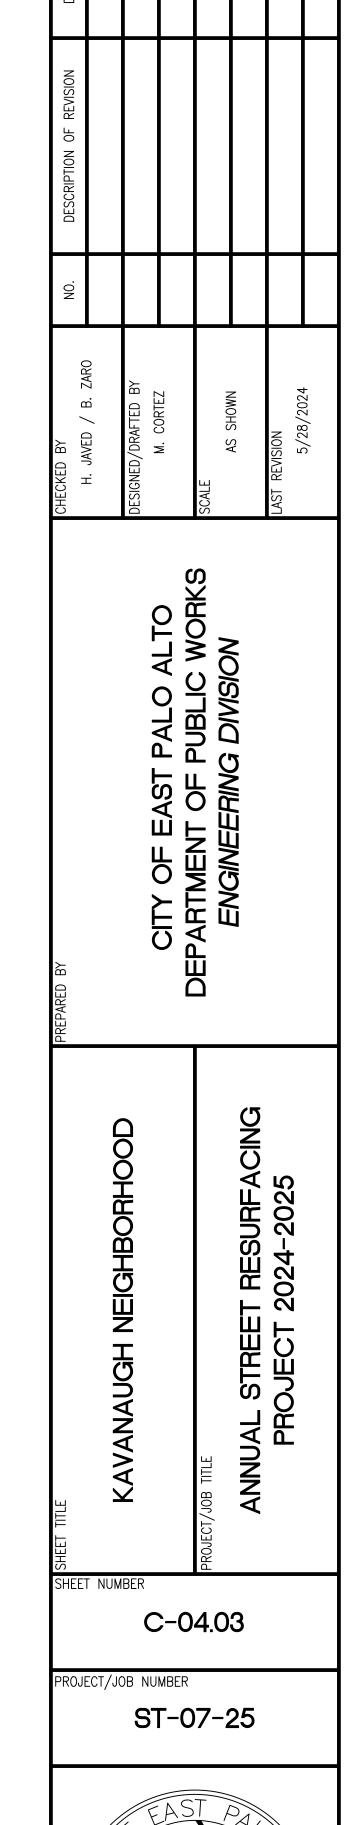
35) PEDESTRIAN CROSSING SIGN (CALTRANS SIGN W11-2)


(36) IN-ROAD PEDESTRIAN CROSSING SIGN (CALTRANS SIGN R1-6)

37) NO PARKING SIGNS (CALTRANS SIGN R28 (CA))

CALL UTILITY NOTIFICATION CENTER OF CALIFORNIA

KNOW WHAT'S BELOW. CALL BEFORE YOU DIG. CALL 2 BUSINESS DAYS IN ADVANCE BEFORE YOU DIG, GRADE, OR EXCAVATE FOR THE MARKING OF UNDERGROUND MEMBER UTILITIES.



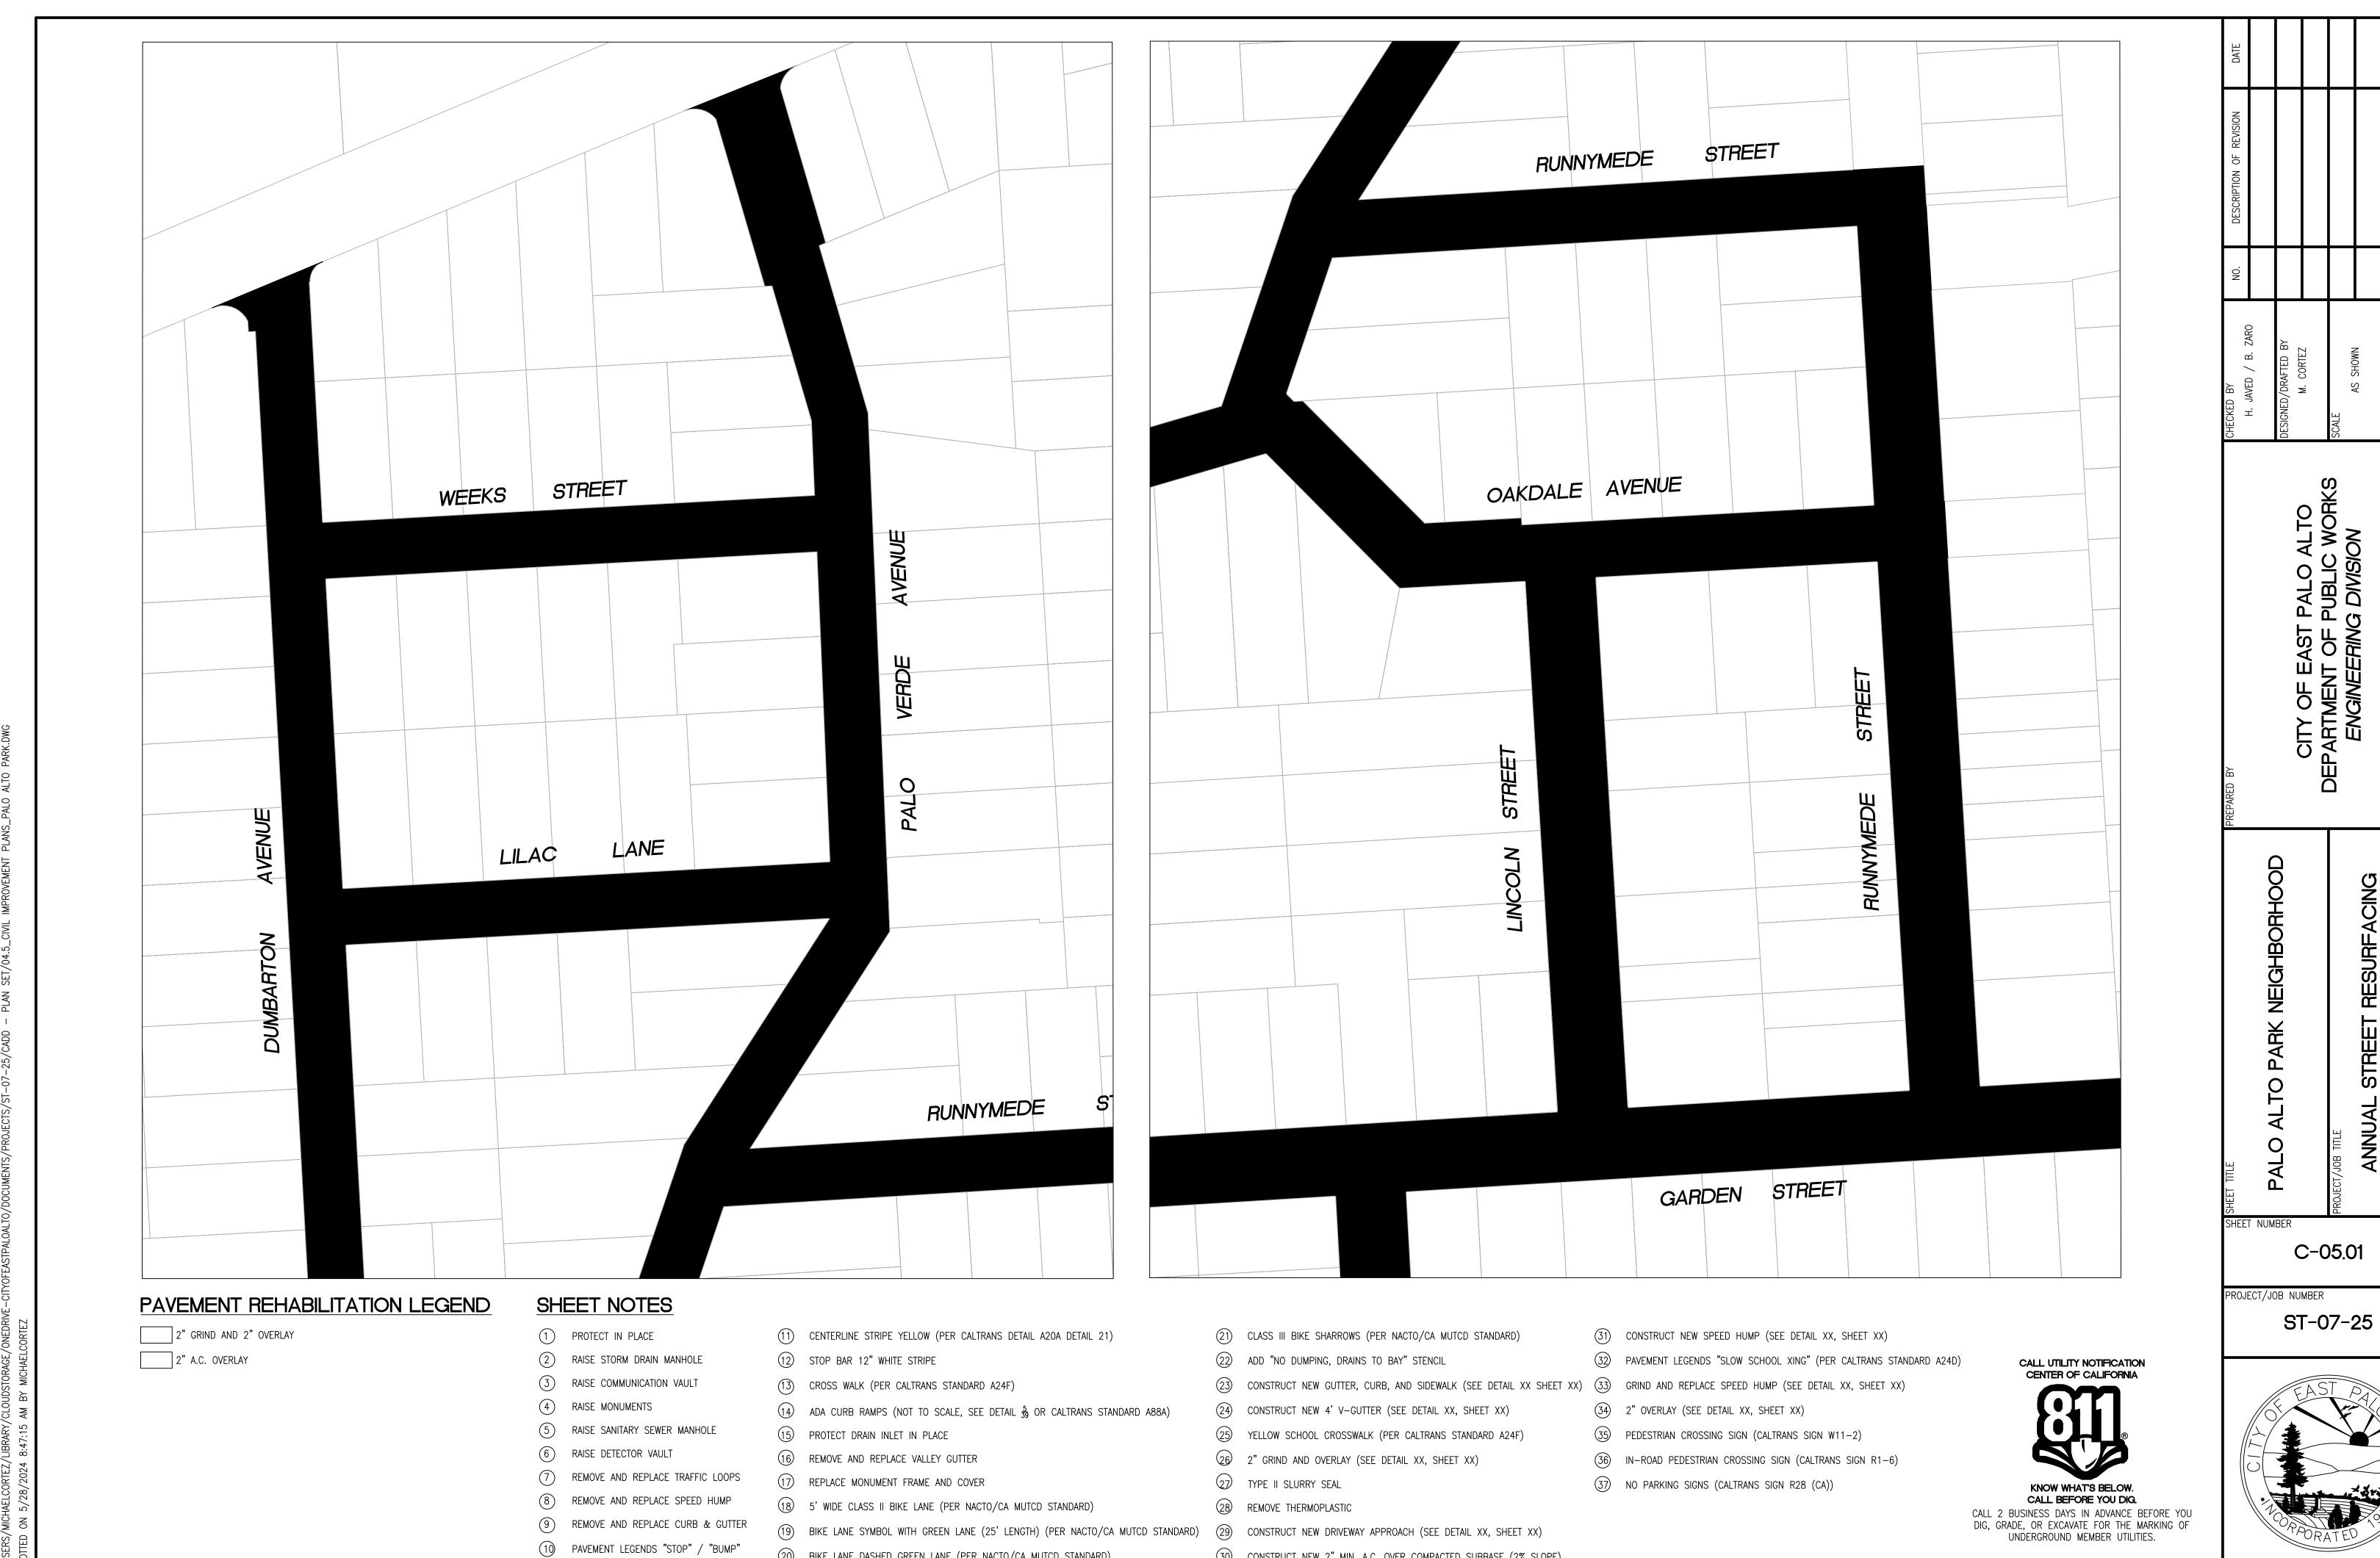

20 BIKE LANE DASHED GREEN LANE (PER NACTO/CA MUTCD STANDARD)

RELATIVE BORDER SCALE IS IN INCHES 0 0.5 1.0

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ALTO

SHEET NUMBER

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PROJECT/JOB NUMBER

C-05.01

ST-07-25

PLOTTED ON 5/28/2024 8:47:15 AM BY MICHAELCORTEZ

RELATIVE BORDER SCALE IS IN INCHES

0 0.5 1.0

IT THIS LINE DOES NOT MEASURE 1 INCH. THESE PLANS

16 REMOVE AND REPLACE VALLEY GUTTER

17) REPLACE MONUMENT FRAME AND COVER

18) 5' WIDE CLASS II BIKE LANE (PER NACTO/CA MUTCD STANDARD)

20 BIKE LANE DASHED GREEN LANE (PER NACTO/CA MUTCD STANDARD)

6 RAISE DETECTOR VAULT

7 REMOVE AND REPLACE TRAFFIC LOOPS

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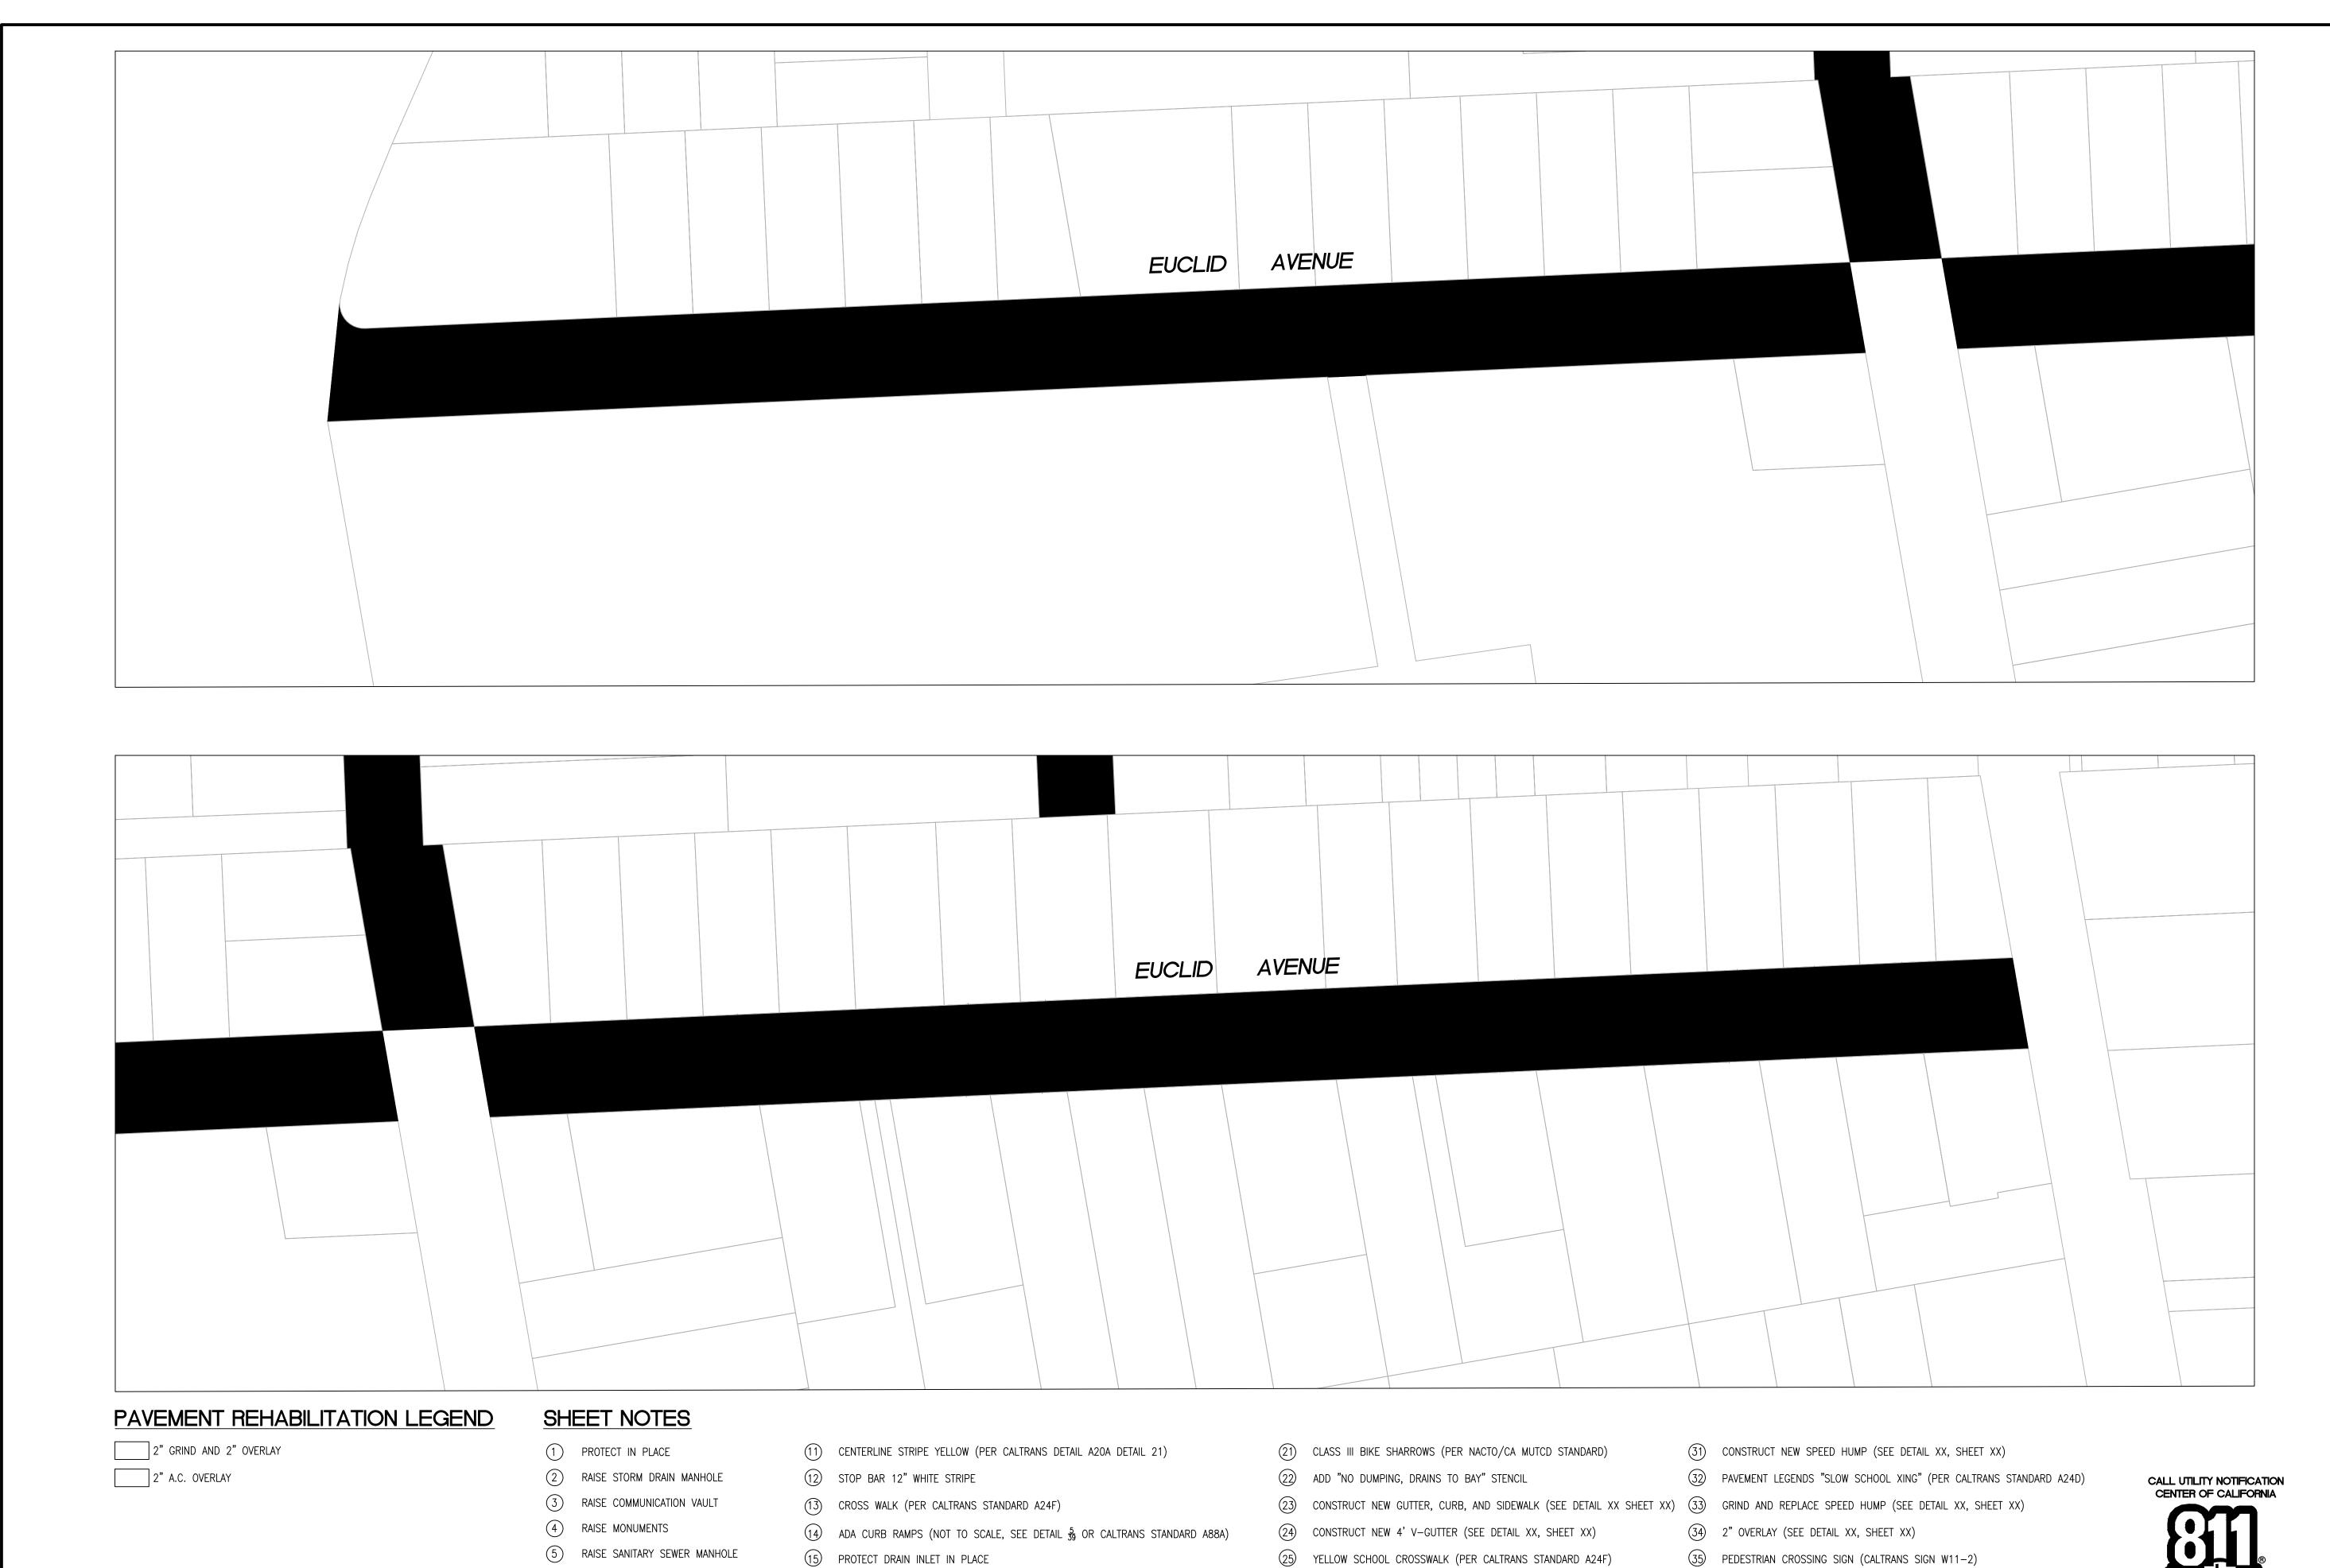
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PLOTTED ON 5/28/2024 8:47:15 AM BY MICHAELCORTEZ

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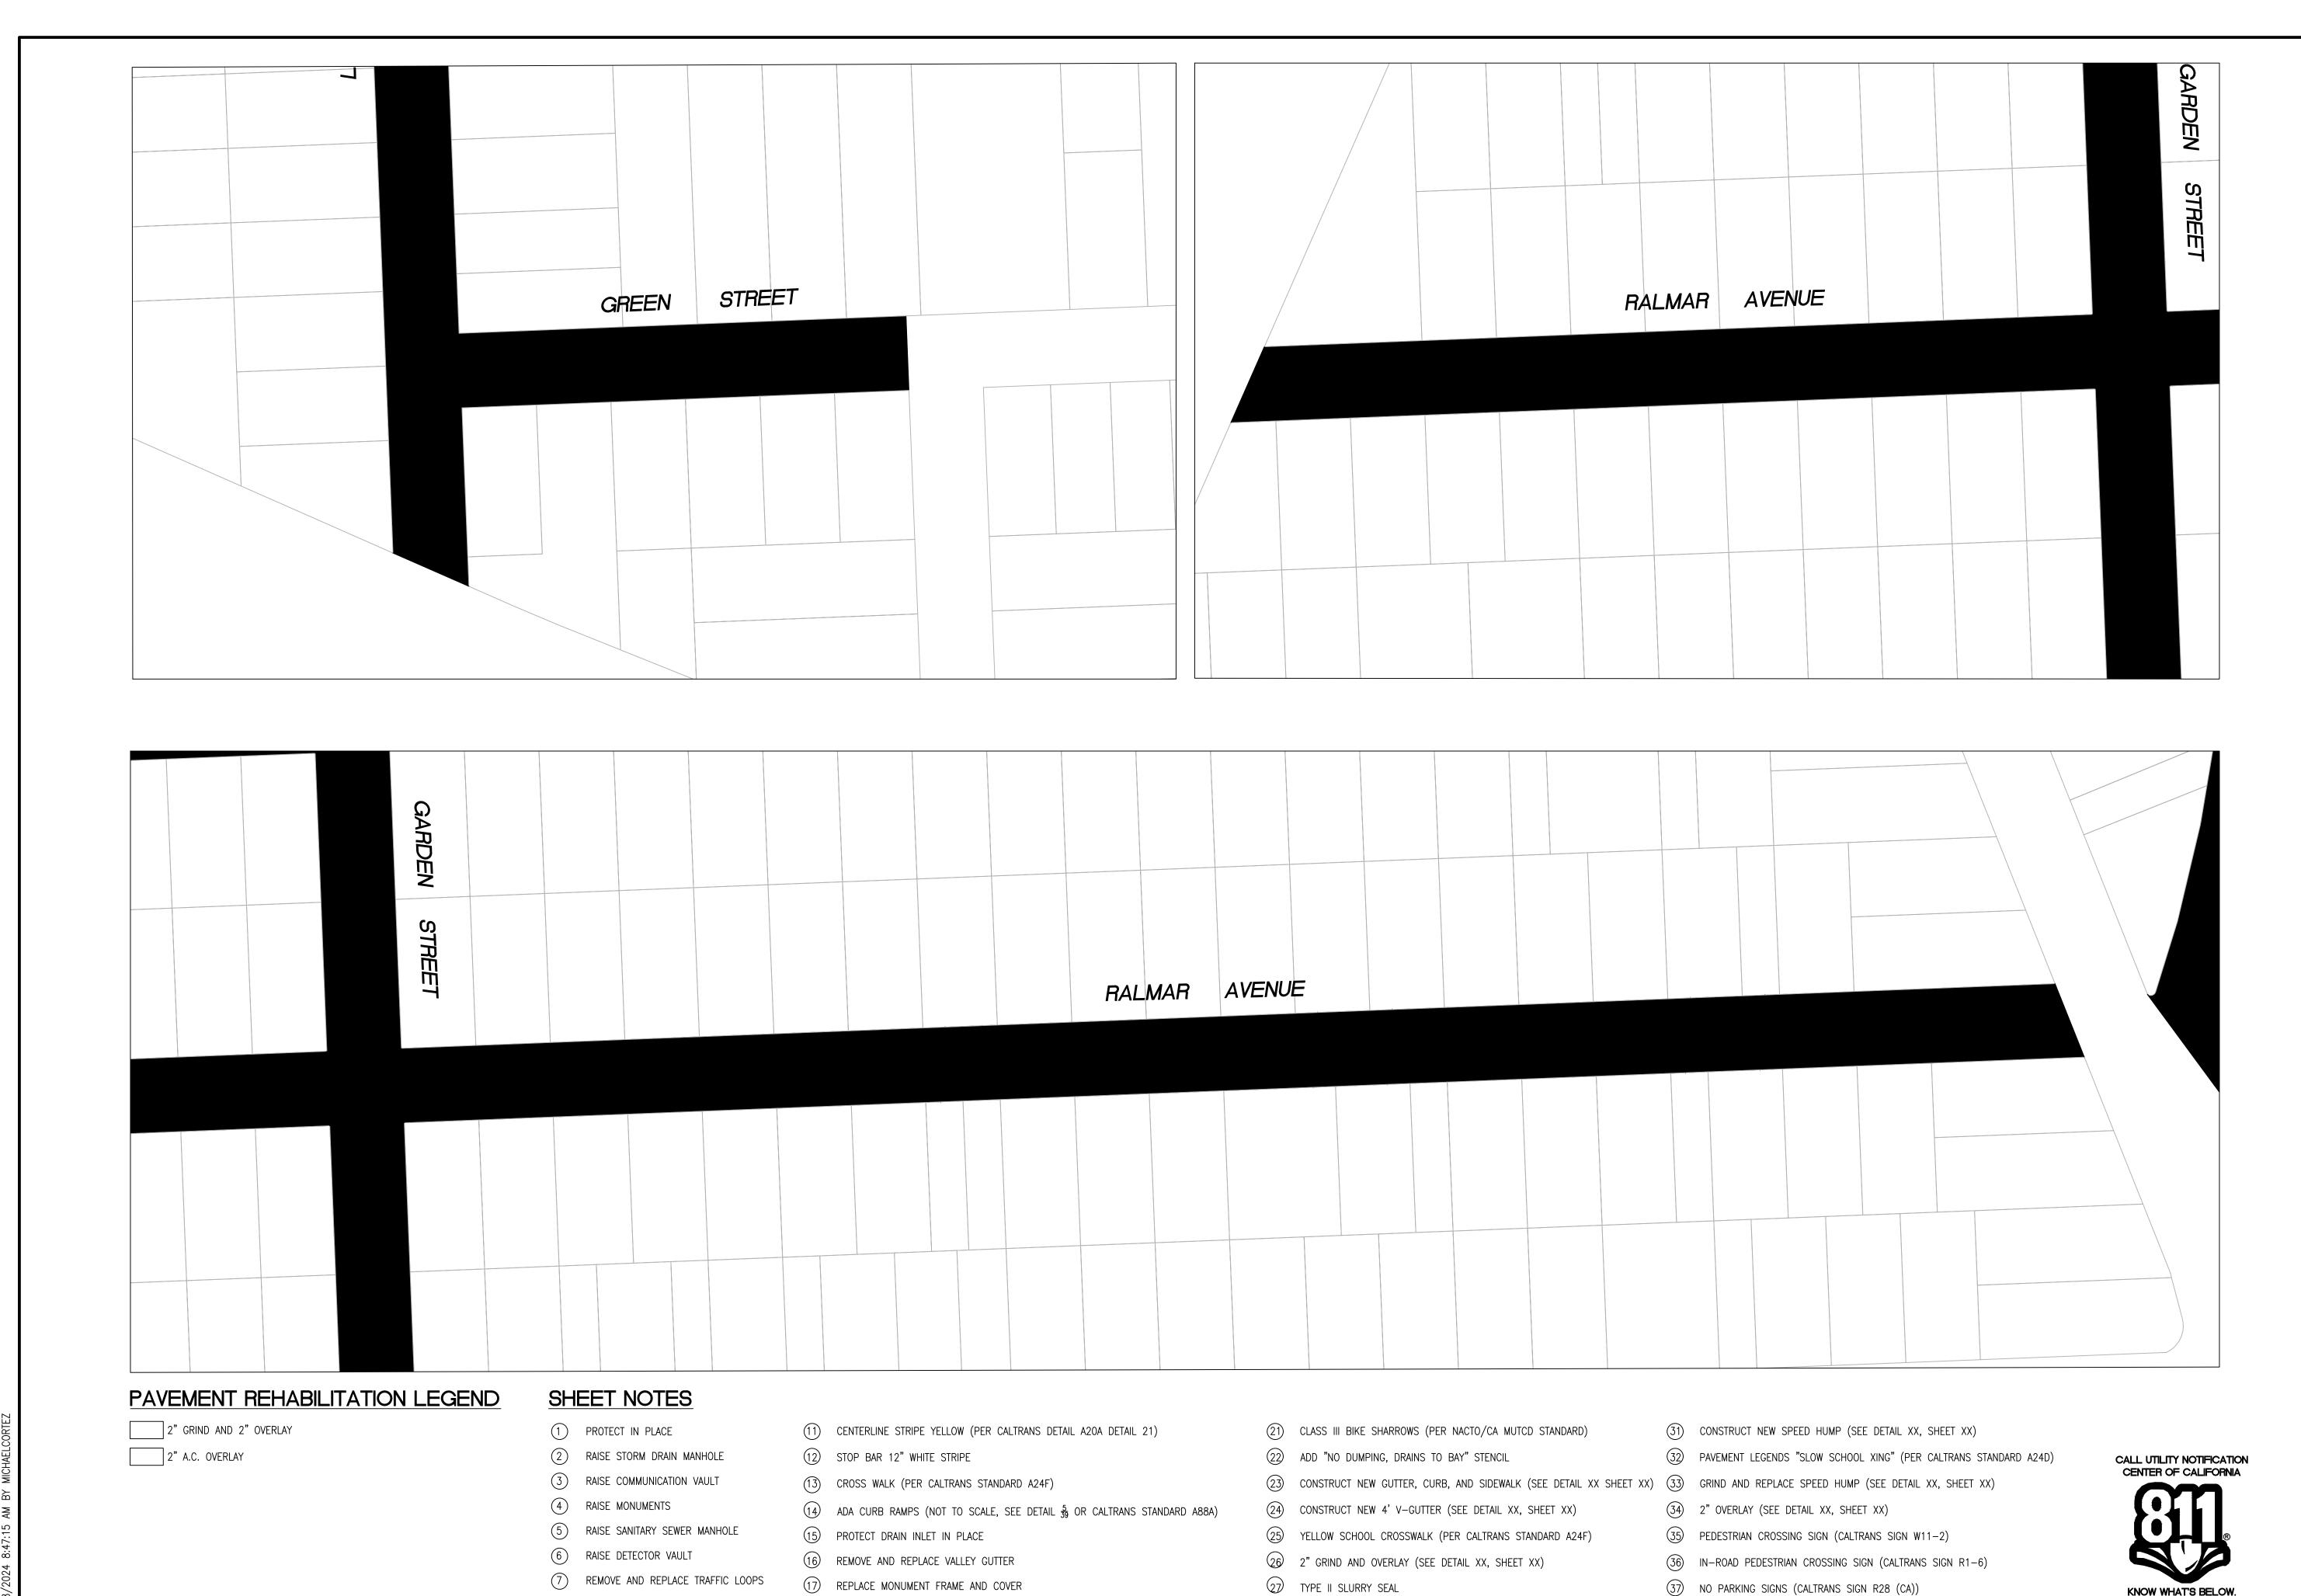
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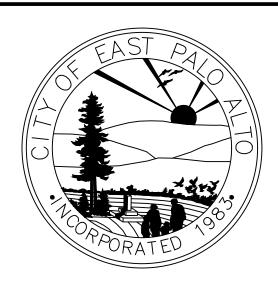
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PARK NEIGHBORHOOD ALTO


SHEET NUMBER C-05.04


PROJECT/JOB NUMBER

ST-07-25





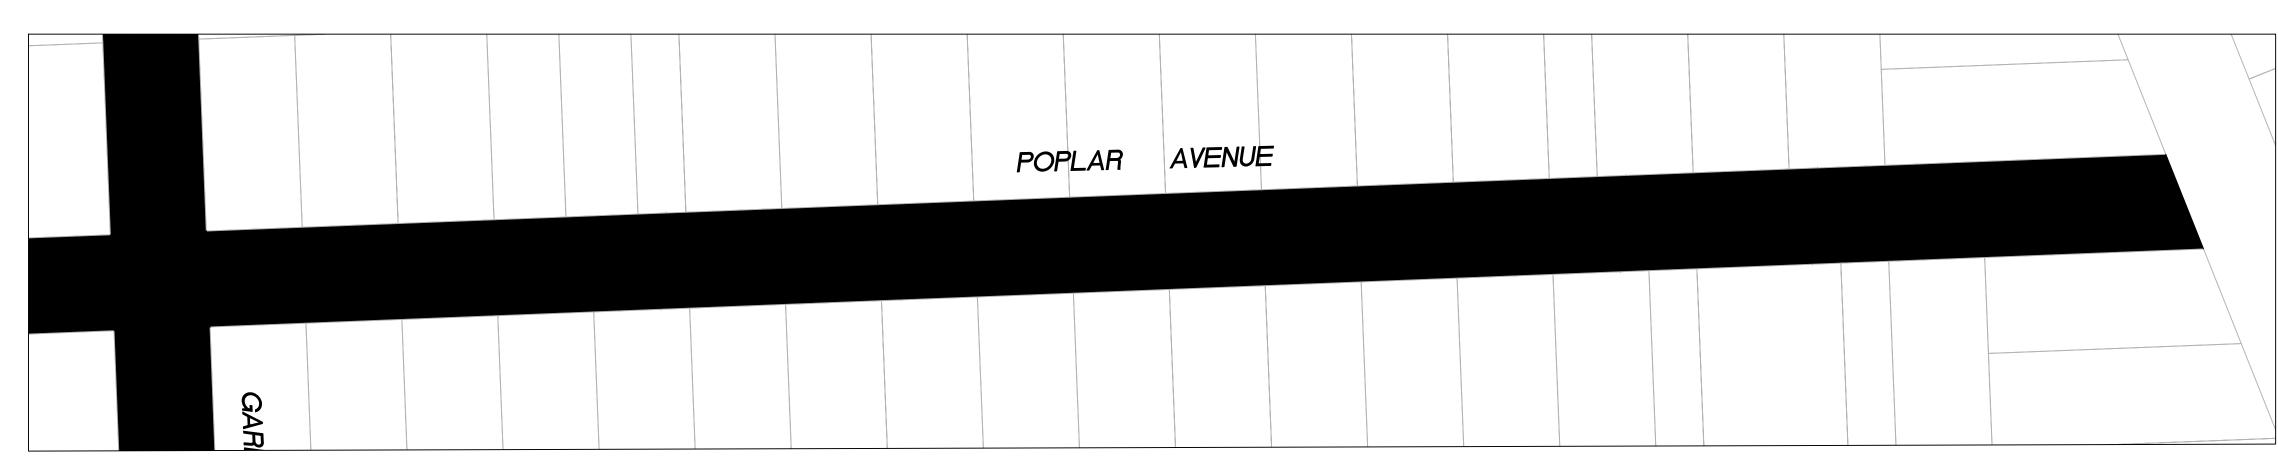

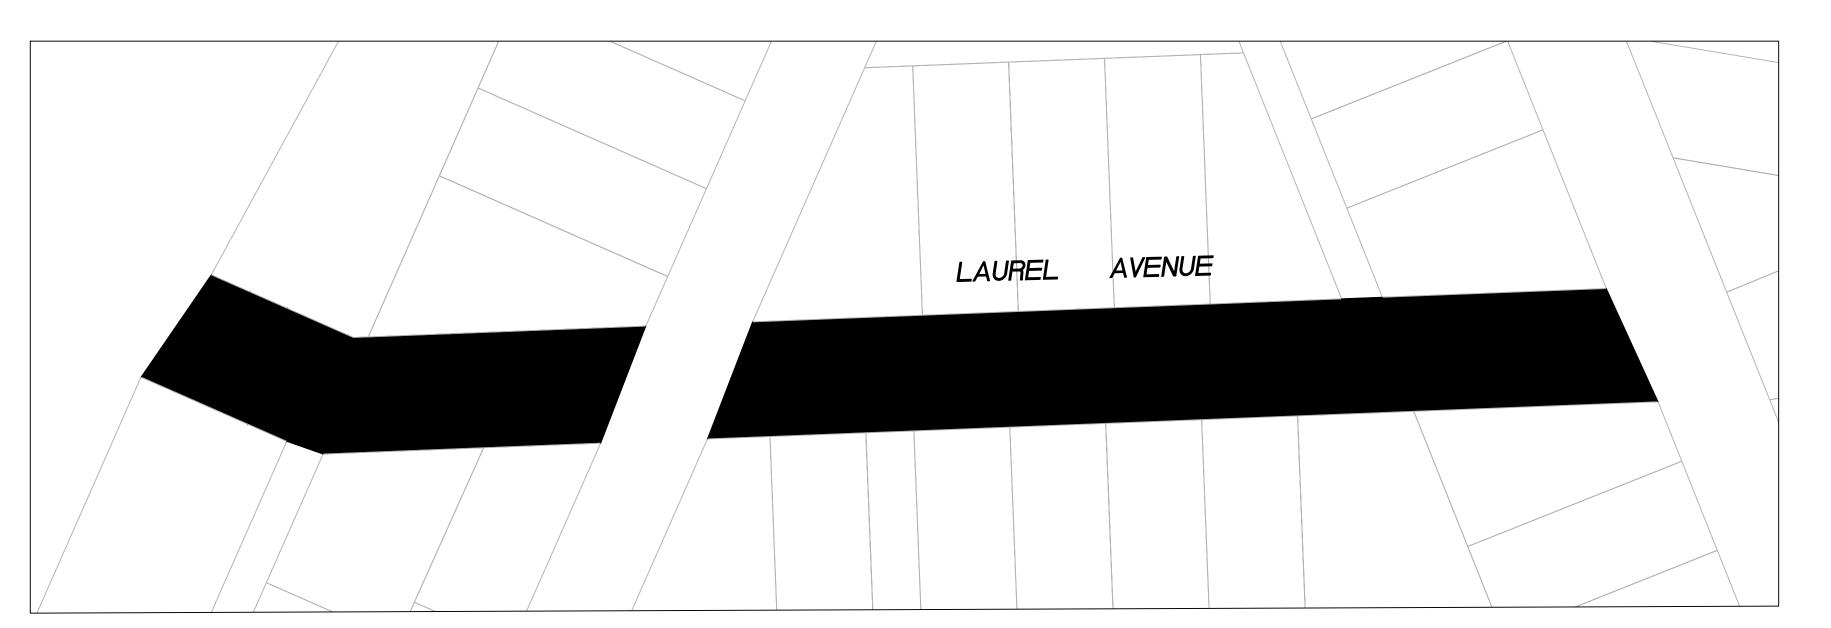

2" GRIND AND 2" OVERLAY

2" A.C. OVERLAY


SHEET NOTES

- 1 PROTECT IN PLACE
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- 4 RAISE MONUMENTS
- 5 RAISE SANITARY SEWER MANHOLE
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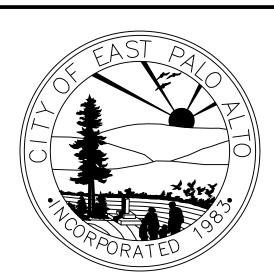
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 - 37) NO PARKING SIGNS (CALTRANS SIGN R28 (CA))



DESCRIPTION OF REVISION DATE							
NO.							
CHECKED BY	11. JAYED / D. ZAINO	DESIGNED/DRAFTED BY	M. CORIEZ	SCALE AS SHOWIN	AS SHOWN	LAST REVISION 5,738,73031	+202/02/0
PREPARED BY				SANDWEIN OF FUBLIC WORNS			
SHEET TITLE				PROJECT/JOB TITLE	ANNUAL STREET RESURFACING	PROJECT 2024-2025	
	Γ NUM		: -0	5.0	5		

PROJECT/JOB NUMBER

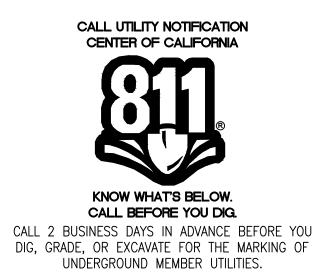ST-07-25



SHEET NUMBER

KNOW WHAT'S BELOW. CALL BEFORE YOU DIG.

CALL 2 BUSINESS DAYS IN ADVANCE BEFORE YOU DIG, GRADE, OR EXCAVATE FOR THE MARKING OF UNDERGROUND MEMBER UTILITIES.

PROJECT/JOB NUMBER

C-05.06

ST-07-25

RELATIVE BORDER SCALE IS IN INCHES

19 BIKE LANE SYMBOL WITH GREEN LANE (25' LENGTH) (PER NACTO/CA MUTCD STANDARD) (29 CONSTRUCT NEW DRIVEWAY APPROACH (SEE DETAIL XX, SHEET XX)

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4 RAISE MONUMENTS

6 RAISE DETECTOR VAULT

5 RAISE SANITARY SEWER MANHOLE

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2" GRIND AND 2" OVERLAY

2" A.C. OVERLAY

SHEET NOTES

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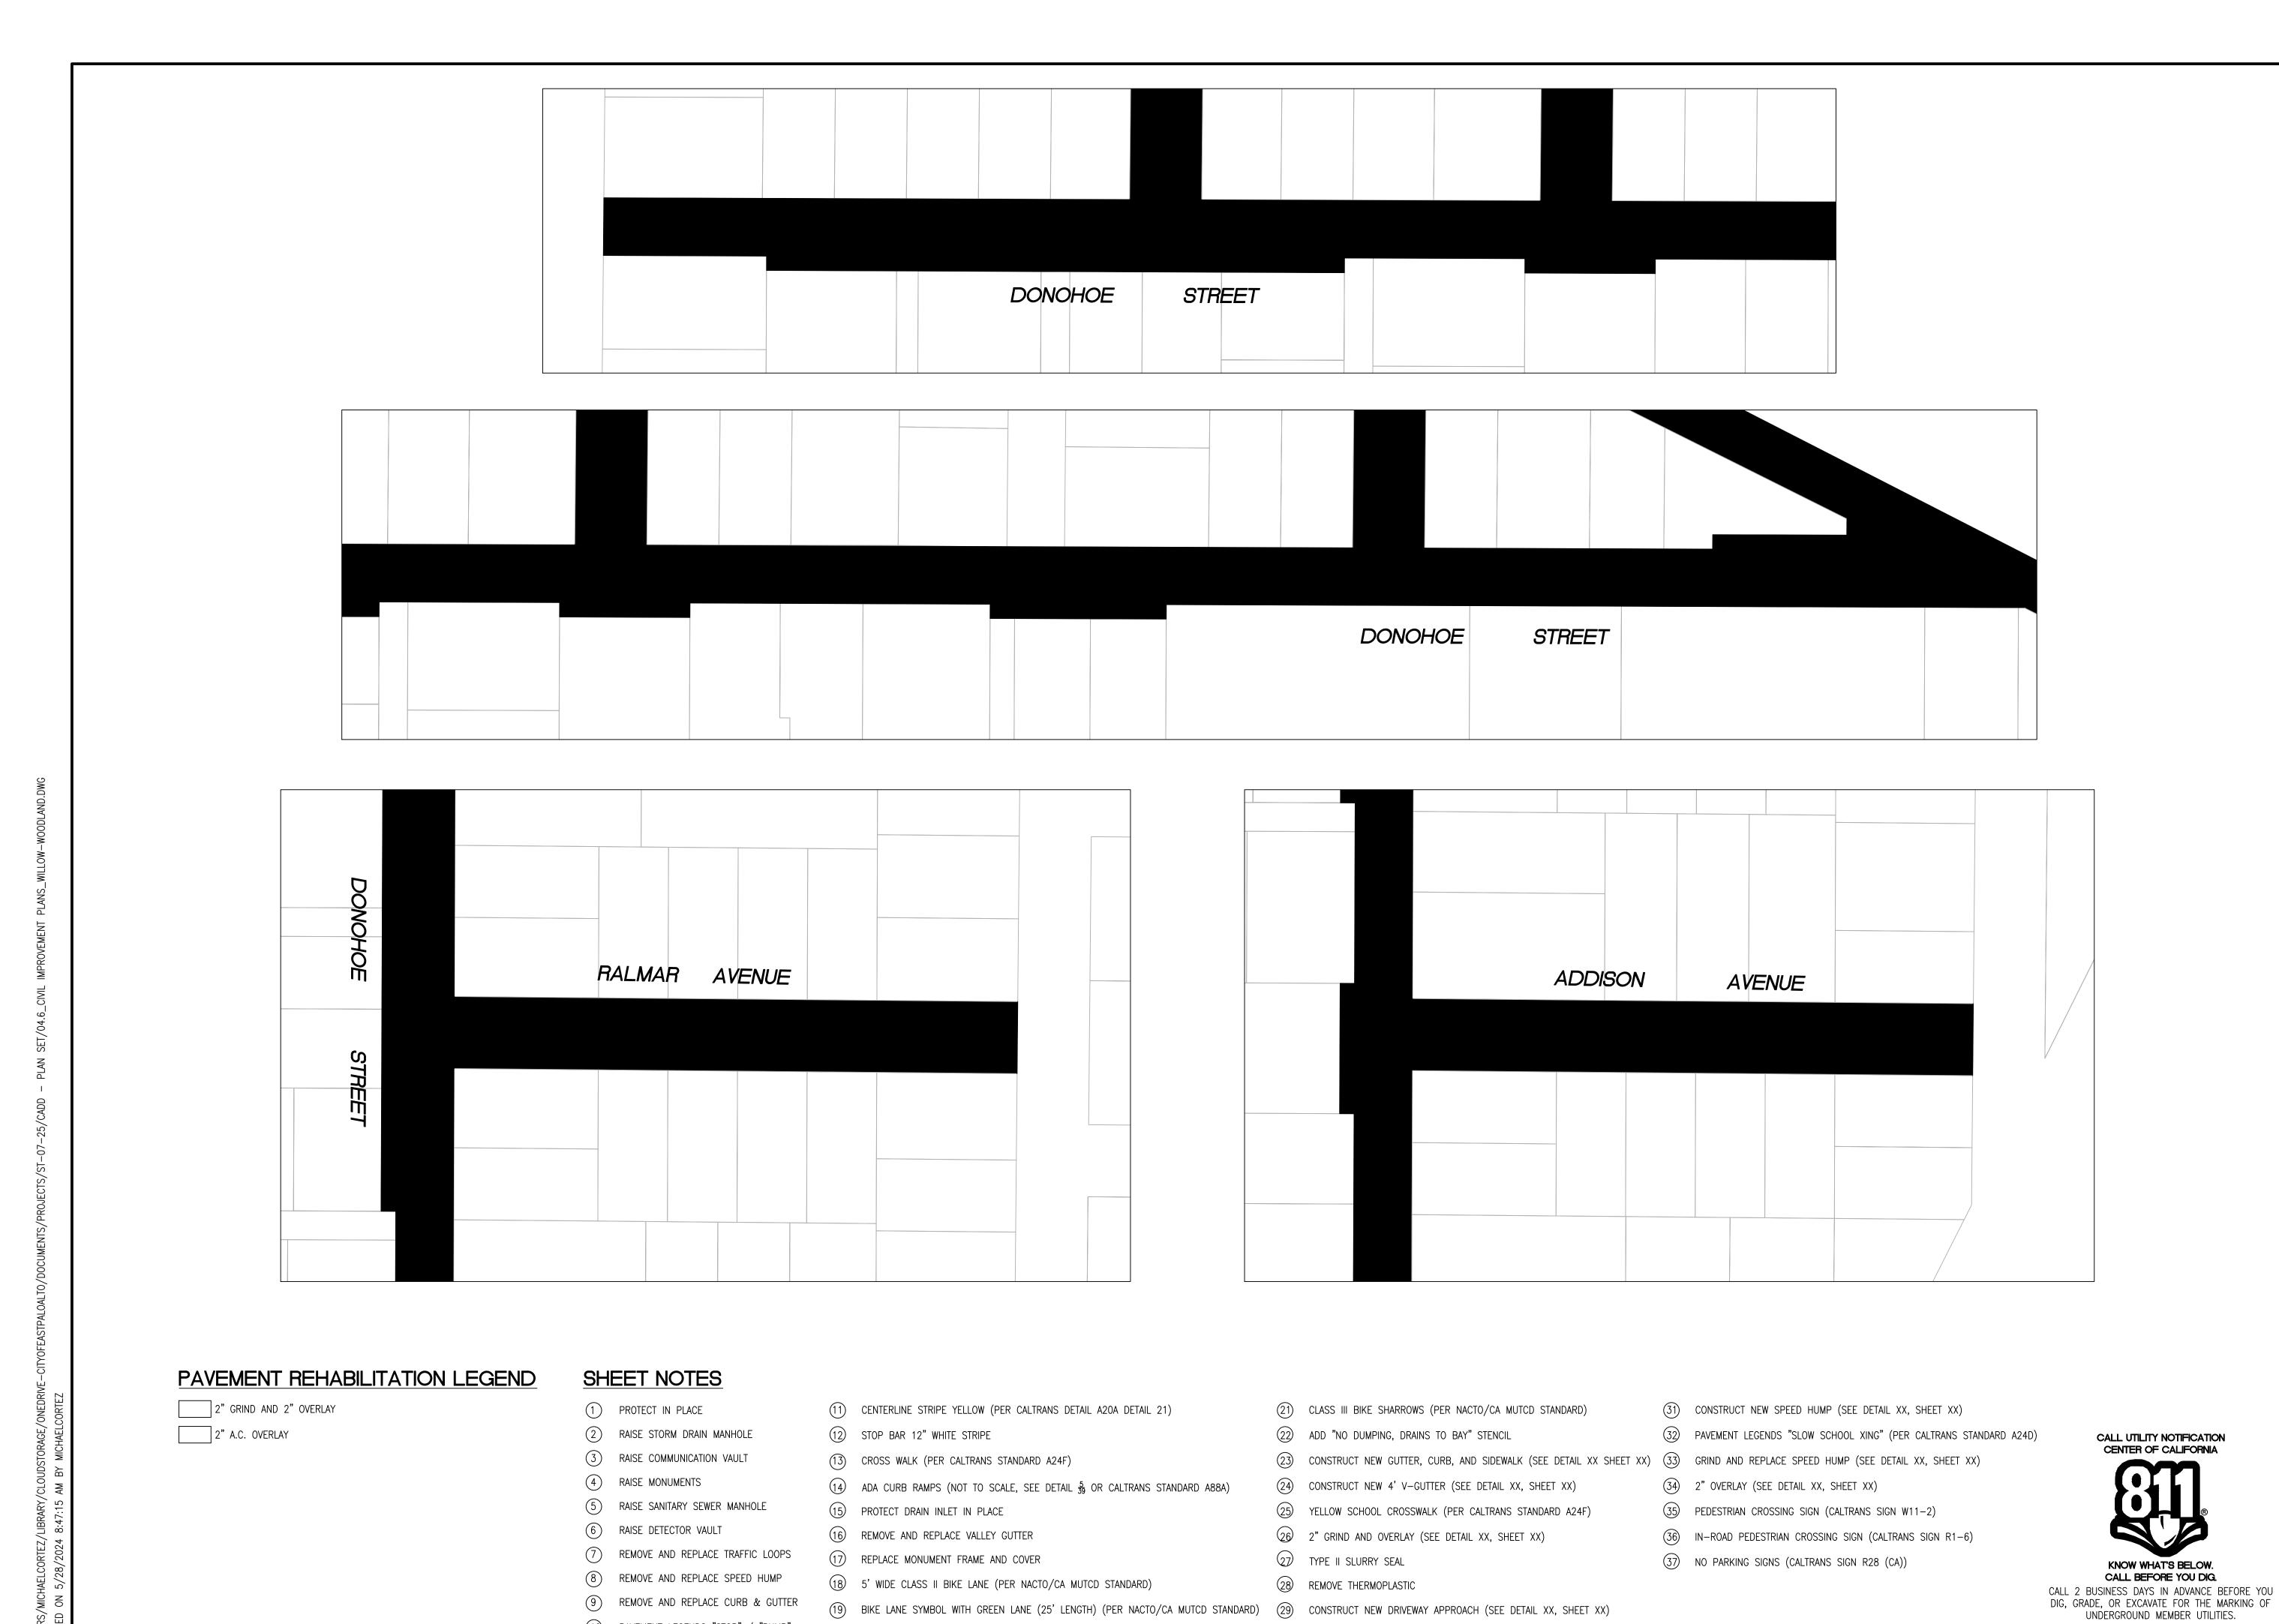
ALTO

C-05.07

SHEET NUMBER

PROJECT/JOB NUMBER ST-07-25





SHEET NUMBER C-06.01 PROJECT/JOB NUMBER ST-07-25


RELATIVE BORDER SCALE IS IN INCHES 0 0.5 1.0

19 BIKE LANE SYMBOL WITH GREEN LANE (25' LENGTH) (PER NACTO/CA MUTCD STANDARD) (29 CONSTRUCT NEW DRIVEWAY APPROACH (SEE DETAIL XX, SHEET XX)

30 CONSTRUCT NEW 2" MIN. A.C. OVER COMPACTED SUBBASE (2% SLOPE)

20 BIKE LANE DASHED GREEN LANE (PER NACTO/CA MUTCD STANDARD)

10 PAVEMENT LEGENDS "STOP" / "BUMP"

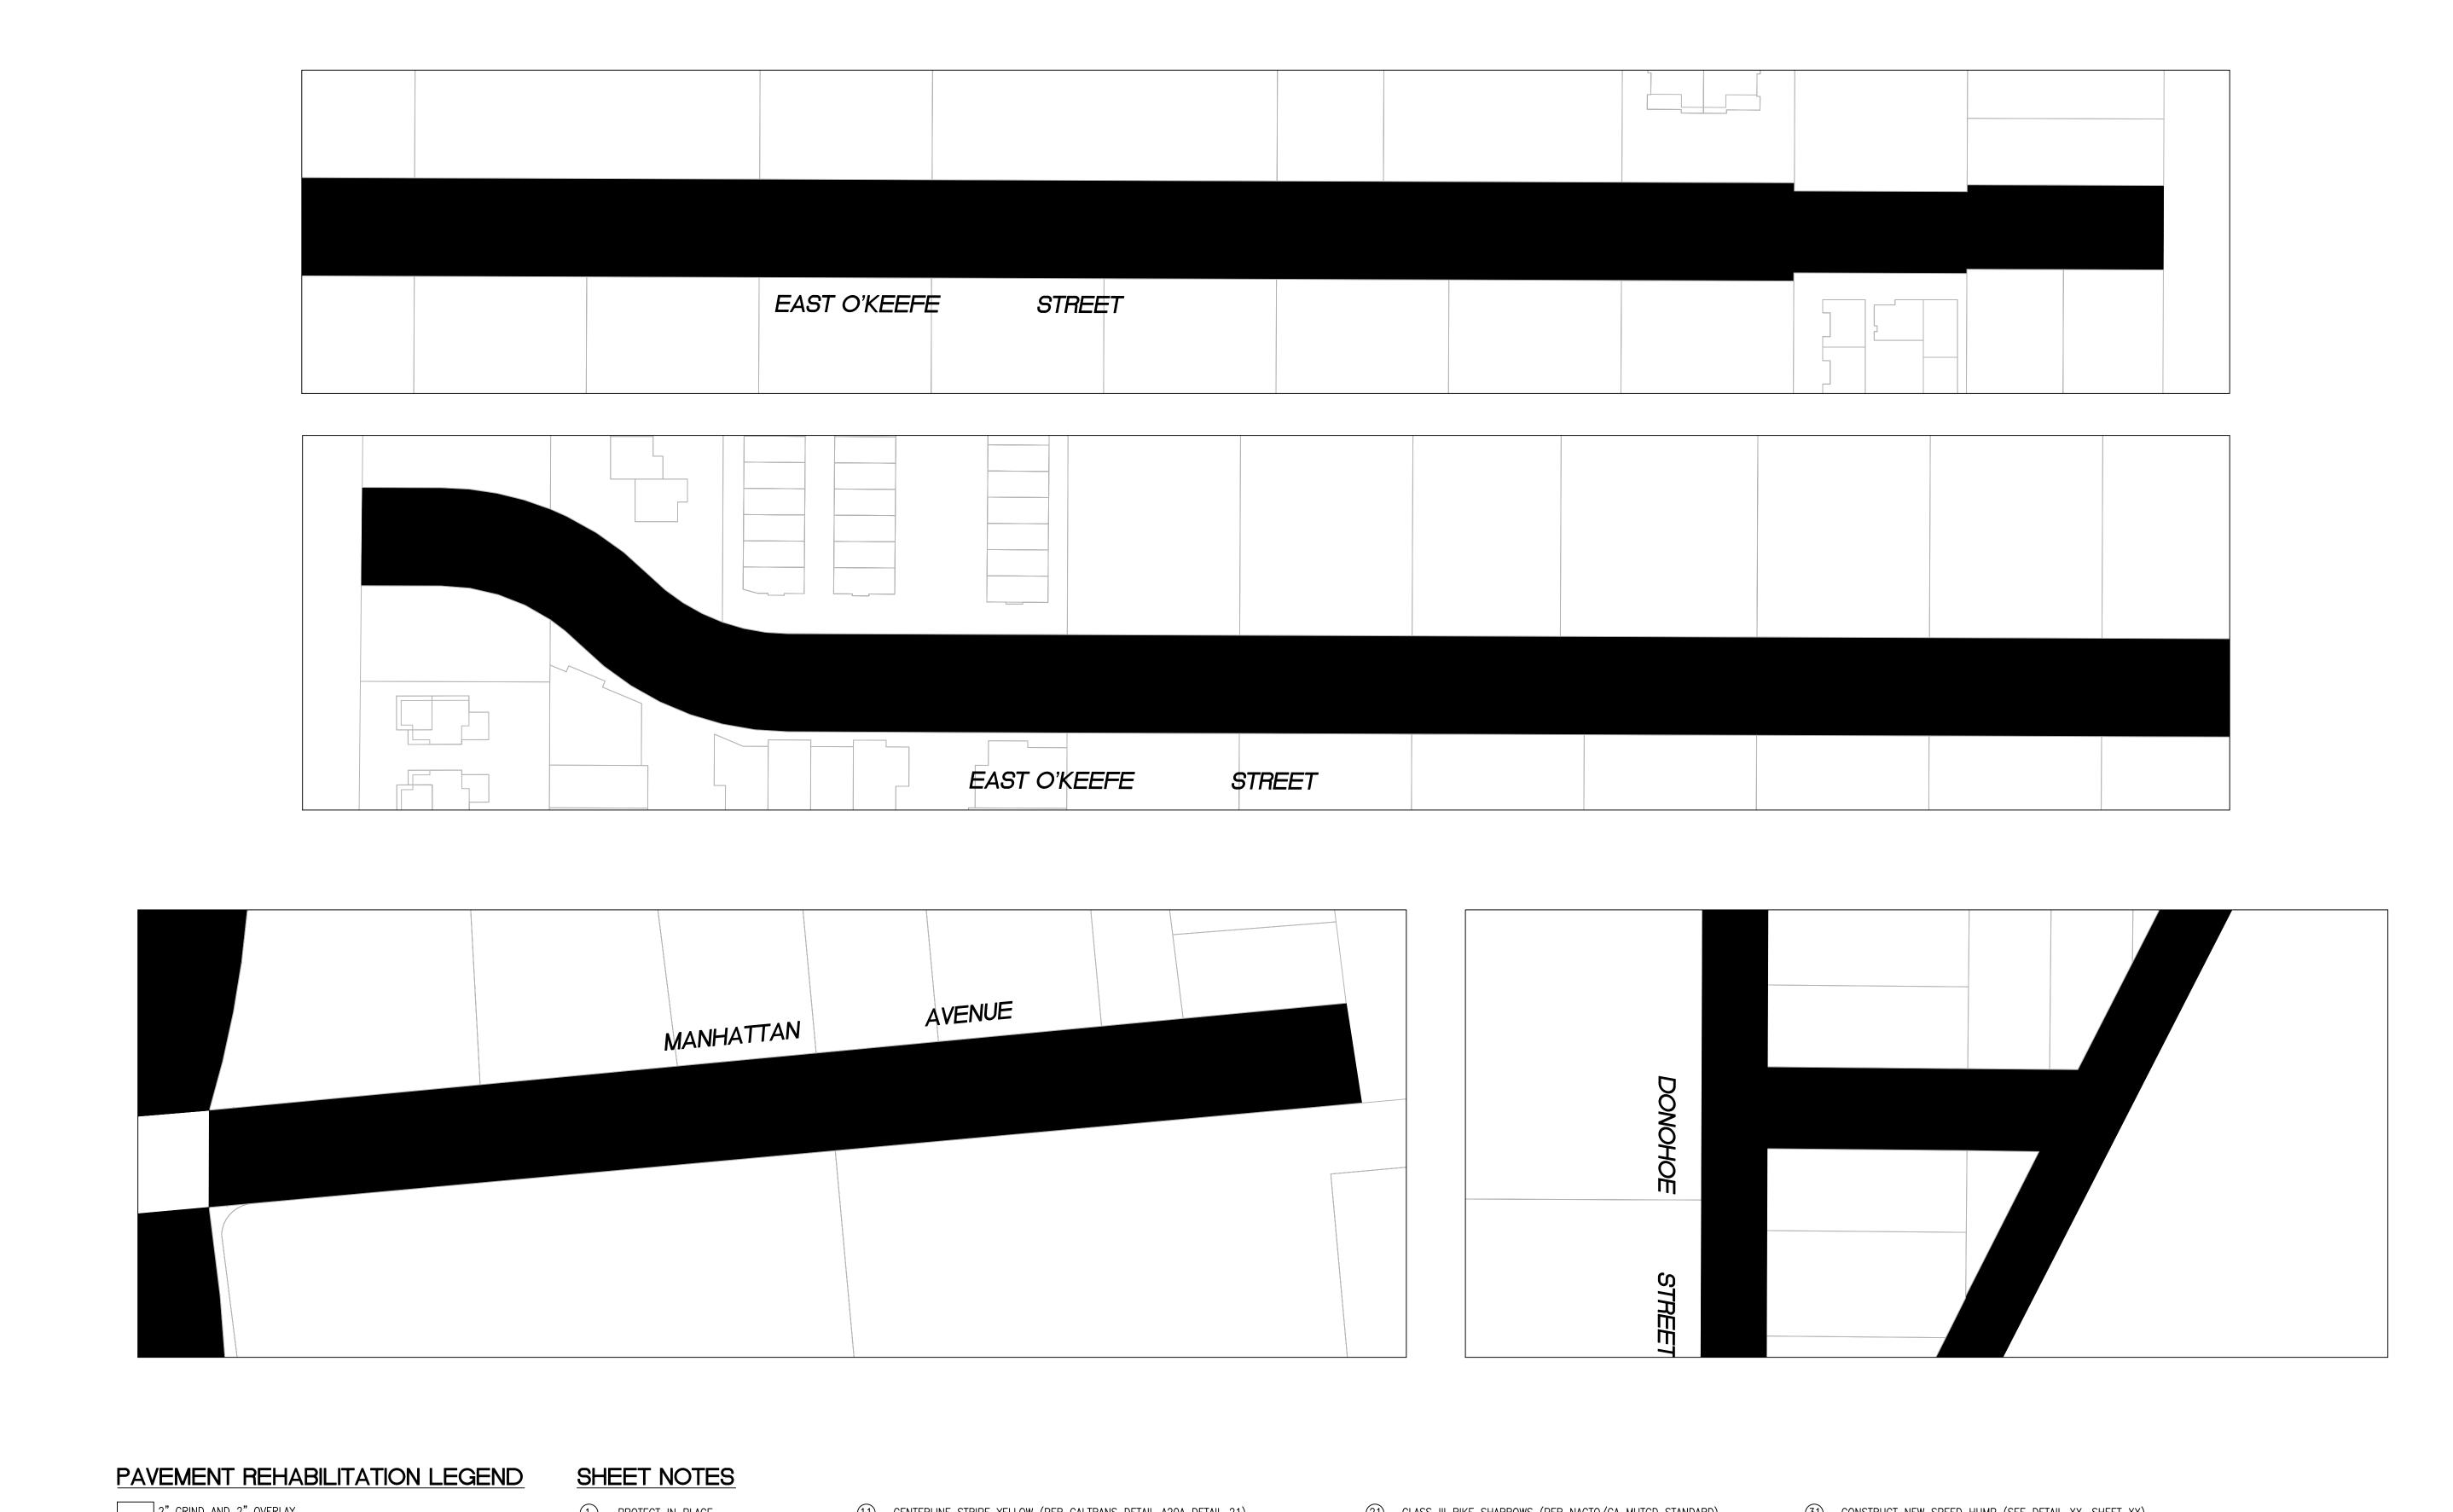

2" GRIND AND 2" OVERLAY

2" A.C. OVERLAY

- 1 PROTECT IN PLACE
- 2 RAISE STORM DRAIN MANHOLE
- 3 RAISE COMMUNICATION VAULT
- 4 RAISE MONUMENTS
- 5 RAISE SANITARY SEWER MANHOLE
- 6 RAISE DETECTOR VAULT
- 7 REMOVE AND REPLACE TRAFFIC LOOPS
- 8 REMOVE AND REPLACE SPEED HUMP
- 9 REMOVE AND REPLACE CURB & GUTTER 10 PAVEMENT LEGENDS "STOP" / "BUMP"

- (1) CENTERLINE STRIPE YELLOW (PER CALTRANS DETAIL A20A DETAIL 21)
- 12) STOP BAR 12" WHITE STRIPE
- (13) CROSS WALK (PER CALTRANS STANDARD A24F)
- 14) ADA CURB RAMPS (NOT TO SCALE, SEE DETAIL $\frac{5}{39}$ OR CALTRANS STANDARD A88A)
- 15) PROTECT DRAIN INLET IN PLACE
- 16 REMOVE AND REPLACE VALLEY GUTTER
- 17) REPLACE MONUMENT FRAME AND COVER
- 18) 5' WIDE CLASS II BIKE LANE (PER NACTO/CA MUTCD STANDARD)
- 20 BIKE LANE DASHED GREEN LANE (PER NACTO/CA MUTCD STANDARD)


- (21) CLASS III BIKE SHARROWS (PER NACTO/CA MUTCD STANDARD)
- 22) ADD "NO DUMPING, DRAINS TO BAY" STENCIL
- (24) CONSTRUCT NEW 4' V-GUTTER (SEE DETAIL XX, SHEET XX)
- 25) YELLOW SCHOOL CROSSWALK (PER CALTRANS STANDARD A24F) 26 2" GRIND AND OVERLAY (SEE DETAIL XX, SHEET XX)
- 27) TYPE II SLURRY SEAL
- 28) REMOVE THERMOPLASTIC
- 19 BIKE LANE SYMBOL WITH GREEN LANE (25' LENGTH) (PER NACTO/CA MUTCD STANDARD) (29 CONSTRUCT NEW DRIVEWAY APPROACH (SEE DETAIL XX, SHEET XX)
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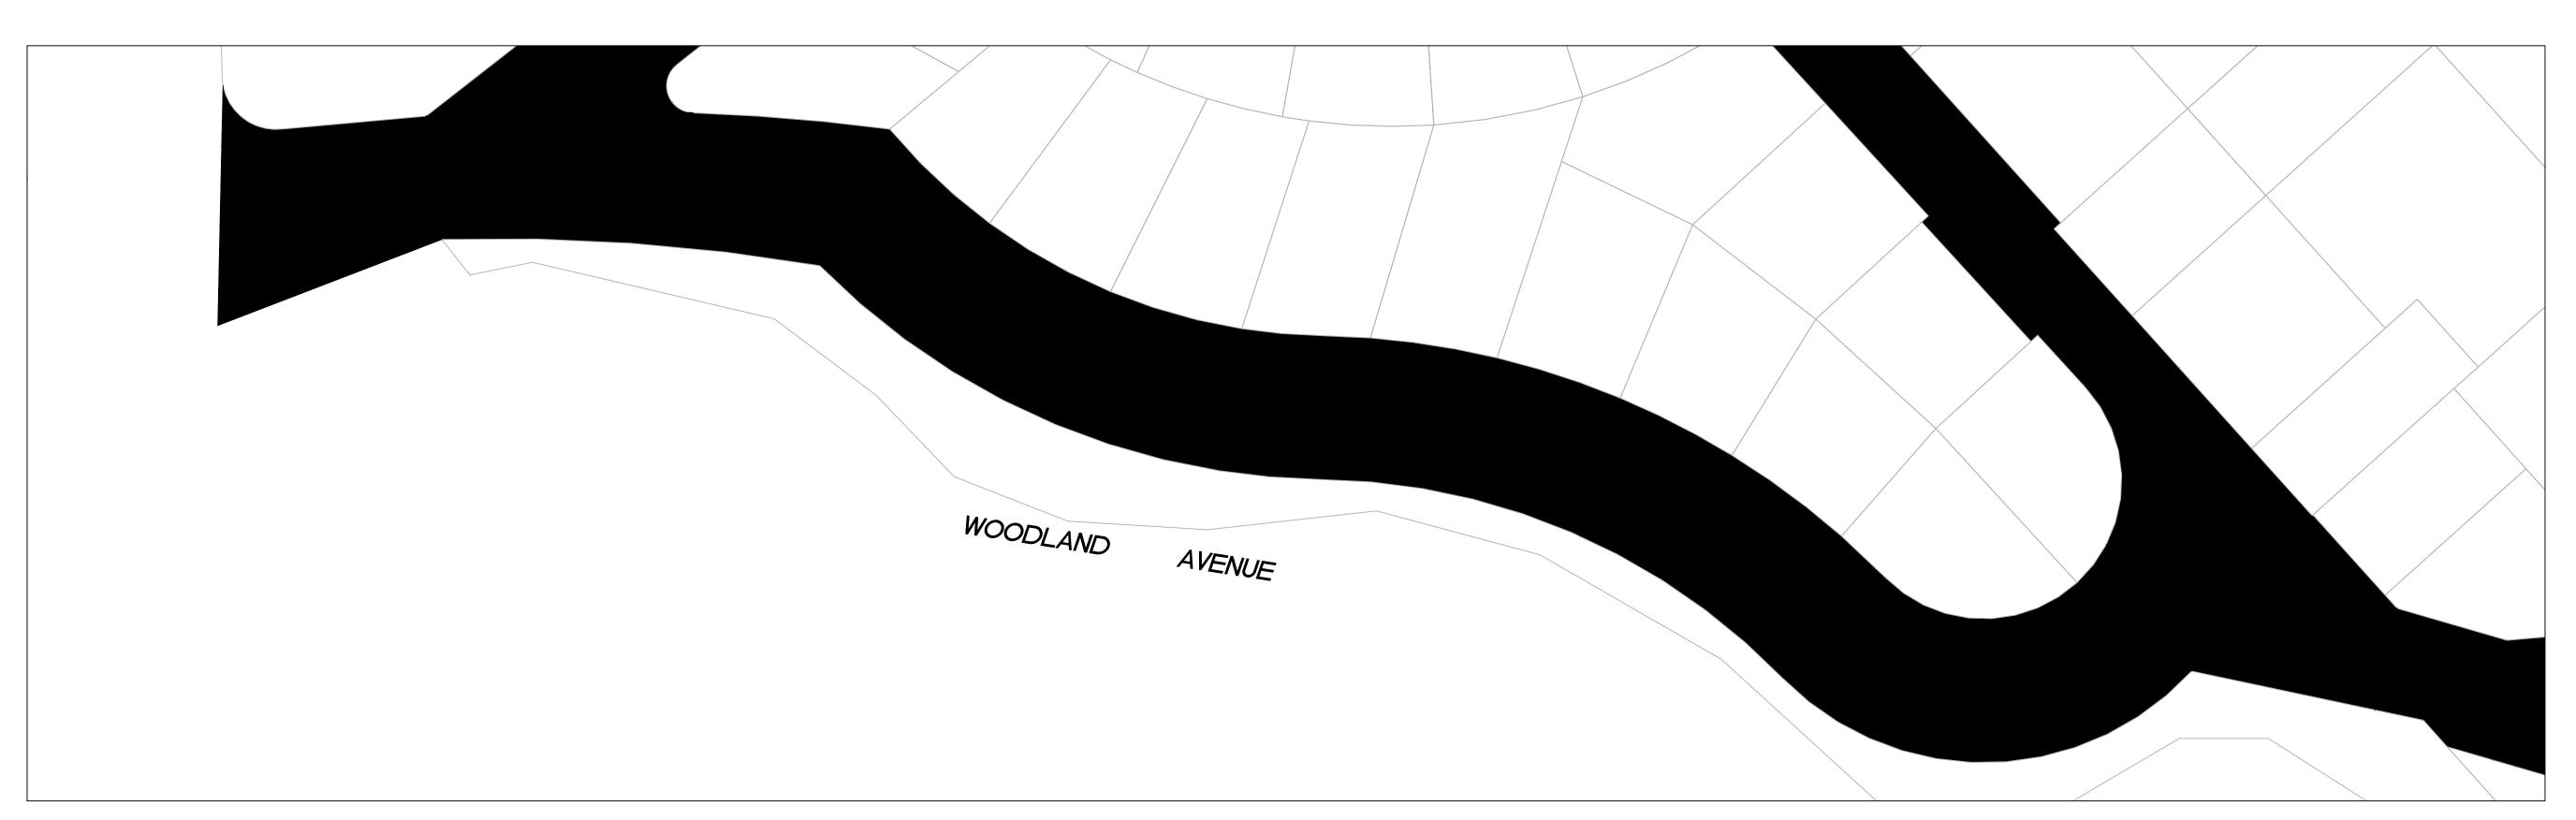
- (31) CONSTRUCT NEW SPEED HUMP (SEE DETAIL XX, SHEET XX)
- 32) PAVEMENT LEGENDS "SLOW SCHOOL XING" (PER CALTRANS STANDARD A24D) (23) CONSTRUCT NEW GUTTER, CURB, AND SIDEWALK (SEE DETAIL XX SHEET XX) (33) GRIND AND REPLACE SPEED HUMP (SEE DETAIL XX, SHEET XX)
 - 34) 2" OVERLAY (SEE DETAIL XX, SHEET XX)
 - 35) PEDESTRIAN CROSSING SIGN (CALTRANS SIGN W11-2)
 - (36) IN-ROAD PEDESTRIAN CROSSING SIGN (CALTRANS SIGN R1-6)
 - 37) NO PARKING SIGNS (CALTRANS SIGN R28 (CA))



SHEET NUMBER C-06.02 PROJECT/JOB NUMBER

ST-07-25



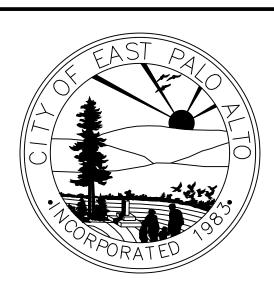

2" GRIND AND 2" OVERLAY

2" A.C. OVERLAY


SHEET NOTES

- 1 PROTECT IN PLACE
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- 3 RAISE COMMUNICATION VAULT
- 4 RAISE MONUMENTS
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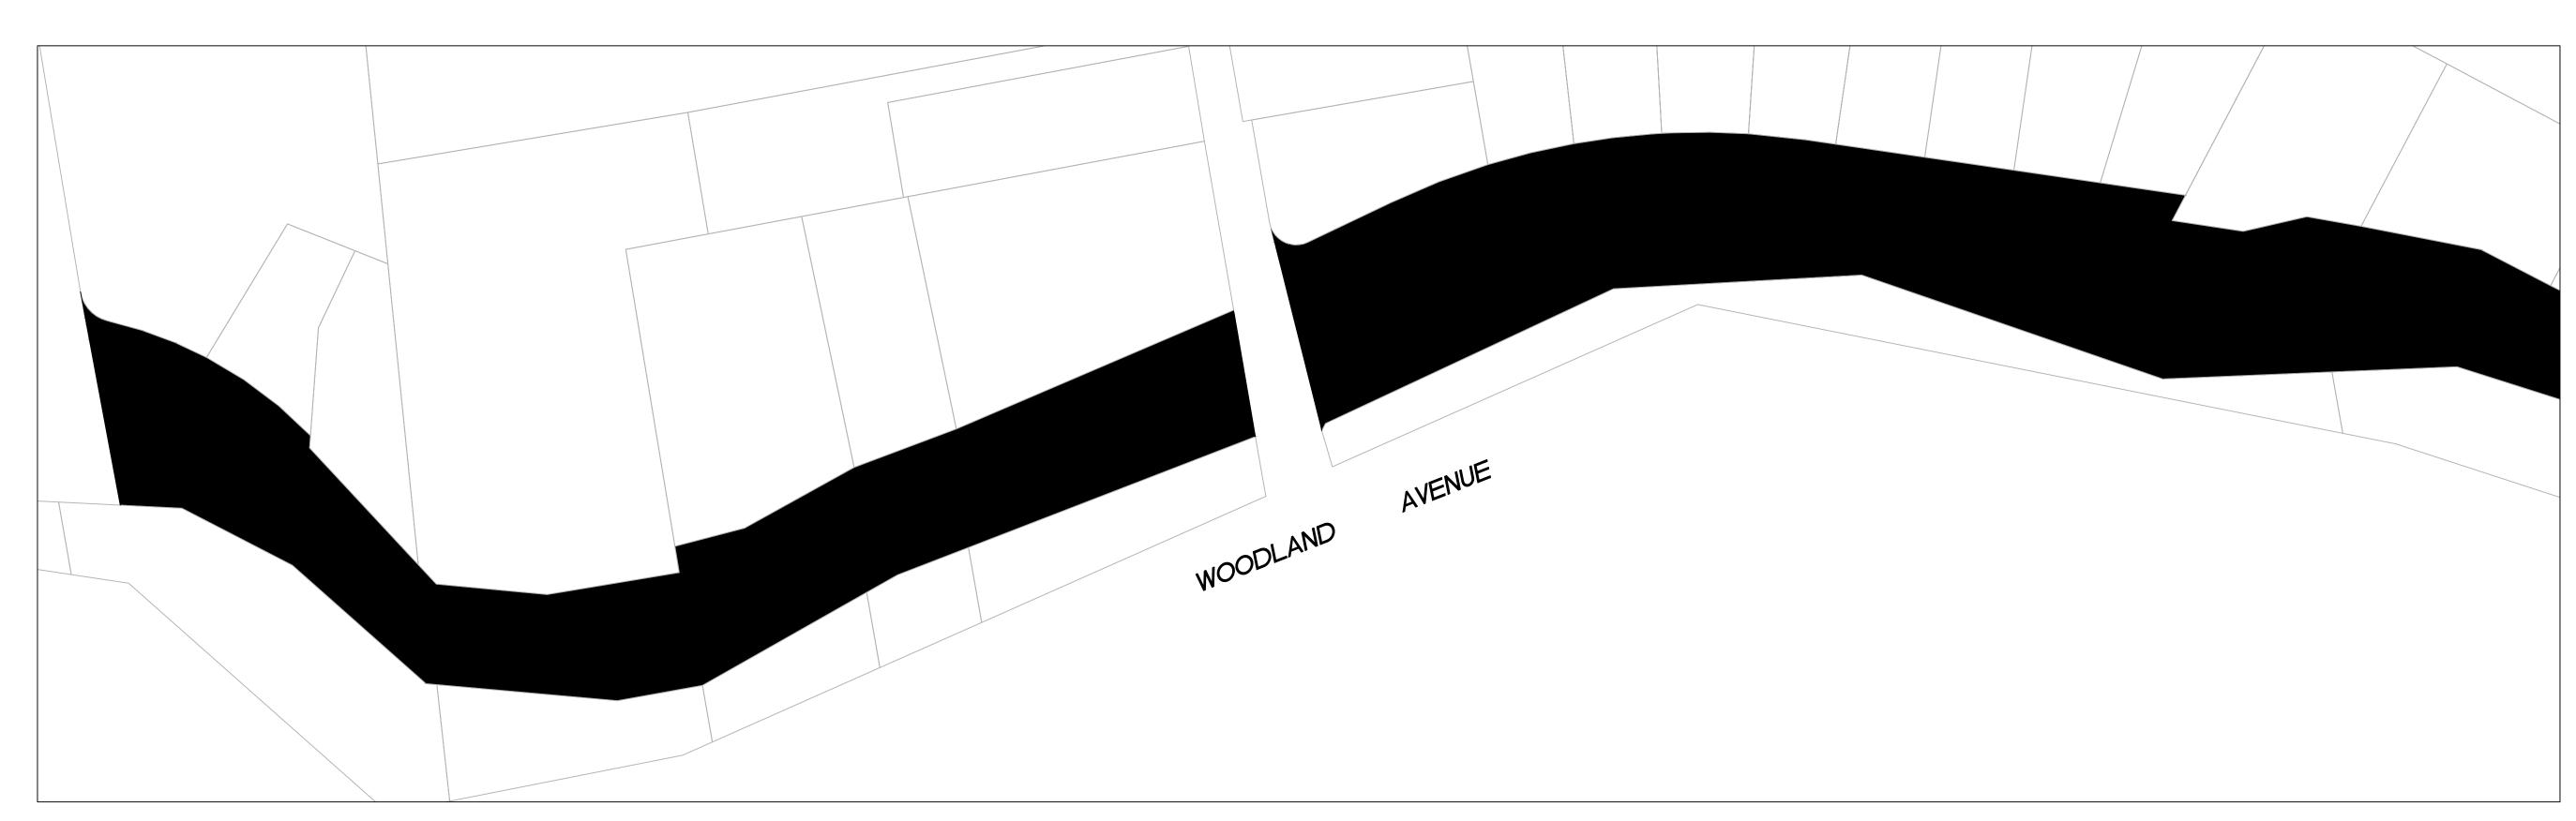


	SHEET TITLE	PREPARED BY	CHECKED BY	NO.	DESCRIPTION OF REVISION	DATE
	WILLOW AND		N. JAVED / B. ZAKO			
C	WOODSIDE NEIGHBORHOOD		DESIGNED/DRAFTED BY			
:-0		CIT OF EAST PALO ALLO	M. CORIEZ			
6.0	PROJECT/JOB TITLE		SCALE			
3	ANNUAL STREET RESURFACING		NO CHOWIN			
	PROJECT 2024-2025		LAST REVISION			
			4707/07/			

PROJECT/JOB NUMBER

ST-07-25

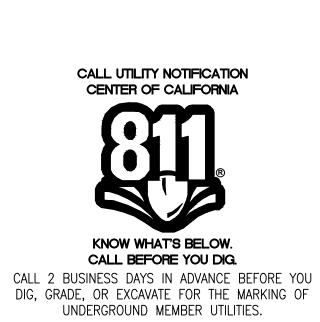



2" GRIND AND 2" OVERLAY

2" A.C. OVERLAY

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KNOW WHAT'S BELOW. CALL BEFORE YOU DIG. CALL 2 BUSINESS DAYS IN ADVANCE BEFORE YOU DIG, GRADE, OR EXCAVATE FOR THE MARKING OF UNDERGROUND MEMBER UTILITIES.

CALL UTILITY NOTIFICATION CENTER OF CALIFORNIA

WOODSIDE NEIGHBORHOOD SHEET NUMBER C-06.04

PROJECT/JOB NUMBER

ST-07-25

