# **WOODLAND PARK - EUCLID IMPROVEMENTS**

### VICINITY MAP



APPLICANT:

Woodland Park Communities 5 Newell Court East Palo Alto, CA 94303 ATTN: Michael Kramer mkramer@wlpcommunities.com

### **ARCHITECT:**

David Baker Architects 461 2nd Street, Loft C-127 San Francisco, CA 94107 ATTN: Daniel Simons danielsimons@dbarchitect.com

### LANDSCAPE ARCHITECT:

Hood Design Studio 3016 Filbert Street #2 Oakland, CA 94608 ATTN: Alma du Solier alma@hooddesignstudio.com

### **CIVIL ENGINEER:**

**BKF Engineers** 1730 N. First Street. Suite 600 San Francisco, CA 94112 ATTN: Jacbon Nguyen jnguyen@bkf.com

# PROJECT DESCRIPTION

With <u>no displacement</u>, this project proposes the replacement of several aging, outdated structures containing 160 rent-stabilized housing units and one single family rental (non-RSO) with new mixed-income buildings containing 550 apartments, 29% of which will be deed-restricted rentcontrolled, replacing the existing apartments one-for-one.

Note: No portion of the property is located in a Flood Zone as designated by the Federal Emergency Managment Agency (FEMA).

# **PROJECT SITE**

ZONING: R-HD-5, R-UHD, Neighborhood Center Overlay (NCO)

GENERAL PLAN DESIGNATION: HIGH DENSITY RESIDENTIAL / URBAN RESIDENTIAL, NEIGHBORHOOD CENTER OVERLAY

TOTAL SITE AREA: 170,941 SF = 3.92 ACRES

### **EXISTING LOTS:**

ADDRESSES:	APNS:
501 O'Connor St.	063282010
2012 Euclid Ave.	063282020
2032 Euclid Ave.	063282030
2036 Euclid Ave.	063282040
2040 & 2042 Euclid Ave.	063282050
2044 Euclid Ave.	063282060
2054 Euclid Ave.	063282070
2033 Manhattan Ave.	063282080
2001 Manhattan Ave.	063282090
2021 Euclid Ave.	063281020
2025 Euclid Ave.	063281030
2031 Euclid Ave.	063281040
2043 Euclid Ave.	063281100
2041 Euclid Ave./420 E O'Keefe St.	063281110

# SHEET INDEX

### GENERAL

G-000	TITLE SHEET
G-100	CONTEXT
G-101	PERSPECTIVE VIEWS
G-102	PERSPECTIVE VIEWS
G-103	AERIAL VIEW
G-200	FIRE DIAGRAMS
G-201	CODE ANALYSIS - GENERAL
G-202	PLANNING DIAGRAMS

### ARCHITECTURE

ARCHII	ECTURE
A-100	SITE PLAN - EXISTING
A-101	SITE PLAN - PROPOSED
A-201	FLOOR PLAN - LEVEL 1
A-202	FLOOR PLAN - LEVEL 2
A-203	FLOOR PLAN - LEVEL 3
A-204	FLOOR PLAN - LEVEL 4
A-205	FLOOR PLAN - LEVELS 5-7
A-206	FLOOR PLAN - LEVELS 8
A-207	FLOOR PLAN - ROOF
A-300	BUILDING ELEVATIONS
A-301	BUILDING ELEVATIONS
A-302	BUILDING SECTIONS
A-303	EXTERIOR MATERIALS
A-500	OPEN SPACE DIAGRAMS
A-502	OPEN SPACE DIAGRAMS
A-511	CONCEPTUAL LIGHTING PLAN

### LANDSCAPE

L-1.0	LANDSCAPE SITE PLAN

- LANDSCAPE DETAILS L-1.1
- L-2.1 PLANTING PLAN
- TREE PROTECTION AND REMOVALS LIST AND T-0.1 NOTES
- T-1.1 TREE PROTECTION & REMOVAL PLAN

### CIVIL

C-1.0	EXISTING CONDITIONS AND DEMOLITION PLAN
C-2.0	PRELIMINARY SITE PLAN
C-3.0	PRELIMINARY GRADING AND DRAINAGE PLAN
C-4.0	PRELIMINARY UTILITY PLAN
C-5.0	PRELIMINARY STORMWATER MANAGEMENT PLAN
C-5.1	PRELIMINARY STORMWTER MANAGEMENT PLAN
C-6.0	PRELIMINARY FIRE ACCESS PLAN
TM-1	VESTING TENTATIVE PARCEL MAP - TITLE SHEET
TM-2	VESTING TENTATIVE PARCEL MAP - MAPPING SHEET

### OTHER

### WT-001 WATER TANK EXHIBIT

# **PROJECT DATA**

### **GROSS AREAS**

CIRCULATION	52448 SF
COMMON	31837 SF
COMMUNITY SPACE	2500 SF
GARAGE / BIKE ROOM	139931 SF
RESIDENTIAL	418642 SF
RETAIL	2619 SF
SERVICE / TRASH	9455 SF
STAIRS / ELEVATORS	12831 SF
	670262 SF

### UNIT MIX

TYPE	EXISTING*	MIX	APPROVED	MIX	REVISED	MIX	AVG. AREA
STUDIO	53	33%	228	38%	21**	4%	495 sf
1 BR	102	64%	197	33%	343	62%	688 sf
2 BR	4	2%	178	29%	184	33%	977 sf
3 - 4 BR	2	<1%	2	<1%	2	<1%	1,298 sf
TOTAL	161		605		550		
					•		

\* There are 160 current rent-stabilized units and one 2 BR single-family rental (non-RSO)

\*\* 32 existing studios will be replace by 1 BR units

### PARKING

STALLS	EXISTING	APPROVED	REVI
			BUILDING A
OFF-STREET	155	625	136
ON-STREET	52	52	7

(14 of the proposed parking stalls are ADA, including 4 ADA van spaces)

Approved Parking Ratio = 1.03 spaces/unit Revised Parking Ratio = 1.03 spaces/unit Building A Parking Ratio = 1.03 spaces/unit Building B Parking Ratio = 1.03 spaces/unit

### LOT COVERAGE CALCULATIONS

BUILDING A LOT COVERAGE LOT AREA = 31,596 SF 18,853 SF / 31,596 SF = **59%** 

BUILDING B LOT COVERAGE TOTAL LOT AREA = 139,345 SF 89,544 SF / 139,345 SF = **64%** 

TOTAL LOT COVERAGE 108,397 / 170,941 SF = 63%

### F.A.R. REQUIRED: N/A

(PER DEVELOPMENT CODE SECTION 18.10 TABLE 2-2)


### ZONING COMPARISON

Development Standard	NCO Zone / GP Designation Requirement	Approved Project (Nov 2022)	Revised Project (Apr 2024)
Maximum Density	175 du/acre	155 du/acre	140.3 du/acre
Height	13 stories / 140 feet	13 stories / 135 feet	8 stories / 85 feet
Open Space	100 sf/unit	100 sf/unit	103 sf/unit or greater
Setbacks*			
Front	5 feet	9-12 feet	5-10 feet
Side/Street Side	5 feet	10-85 feet	5-143 feet
Rear	10 feet	10-20 feet	10-83 feet
Corner vision triangle	12 feet	12 feet	12 feet

\*Front Setback areas: Building B - W. Bayshore Rd.

Building A - E. O'Keefe St.

# Woodland Park Euclid Improvements

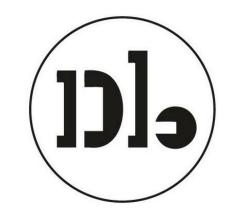

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/ISED BUILDING B 434

### **BIKE PARKING** REQ PER EPAMC:

1 CLASS I SPACE FOR EVERY 3 UNITS = 183 CLASS I 1 CLASS II SPACE FOR EVERY 15 UNITS = 36 CLASS II

PROVIDED

CLASS I: BUILDING A: 72 STALLS (ONE BIKE ROOM) BUILDING B: 252 STALLS (TWO BIKE ROOMS) TOTAL: 324 STALLS PROVIDED

CLASS II: 45 STALLS PROVIDED ON SITE

### **OPEN SPACE**

	AREA
COMMON OPEN SPACE	31,932 SF
PRIVATE OPEN SPACE	24,854 SF
Total	56,786 SF
Open space per unit (excluding Public Open Space)	103 SF/UNIT
PUBLIC OPEN SPACE	10,769 SF
PUBLIC PARK	9,355 SF

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Description	Date
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Rev.	Description	Date

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TITLE SHEET

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1 - Intersection of West Bayshore Road and Euclid Avenue, Looking East



4 - Intersection of Manhattan Avenue and O'Connor Street, Looking North



7 - Euclid Avenue, Looking South




2 - West Bayshore Road, Looking East




3 - Intersection of West Bayshore Road and Manhattan Avenue, Looking South



5 - Manhattan Avenue, Looking North

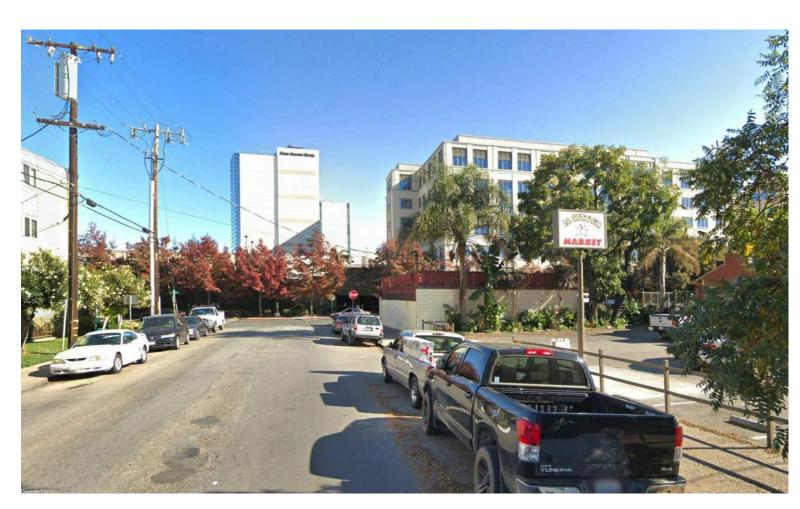

6 - O'Connor Street, Looking East

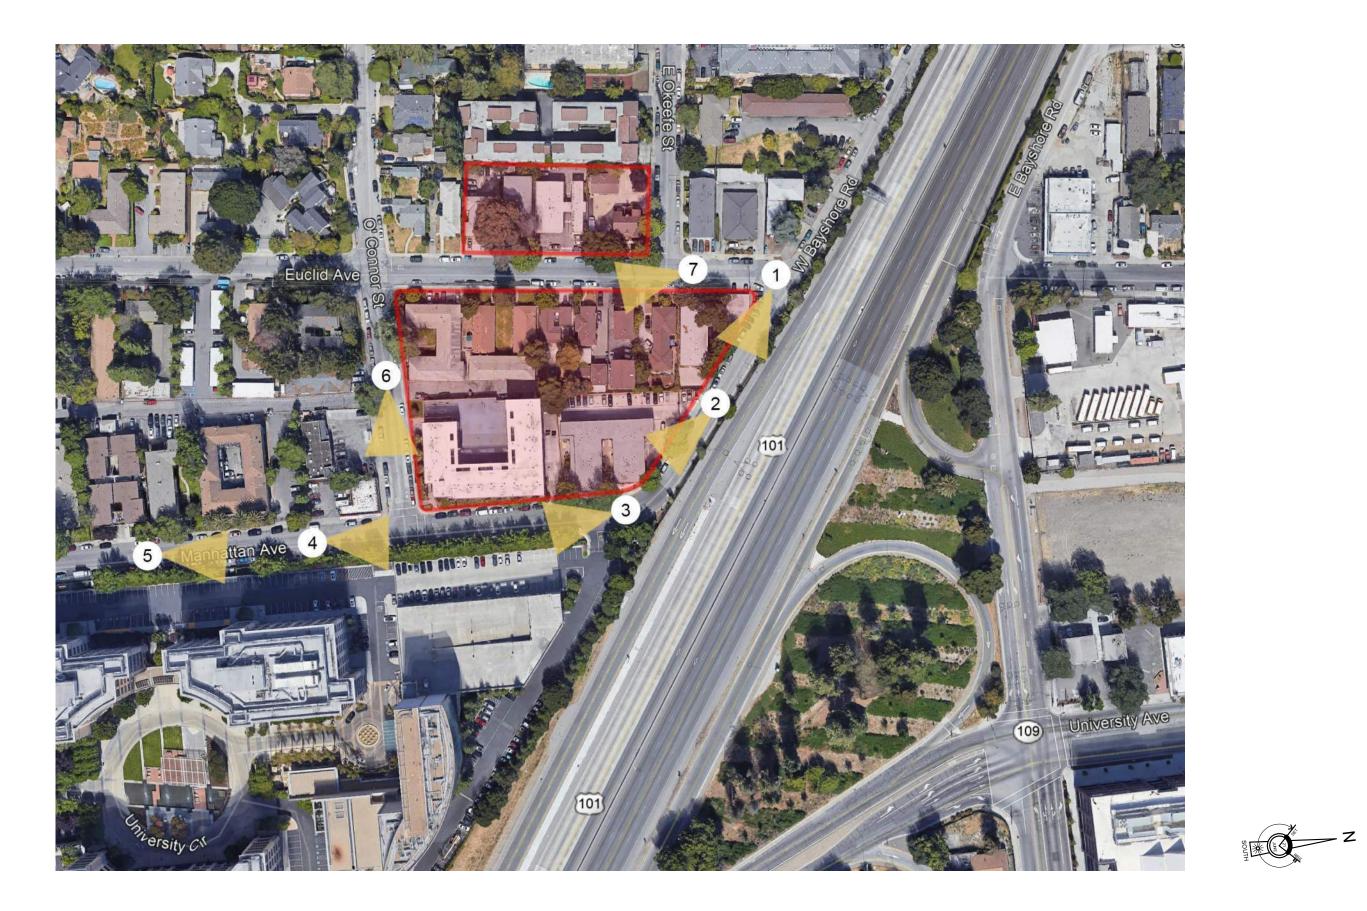

# Woodland Park Euclid Improvements



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# PREVIOUSLY SUBMITTED SHEET NO CHANGE

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Revisions

Date

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Application -September 2019

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CONTEXT

Sheet No. G100

Date Project No. 08-23-2022 21620



1- VIEW OF PARK FROM O'CONNOR ST.



2- VIEW OF EUCLID LOOKING TOWARDS O'KEEFE ST.

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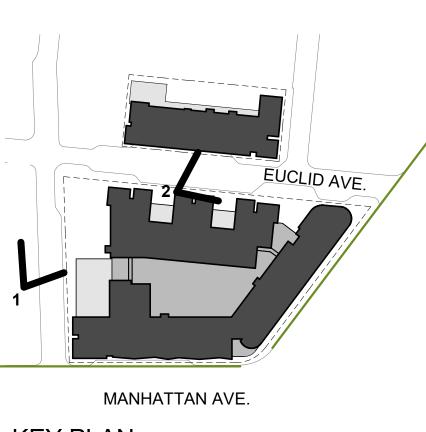
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PERSPECTIVE VIEWS

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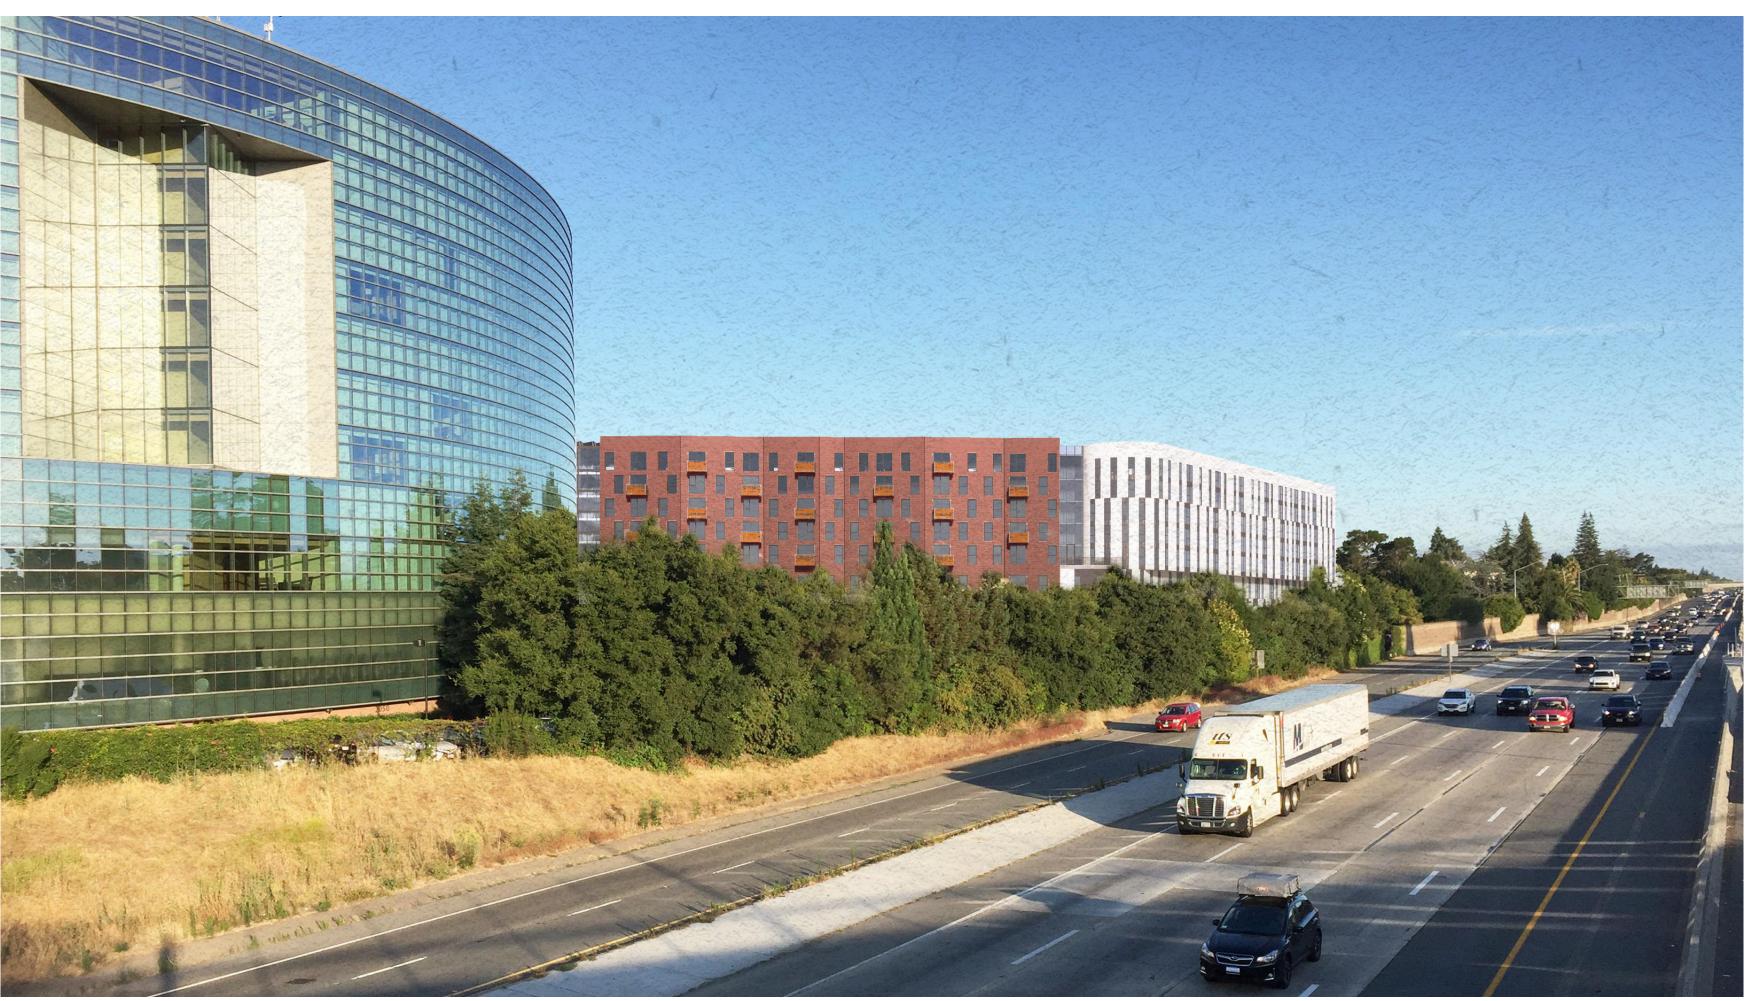


KEY PLAN

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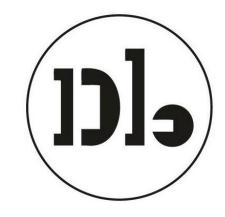


1- VIEW DOWN EUCLID AVE. LOOKING NORTH



2- VIEW FROM US 101/ UNIVERSITY AVE OVERPASS (FOUR SEASONS HOTEL IN FOREGROUND)

# Woodland Park Euclid Improvements



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		Revisions
Rev.	Description	Date
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PERSPECTIVE VIEWS

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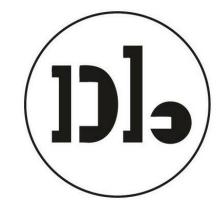
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EUCLID AVE. MANHATTAN AVE.  $\mathbf{N}$ KEY PLAN 2







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Rev.	Description	Date

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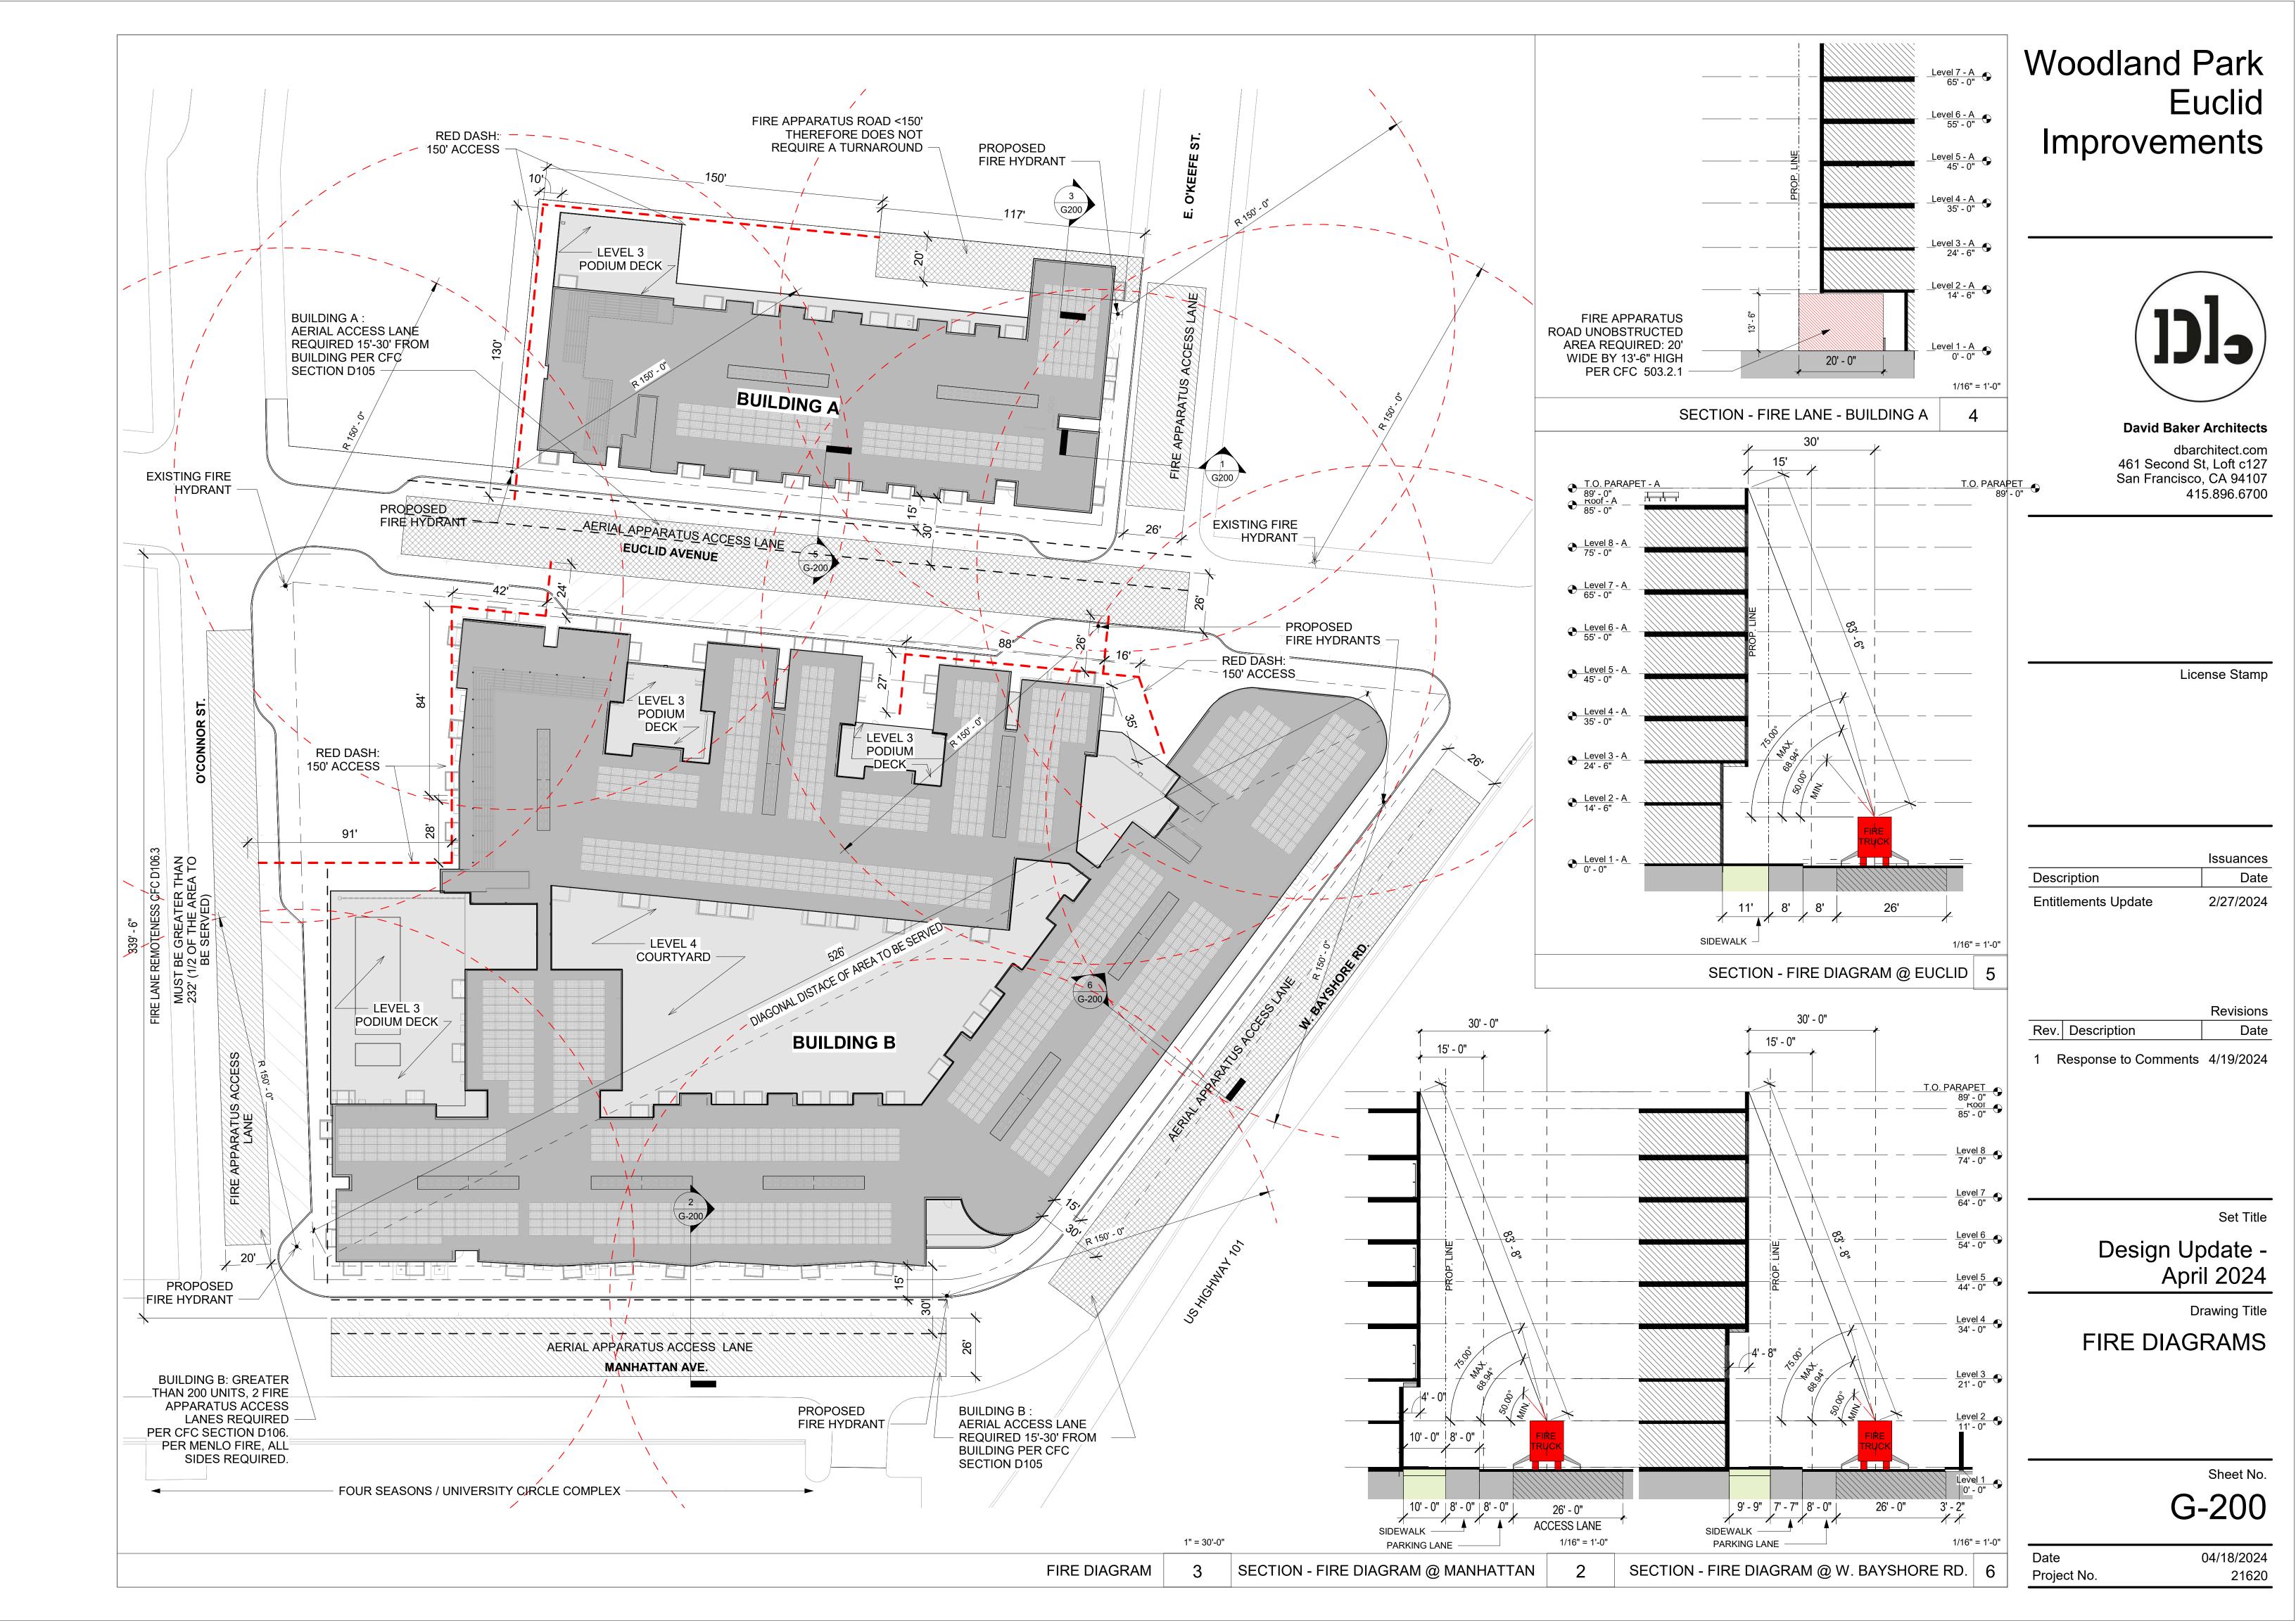
AERIAL VIEW


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Date Project No. 04/18/2024 21620

# PROJECT





### CODE ANALYSIS - SECTION - BUILDING B (NORTH SOUTH)
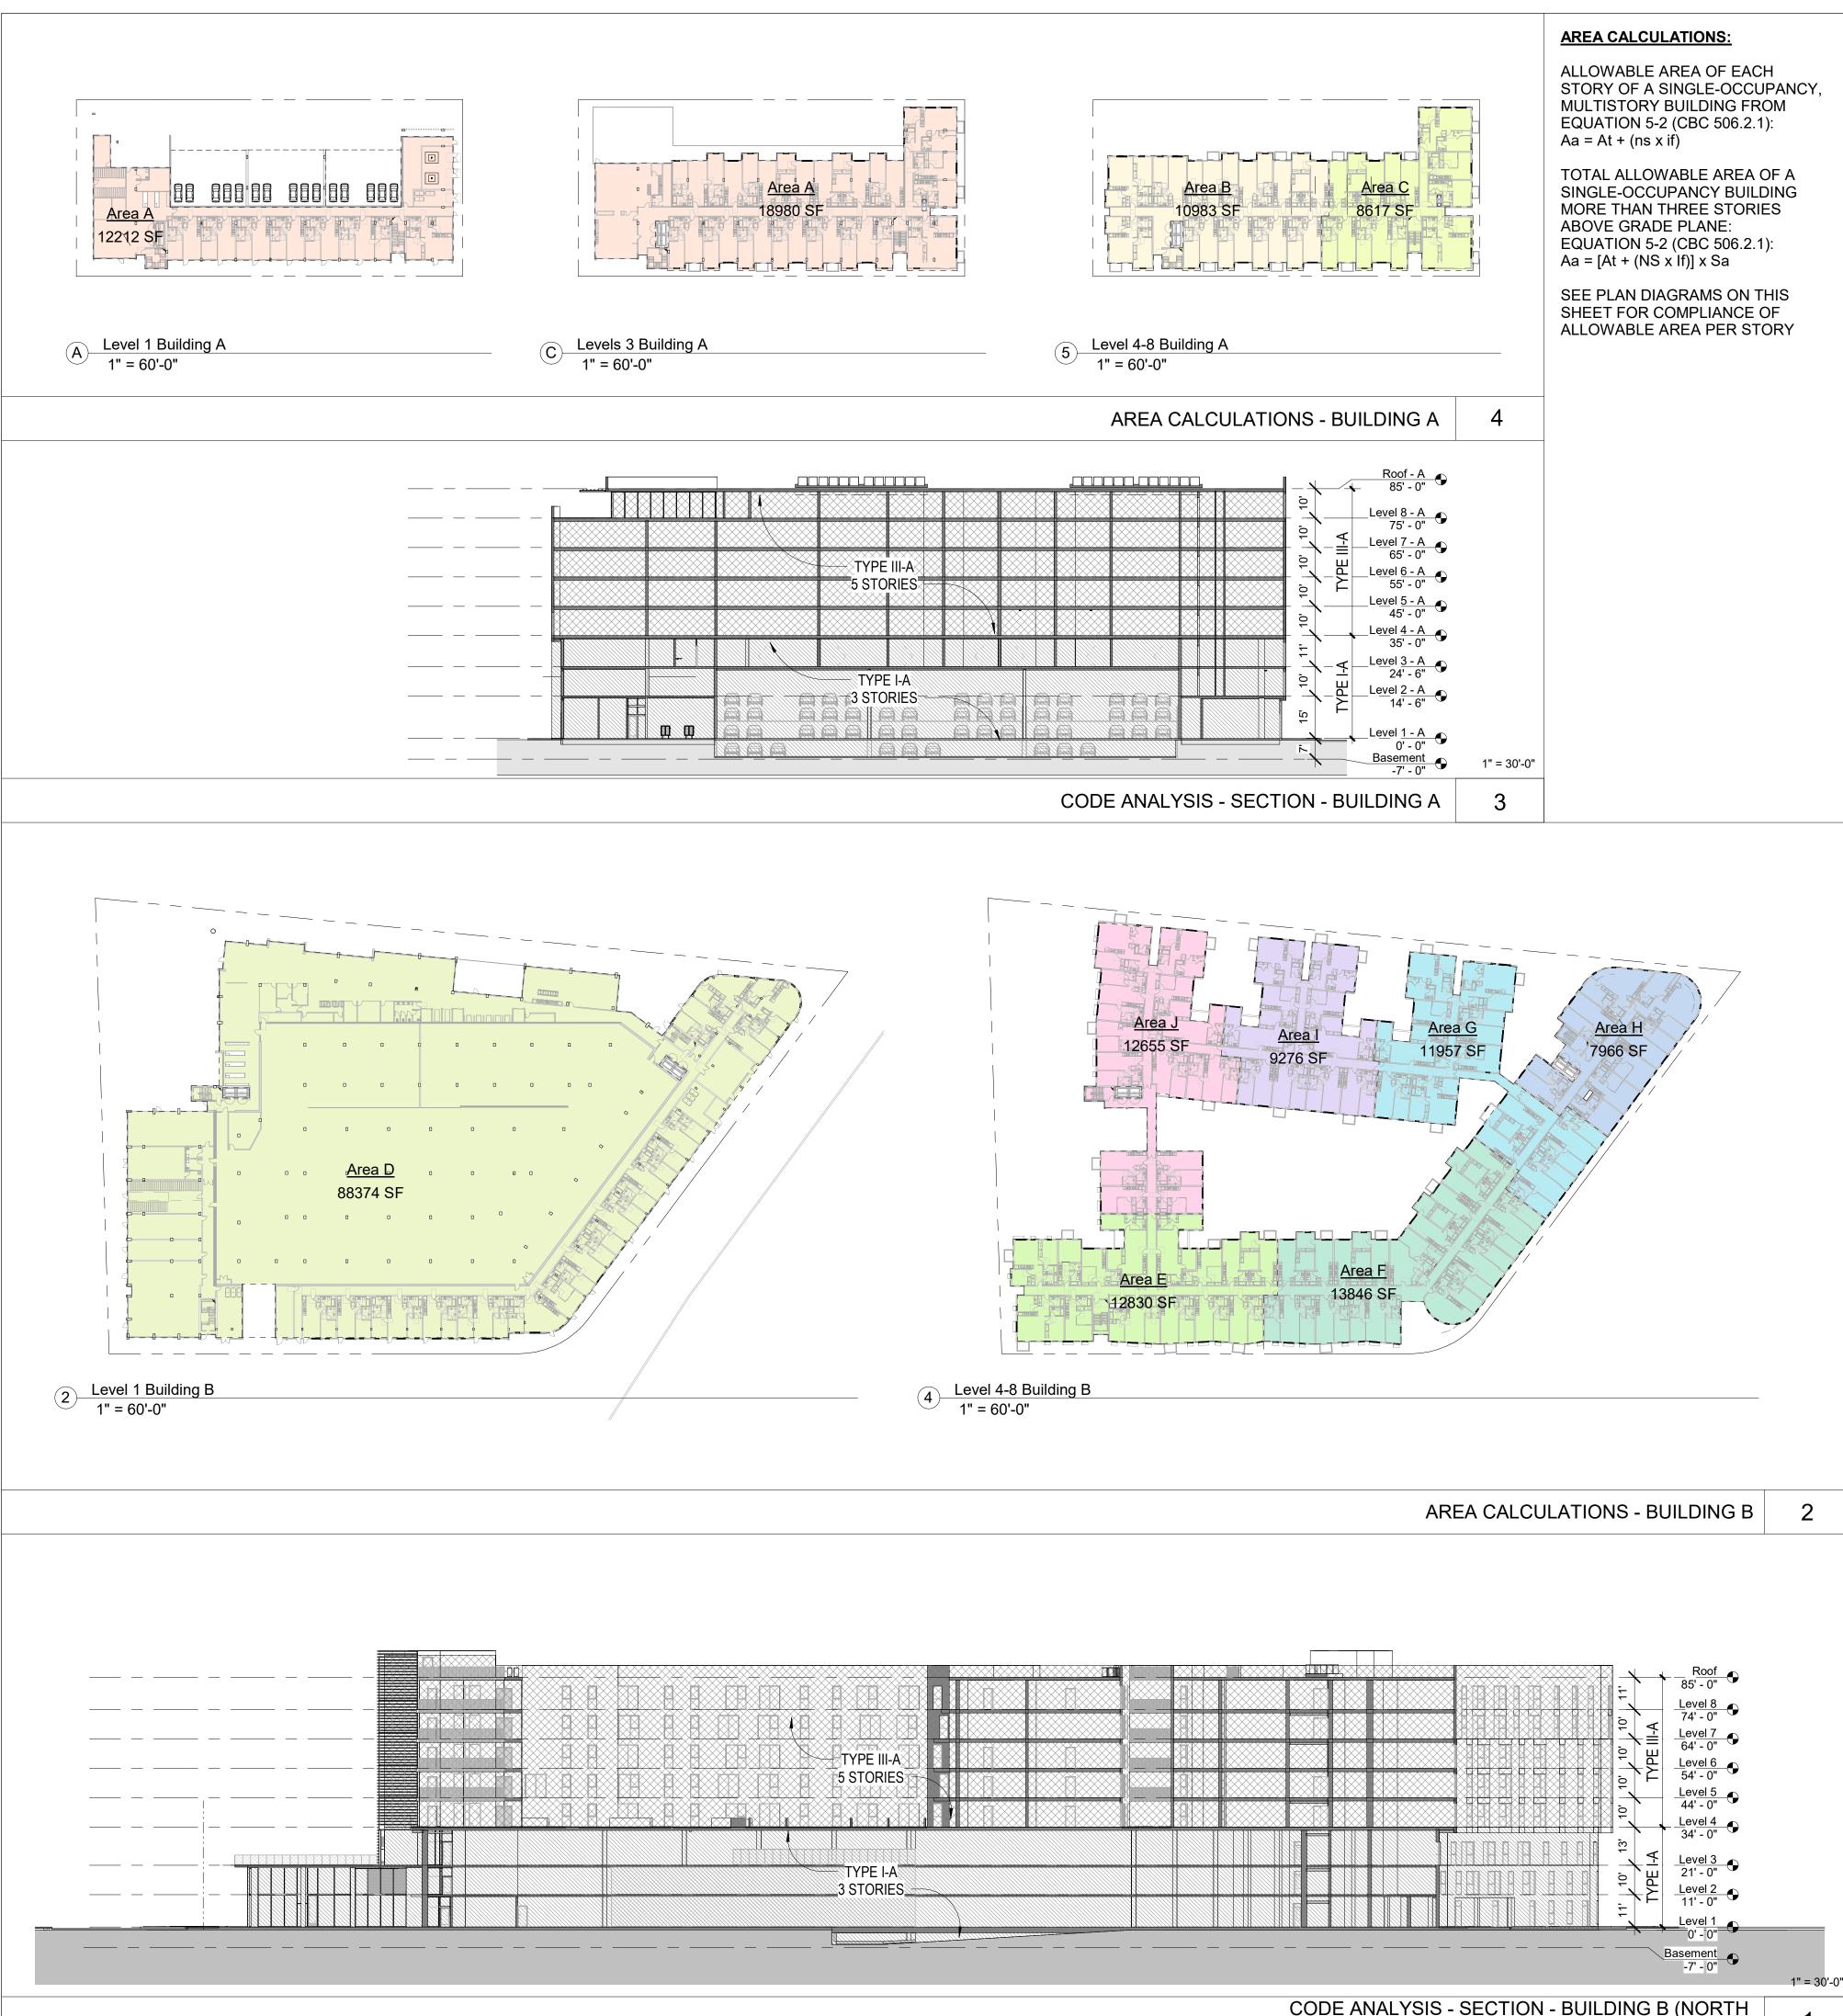
# **BUILDING A**

### AREAS:

BUILDING AREA A (TYPE I-A): ALLOWABLE BUILDING AREA IS UNLIMITED

TOTAL AREA: Area A 45215 SF

ALLOWABLE BUILDING AREA IS UNLIMITED FOR TYPE I-A CONSTRUCTION, THEREFORE COMPLIES

### **BUILDING AREA B (TYPE III-A)**: ALLOWABLE AREA OF PER STORY At + (ns x if) = Aa

TOTAL ALLOWABLE AREA

24,000 + (24,000 x.5) = **36,000 SF** [At + (NS x If)] x Sa = Aa [24,000 + (24,000 x 0.5)] x 2 = **72,000 SF** 

52478 SF TOTAL AREA: Area B

BUILDING AREA B: < 72,000 SF THEREFORE **COMPLIES** 

# **BUILDING AREA C (TYPE III-A)**: ALLOWABLE AREA OF PER STORY At + (ns x if) = Aa

TOTAL ALLOWABLE AREA

24,000 + (24,000 x.5) = **36,000 SF**  $[At + (NS \times If)] \times Sa = Aa$ [24,000 + (24,000 x 0.5)] x 2 = **72,000 SF** 

TOTAL AREA: Area C 42730 SF

BUILDING AREA C: < 72,000 SF THEREFORE **COMPLIES** 

# **BUILDING B**

### AREAS:

BUILDING AREA D (TYPE I-A): ALLOWABLE BUILDING AREA IS UNLIMITED

TOTAL AREA: Area D 261481 SF

ALLOWABLE BUILDING AREA IS UNLIMITED FOR TYPE I-A CONSTRUCTION, THEREFORE COMPLIES

### BUILDING AREA E (TYPE III-A):

ALLOWABLE AREA OF PER STORY At + (ns x if) = Aa TOTAL ALLOWABLE AREA

24,000 + (24,000 x.5) = **36,000 SF**  $[At + (NS \times If)] \times Sa = Aa$  $[24,000 + (24,000 \times 0.5)] \times 2 = 72,000 \text{ SF}$ TOTAL AREA: Area E 64150 SF

BUILDING AREA E: < 72,000 SF THEREFORE **COMPLIES** 

# **BUILDING AREA F (TYPE III-A)**: ALLOWABLE AREA OF PER STORY At + (ns x if) = Aa

TOTAL ALLOWABLE AREA

24,000 + (24,000 x.5) = **36,000 SF** [At + (NS x lf)] x Sa = Aa [24,000 + (24,000 x 0.5)] x 2 = **72,000 SF** 

TOTAL AREA: Area F 69228 SF

BUILDING AREA F: < 72,000 SF THEREFORE **COMPLIES** 

# **BUILDING AREA G (TYPE III-A)**: ALLOWABLE AREA OF PER STORY At + (ns x if) = As

ALLOWABLE AREA OF PER		· · · · ·	
			x.25) = <b>30,000 SF</b>
TOTAL ALLOWABLE AREA	-	At + (NS x If)] x \$	
	[2	24,000 + (24,000	0 x 0.25)] x 2 = <b>60,000 SF</b>
			1
TOTAL AREA:	Area G	59709 SF	
			1
BUILDING AREA	A G: < 60,0	000 SF THEREF	ORE <b>COMPLIES</b>

**BUILDING AREA H (TYPE III-A)**: ALLOWABLE AREA OF PER STORY At + (ns x if) = Aa 24,000 + (24,000 x.75) = **42,000 SF**  $[At + (NS \times If)] \times Sa = Aa$ TOTAL ALLOWABLE AREA  $[24,000 + (24,000 \times 0.75)] \times 2 = 84,000 \text{ SF}$ 

TOTAL AREA: Area H 39829 SF BUILDING AREA H: < 84,000 SF THEREFORE **COMPLIES** 

<b>BUILDING AREA I (TYPE III-</b>	<b>A)</b> :			
ALLOWABLE AREA OF PER	STORY	At +	(ns x if) = Aa	a
		24,0	00 + (24,000	) x.5) = <b>36,000 SF</b>
TOTAL ALLOWABLE AREA		[At +	· (NS x lf)] x	Sa = Aa
		[24,0	00 + (24,00	0 x 0.5)] x 2 = <b>72,000 SF</b>
				7
TOTAL AREA:	Area I		46380 SF	
				_
BUILDING AREA	Al: < 72,0	000 5	SF THEREFO	ORE <b>COMPLIES</b>

**BUILDING AREA J (TYPE III-A)**: ALLOWABLE AREA OF PER STORY At + (ns x if) = Aa

TOTAL ALLOWABLE AREA

24,000 + (24,000 x.5) = **36,000 SF**  $[At + (NS \times If)] \times Sa = Aa$ [24,000 + (24,000 x 0.5)] x 2 = **72,000 SF** 

TOTAL AREA: Area J 59523 SF

BUILDING AREA J: < 72,000 SF THEREFORE **COMPLIES** 

# Woodland Park Euclid Improvements



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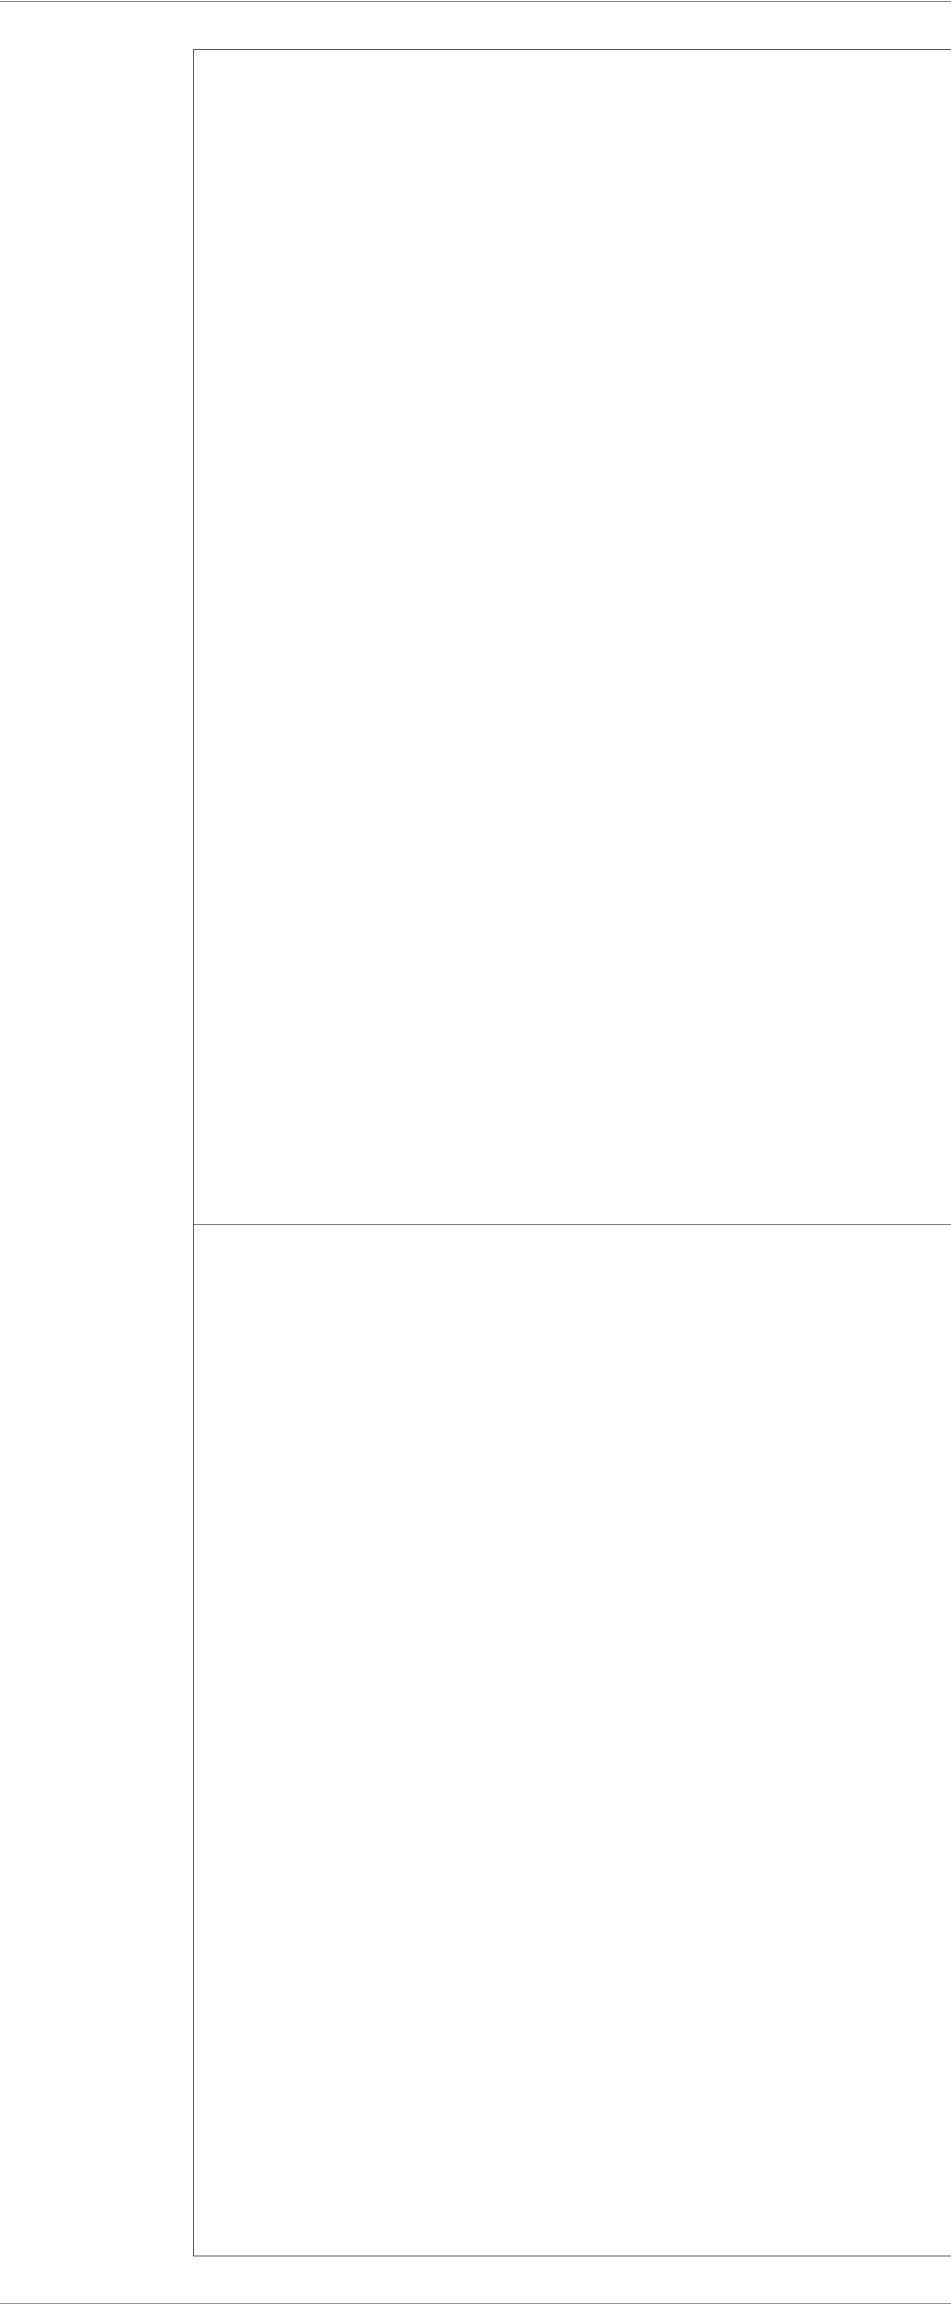
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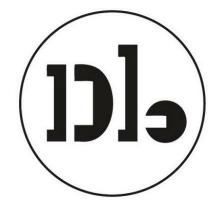


# BUILDING A LOT COVERAGE

ALLOWABLE ALLOWABLE LOT COVERAGE = 70% MIN (PER EPAMC 18.10.030)

**ACTUAL** LOT AREA = 31,596 SF BUILDING FOOTPRINT: **BUILDING A** 18853 SF ACTUAL LOT COVERAGE = 59%

# Woodland Park Euclid Improvements



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# BUILDING B LOT COVERAGE

**ALLOWABLE** ALLOWABLE LOT COVERAGE = 70% (PER EPAMC 18.10.030)

**ACTUAL** LOT AREA = 139,345 SF BUILDING FOOTPRINT: **BUILDING B** 89544 SF ACTUAL LOT COVERAGE = 64%

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	Issuances
Description	Date
Entitlements Update	2/27/2024

		Revisions
Rev.	Description	Date

1 Response to Comments 4/19/2024

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PLANNING DIAGRAMS

Sheet No.

Date Project No.





2021 Euclid Avenue (11 rent-stabilized units)

11 x Studio Units

2025 Euclid Avenue (7 rent-stabilized units)

6 x Studio Units 1 x 1 Bedroom Unit

2031 Euclid Avenue (12 rent-stabilized units)

12 x 1 Bedroom Units

2032 Euclid Avenue

1 x 2 Bedroom Single-Family-House (non-RSO)

2036 Euclid Avenue (4 rent-stabilized units)

2 x Studio Units 1 x 1 Bedroom Unit 1 x 2 Bedroom Unit

2040 & 2042 Euclid Avenue (2 rent-stabilized units)

1 x 2 Bedroom Unit 1 x 4 Bedroom Unit

2041 Euclid Avenue (also known as 420 O'Keefe)

Community Engagement Office

### 2043 Euclid Avenue

Resident Services Office and Community Technology Center

2044 Euclid Avenue (2 rent-stabilized units)

1 x 2 Bedroom Unit 1 x 3 Bedroom Unit

2054 Euclid Avenue (8 rent-stabilized units)

8 x 1 Bedroom Units

2012 Euclid Avenue/501 O'Connor Street (22 rent-stabilized units)

22 x 1 Bedroom Units

2001 Manhattan Avenue (60 rent-stabilized units)


> 8 x Studio Units 52 x 1 Bedroom Units

2033 Manhattan Avenue (32 rent-stabilized units)

26 x Studio Units 6 x 1 Bedroom Units

SOUTH Z 0' 7.5' 15' 30'

# Woodland Park Euclid Improvements

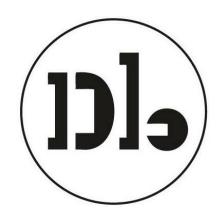

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Application -September 2019


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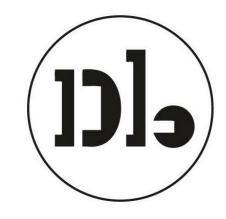
SITE PLAN -EXISTING

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Date Project No. 08-23-2022 21620





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	Issuances
Description	Date
Entitlements Update	2/27/2024

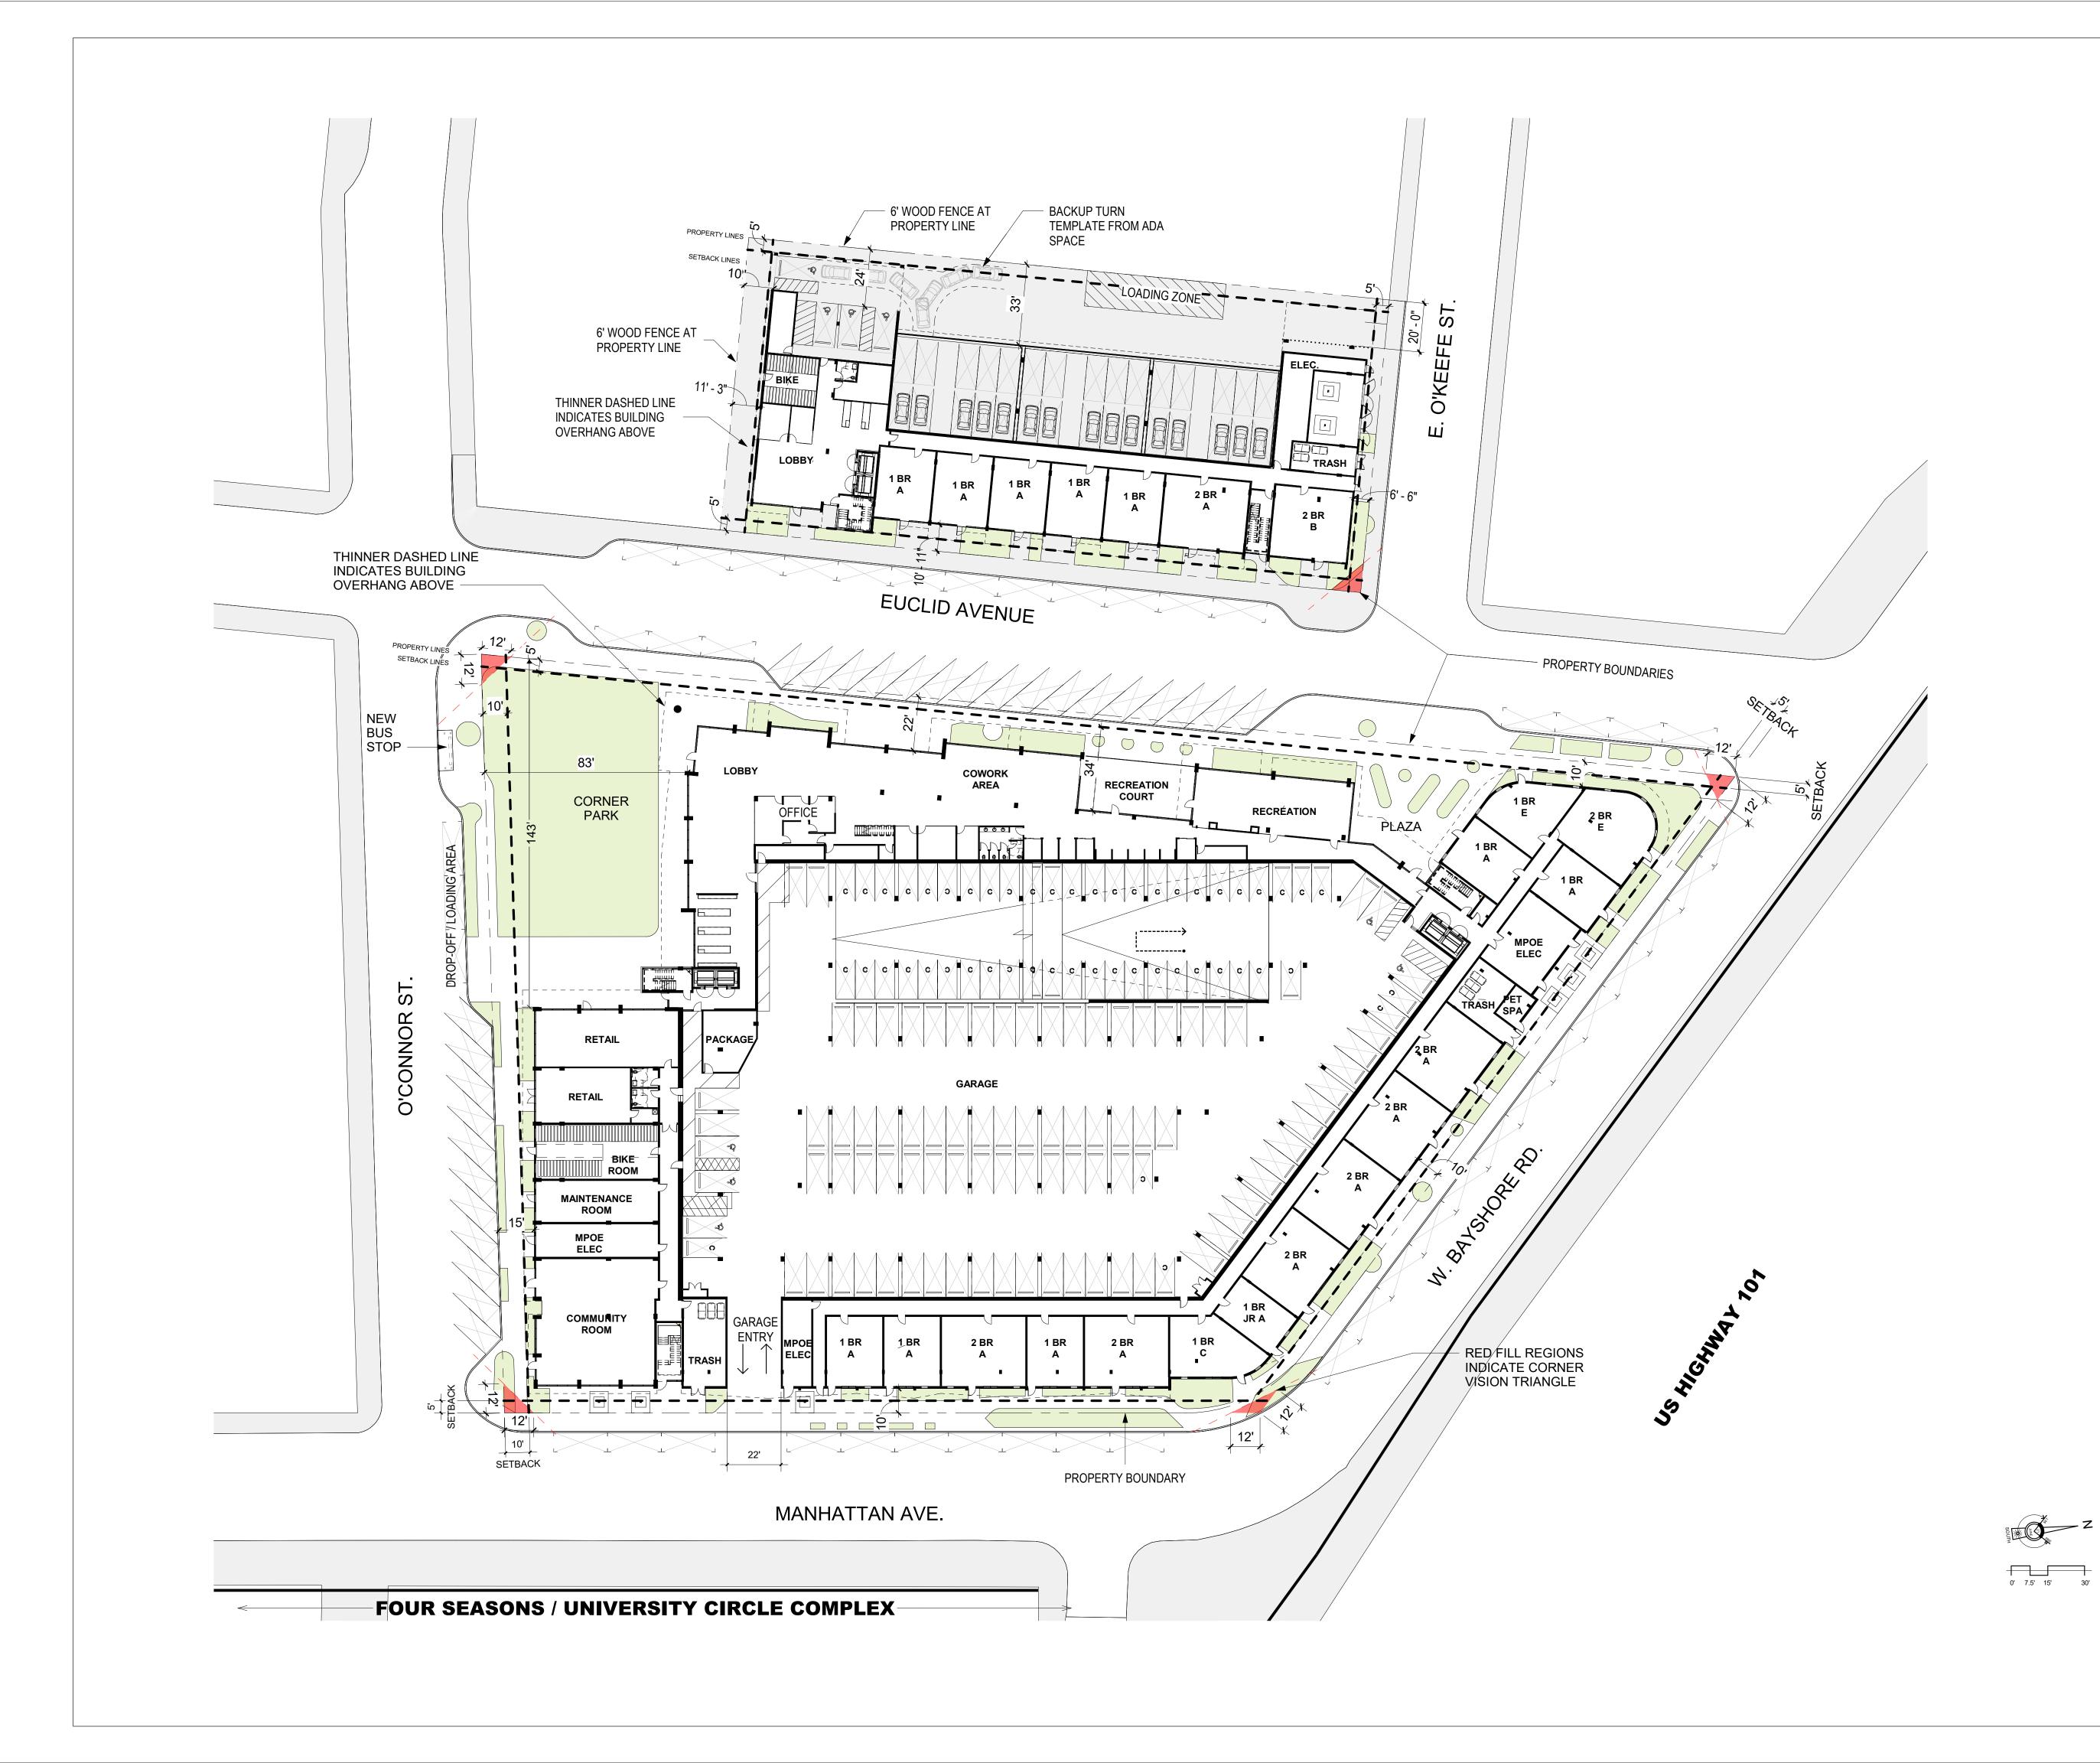		Revisions
Rev.	Description	Date
1 F	Response to Comments	4/19/2024

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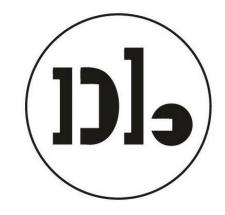
SITE PLAN -PROPOSED

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	Issuances
Description	Date
Entitlements Update	2/27/2024

		Revisions
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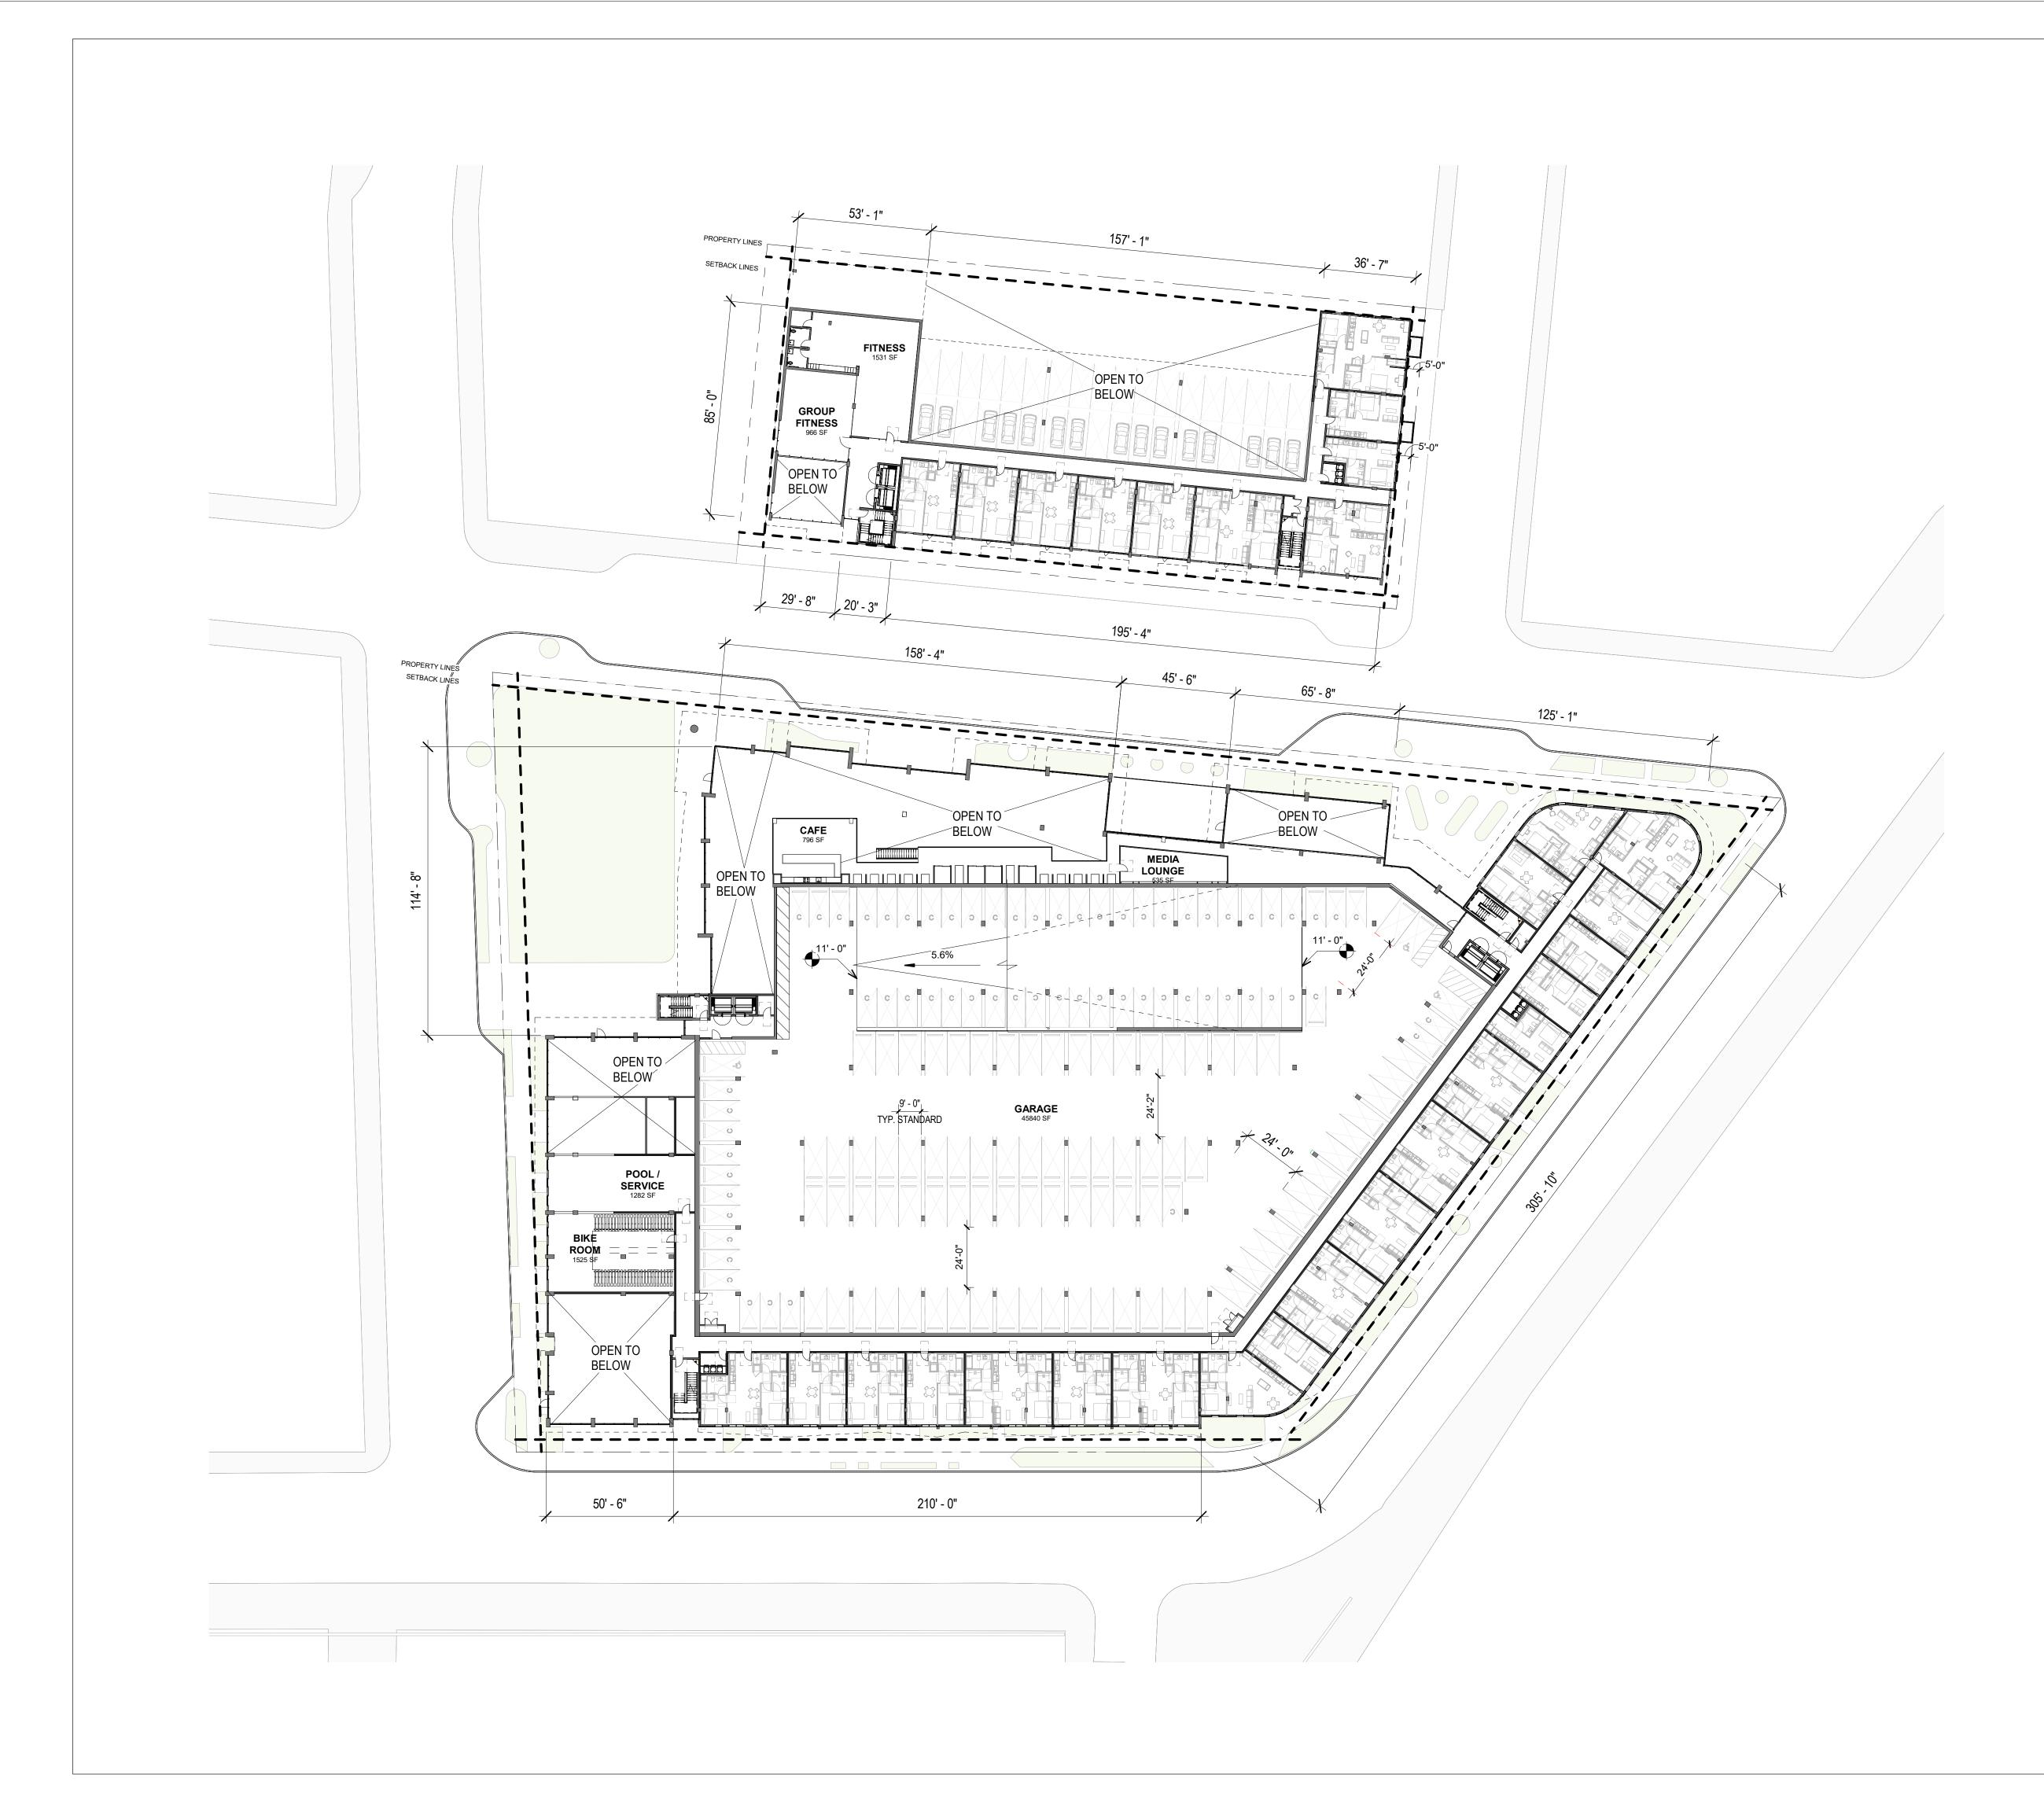
FLOOR PLAN -LEVEL 1


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SOUTH Z

0' 7.5' 15' 30'





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	Issuances
Description	Date
Entitlements Update	2/27/2024
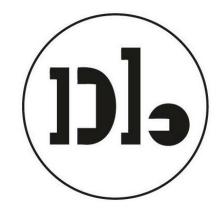
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FLOOR PLAN -LEVEL 2


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SOUTH Z

0' 7.5' 15' 30'





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Description	Date
Entitlements Update	2/27/2024

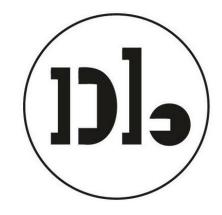		Revisions
Rev.	Description	Date

1 Response to Comments 4/19/2024

Set Title

Design Update -April 2024

Drawing Title

FLOOR PLAN -LEVEL 3

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SOUTH Z

0' 7.5' 15' 30'



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	Issuances
Description	Date
Entitlements Update	2/27/2024

		Revisions
Rev.	Description	Date

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Drawing Title

FLOOR PLAN -LEVEL 4

Sheet	No.

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Project No.	

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C 7.5' 15' 30'



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Entitlements Update	2/27/2024

		Revisions
Rev.	Description	Date

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Drawing Title

FLOOR PLAN -LEVELS 5-7

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SOUTH Z 0' 7.5' 15' 30'



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Description	Date
Entitlements Update	2/27/2024

		Revisions
Rev.	Description	Date

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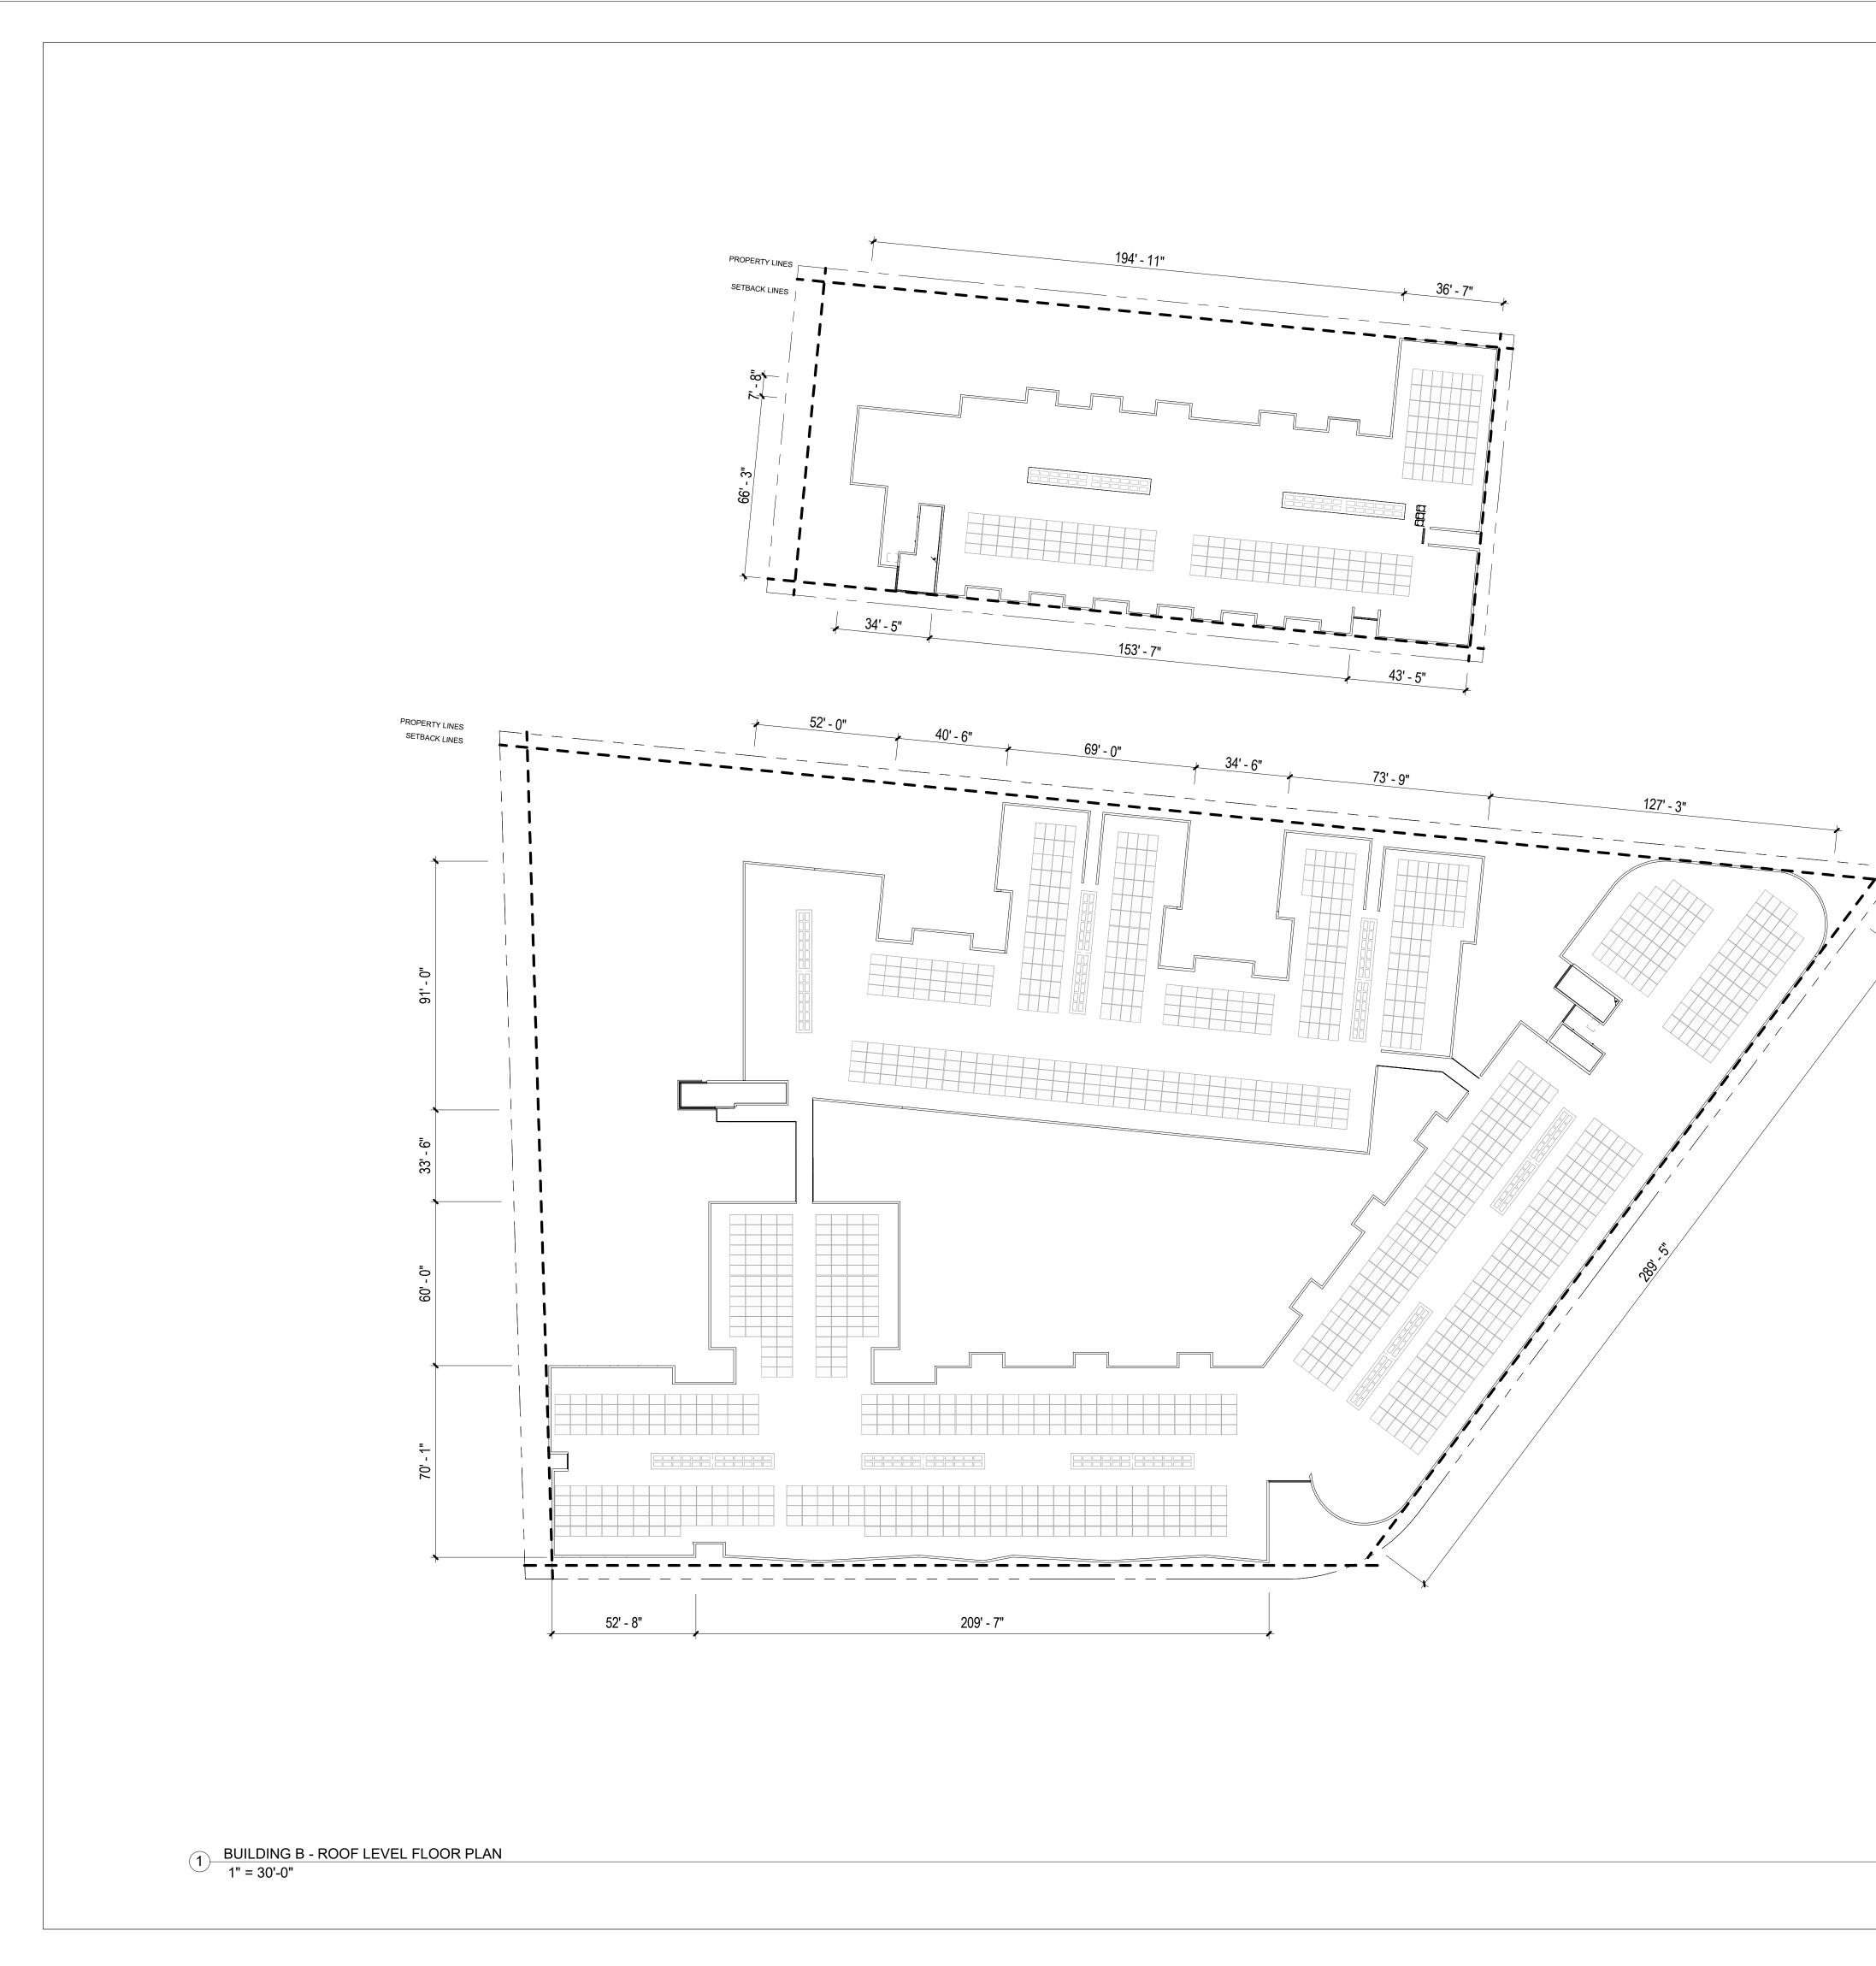
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FLOOR PLAN -LEVELS 8

A-206

Date	
Project	No.

SOUTH Z 0' 7.5' 15' 30'



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	Issuances
Description	Date
Entitlements Update	2/27/2024

		Revisions
Rev.	Description	Date

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Drawing Title

FLOOR PLAN -ROOF

lo.


04/18/2024

21620

A-	-20	7
A-	-20	<b>7</b>

Date	
Project	No.

SOLFF Z 0' 7.5' 15' 30'

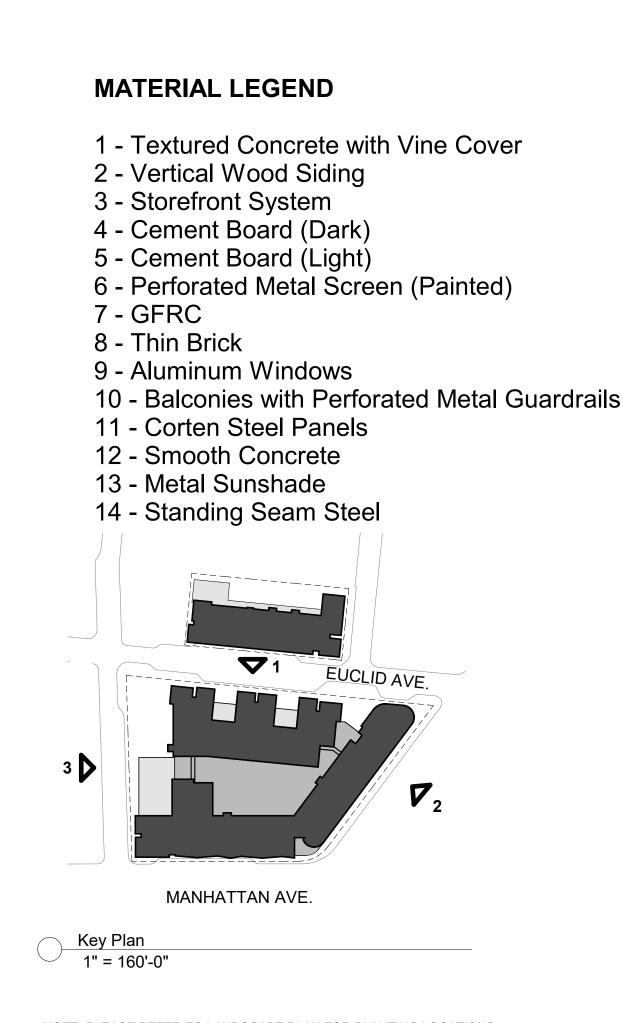

NOTE: PLEASE REFER TO LANDSCAPE PLAN FOR PLANTING LOCATIONS







3 O'Connor St. Elevation - East Building 1" = 30'-0"

3 1

6


3



2 W. Bayshore Rd. Elevation - East Building 1" = 30'-0"


# Woodland Park Euclid Improvomente

	Improvements
T.O. PARAPET 89'-0" 89'-0" 89'-0" $10^{10}$	<image/> <image/> <section-header><section-header><section-header><section-header><section-header><section-header><text></text></section-header></section-header></section-header></section-header></section-header></section-header>
I.O. PARAPET $89' \cdot 0"$ $1$ </td <td>License Stamp         Issuances         Description       Date         Entitlements Update       2/27/2024         Revisions       Revisions         Rev.       Description       Date         1       Response to Comments       4/19/2024</td>	License Stamp         Issuances         Description       Date         Entitlements Update       2/27/2024         Revisions       Revisions         Rev.       Description       Date         1       Response to Comments       4/19/2024
10 $10$ $10$ $10$ $10$ $10$ $10$ $10$	Set Title Design Update - April 2024 Drawing Title BUILDING ELEVATIONS Sheet No. Date 04/18/2024 Project No. 21620

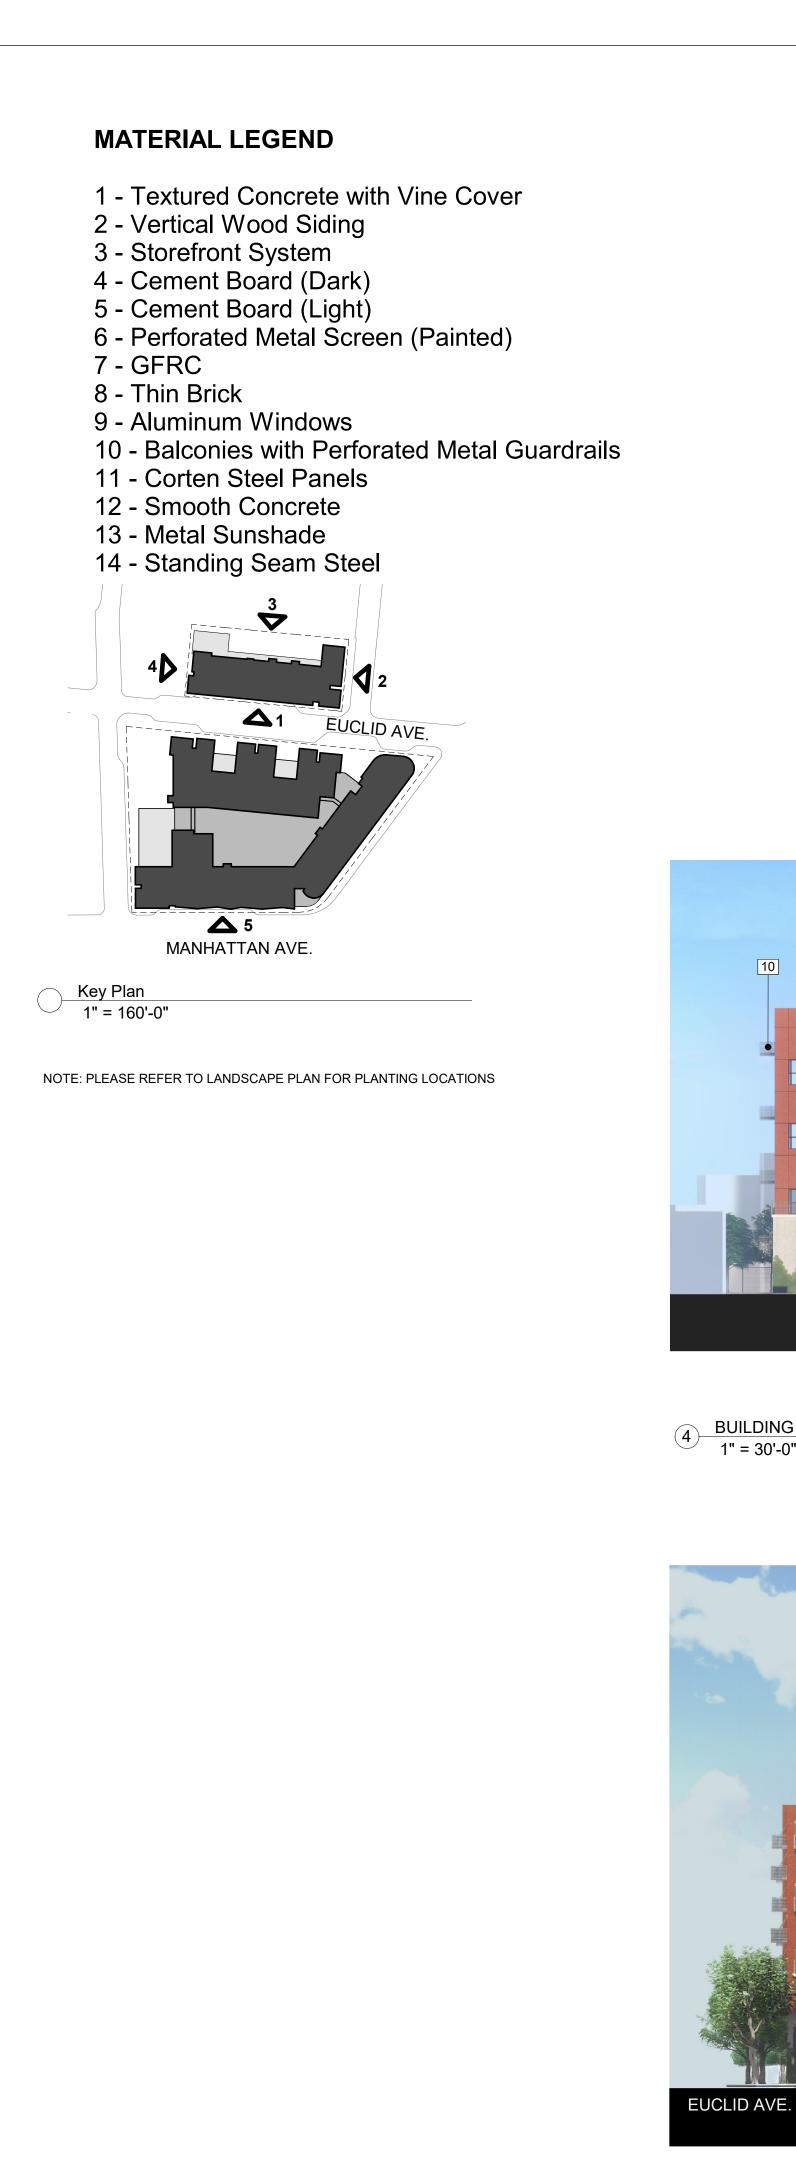

2 East O'Keefe St. Elevtion - West Building 1" = 30'-0"



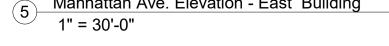




4 BUILDING A - SOUTH ELEVATION Copy 1 1" = 30'-0"

10








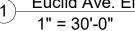





	Ļ								 		
I	ROOF DECK COMMON SPACE										
	RESIDENTIAL		STAI	R	RESIDENTIAL	RESIDENT	IAL	RESIDENTIAL	RES	SIDENTIAL	
										-	
•	COMMON S		PACE								
GROU FITNE			FITNES	S			a.	GARAGE	5		
	BIKE	LОВ	BY PACKA	GE							
				_							

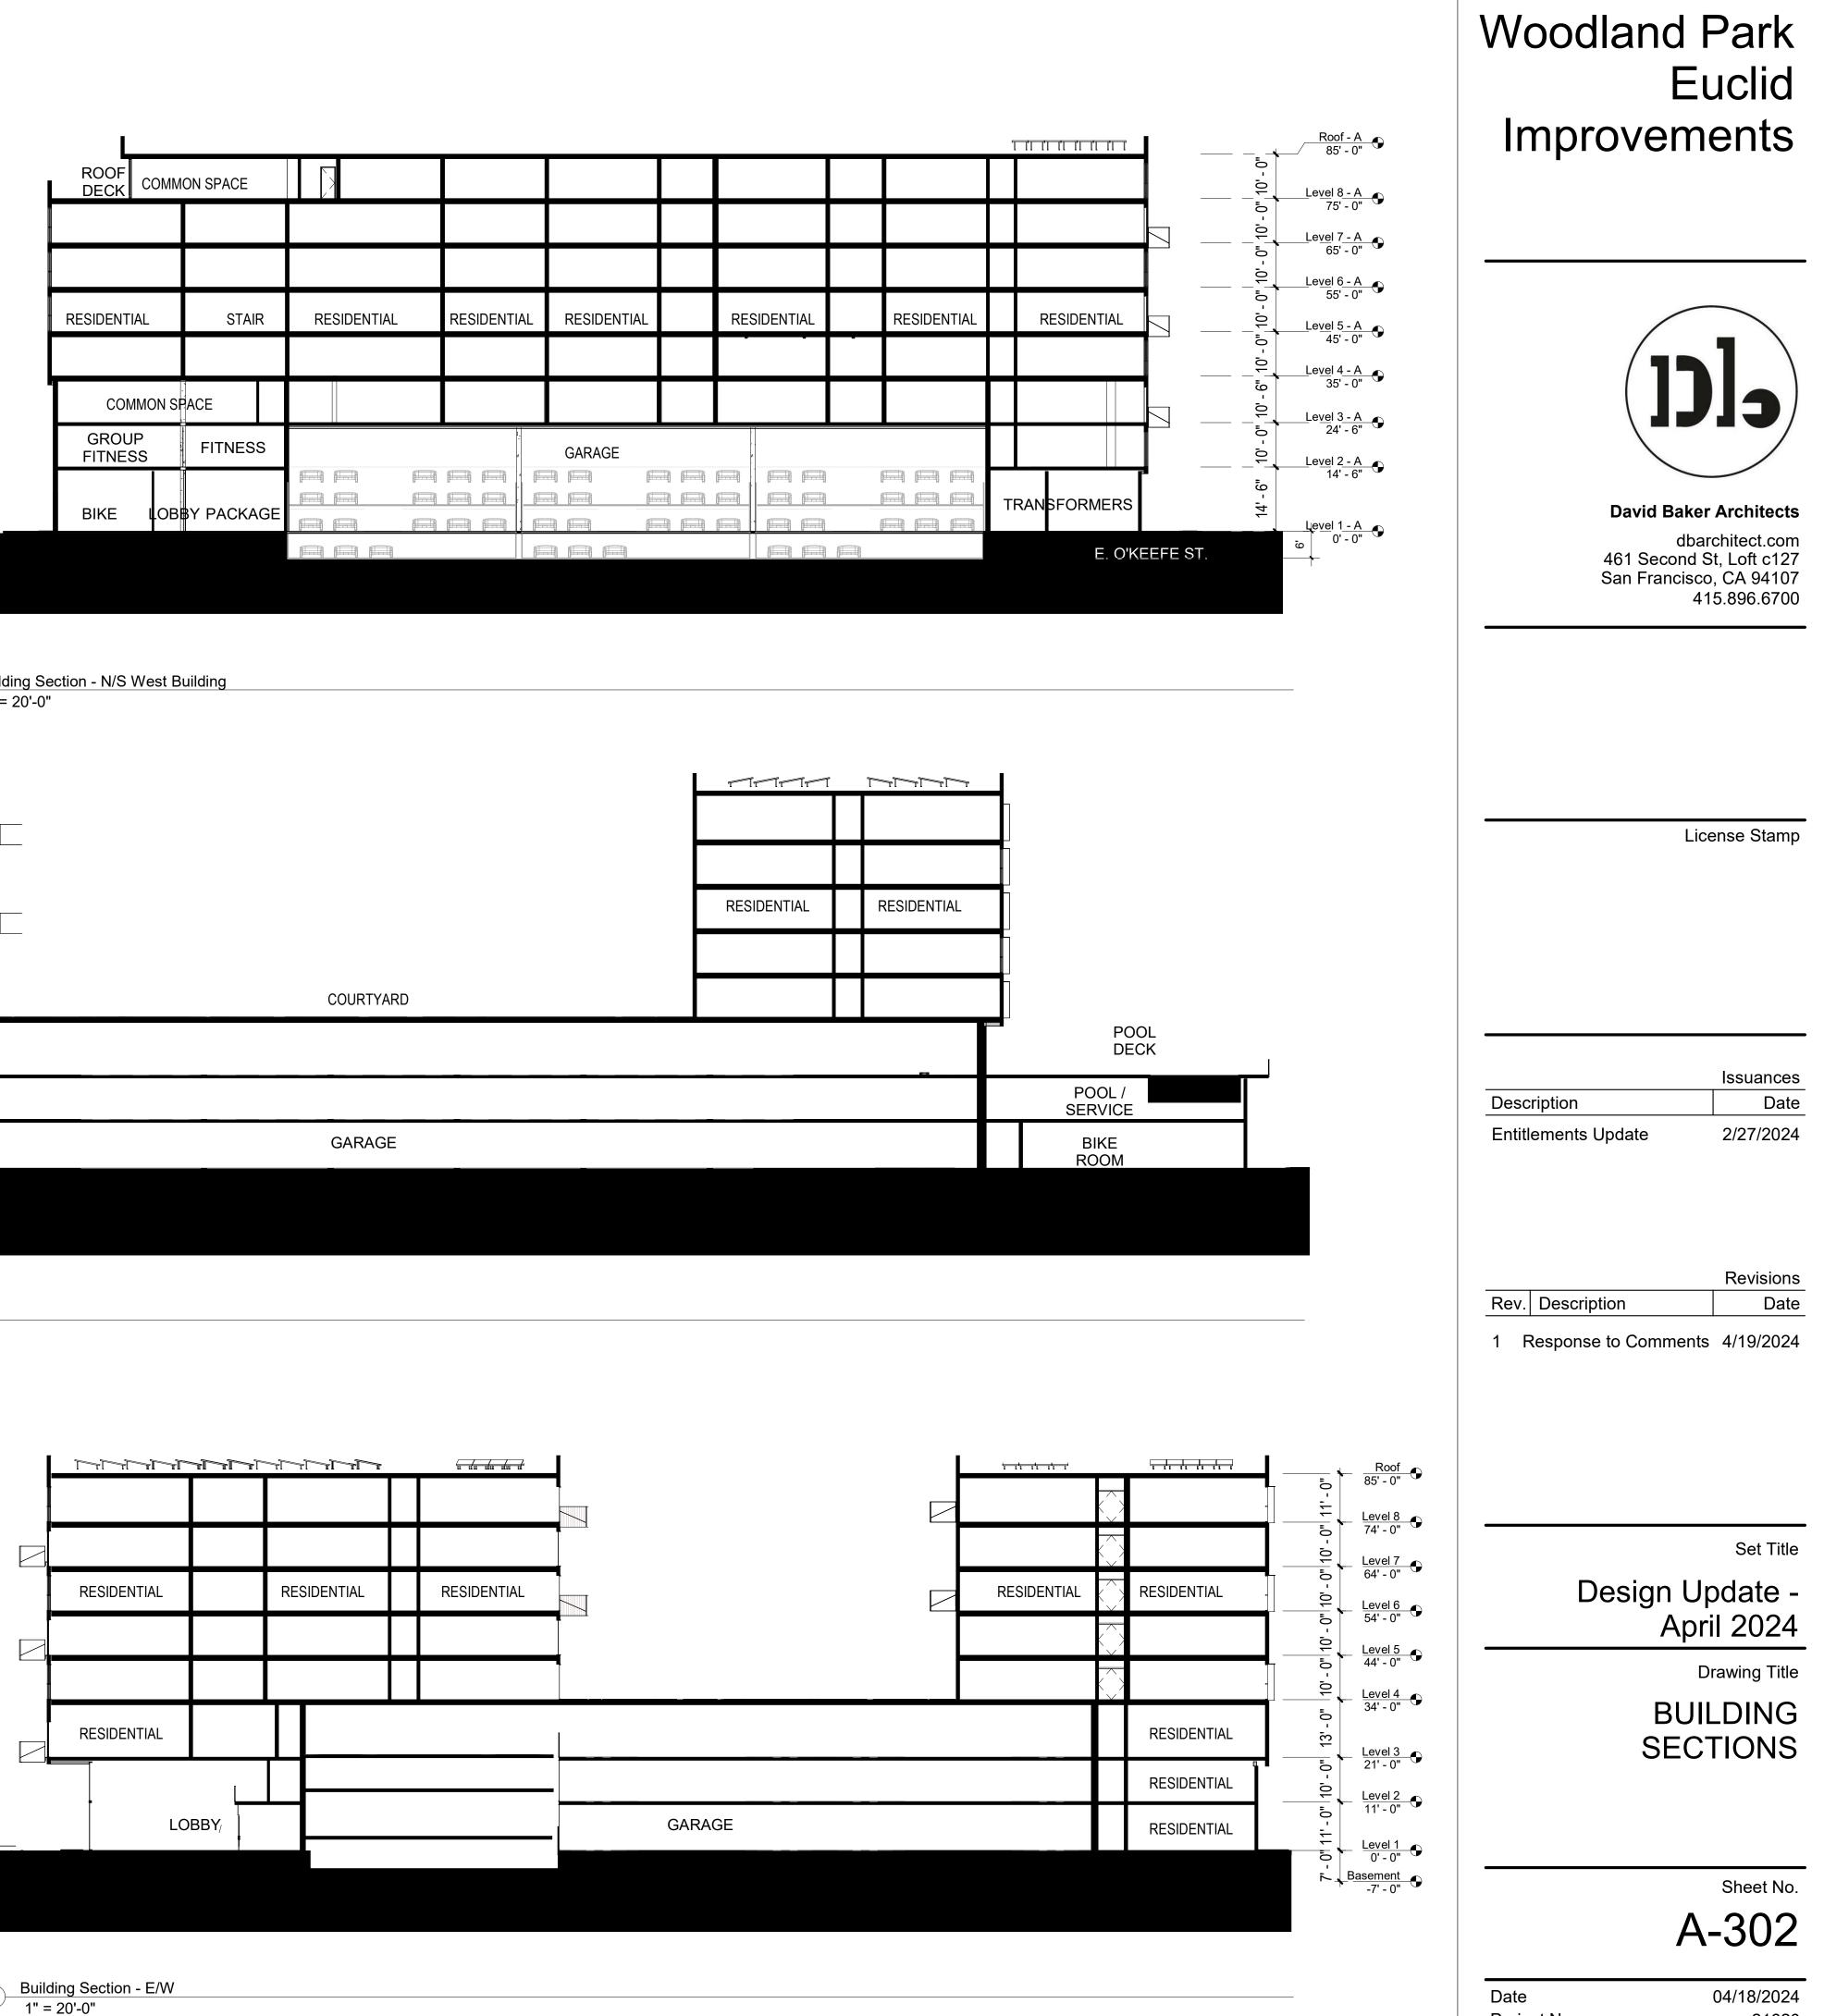



1 - Textured Concrete with Vine Cover

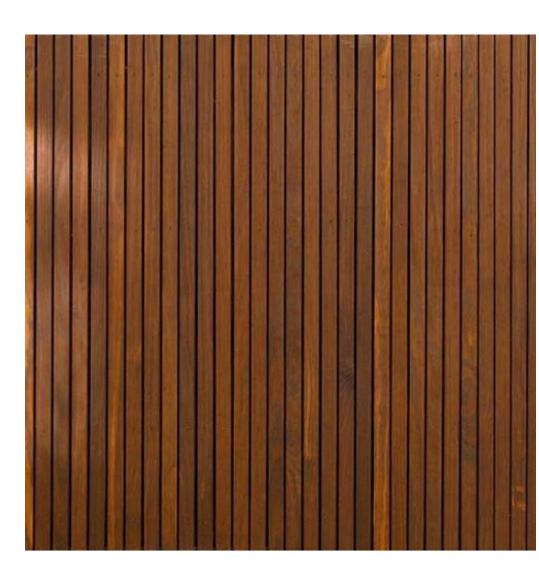

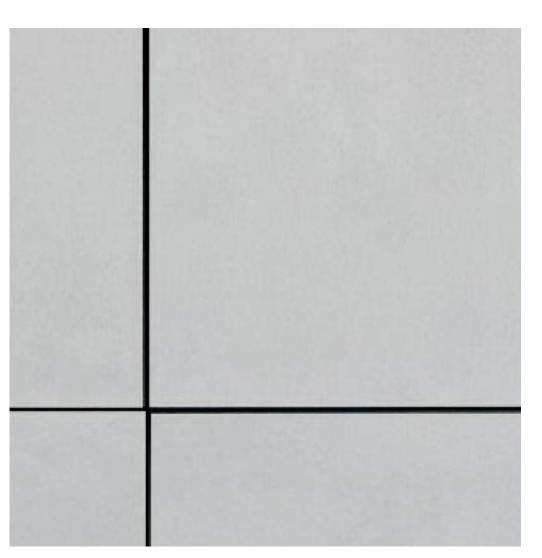

5 - Cement Board (Light)



9 - Aluminum Windows






2 - Vertical Wood Siding



3 - Storefront System

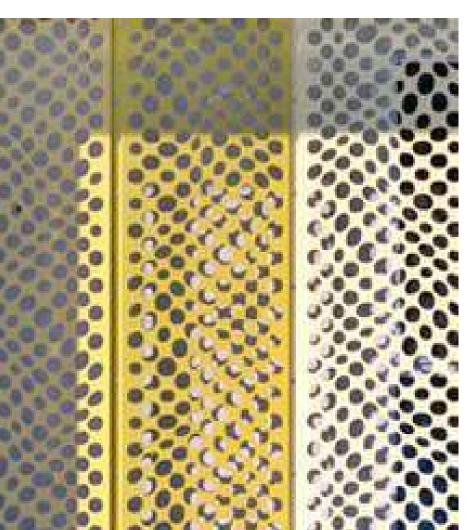

6 - Perforated Metal Screen (Painted)



7 - GFRC


10 - Balconies with Perforated Metal Guardrails




11 - Corten Steel Panels



4 - Cement Board (Dark)

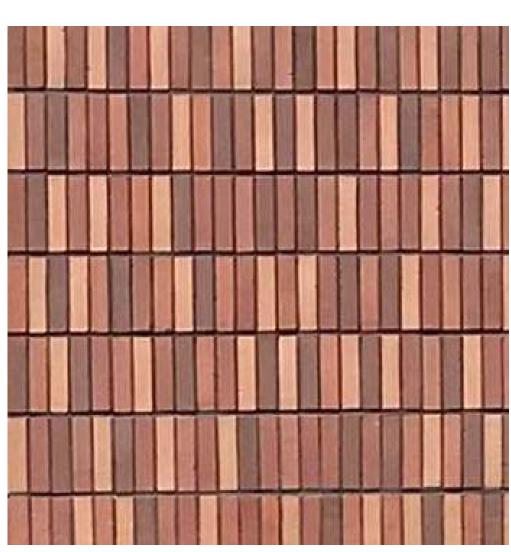


8 - Thin Brick

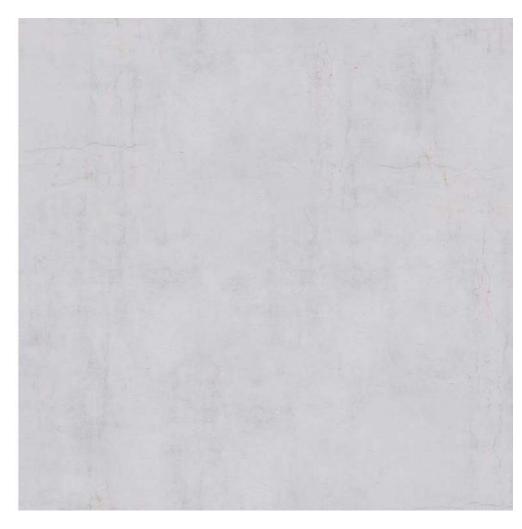

12 - Smooth Concrete

# Woodland Park Euclid Improvements

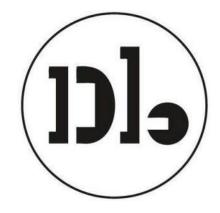

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# PREVIOUSLY SUBMITTED SHEET NO CHANGE

	Issuances
Description	Date
Entitlements Update	1/8/2024

Rev.	Description

Revisions Date

Set Title

Entitlements -January 2024


Drawing Title

EXTERIOR MATERIALS

Sheet No.

A303

Date Project No. 12-08-2023 21620

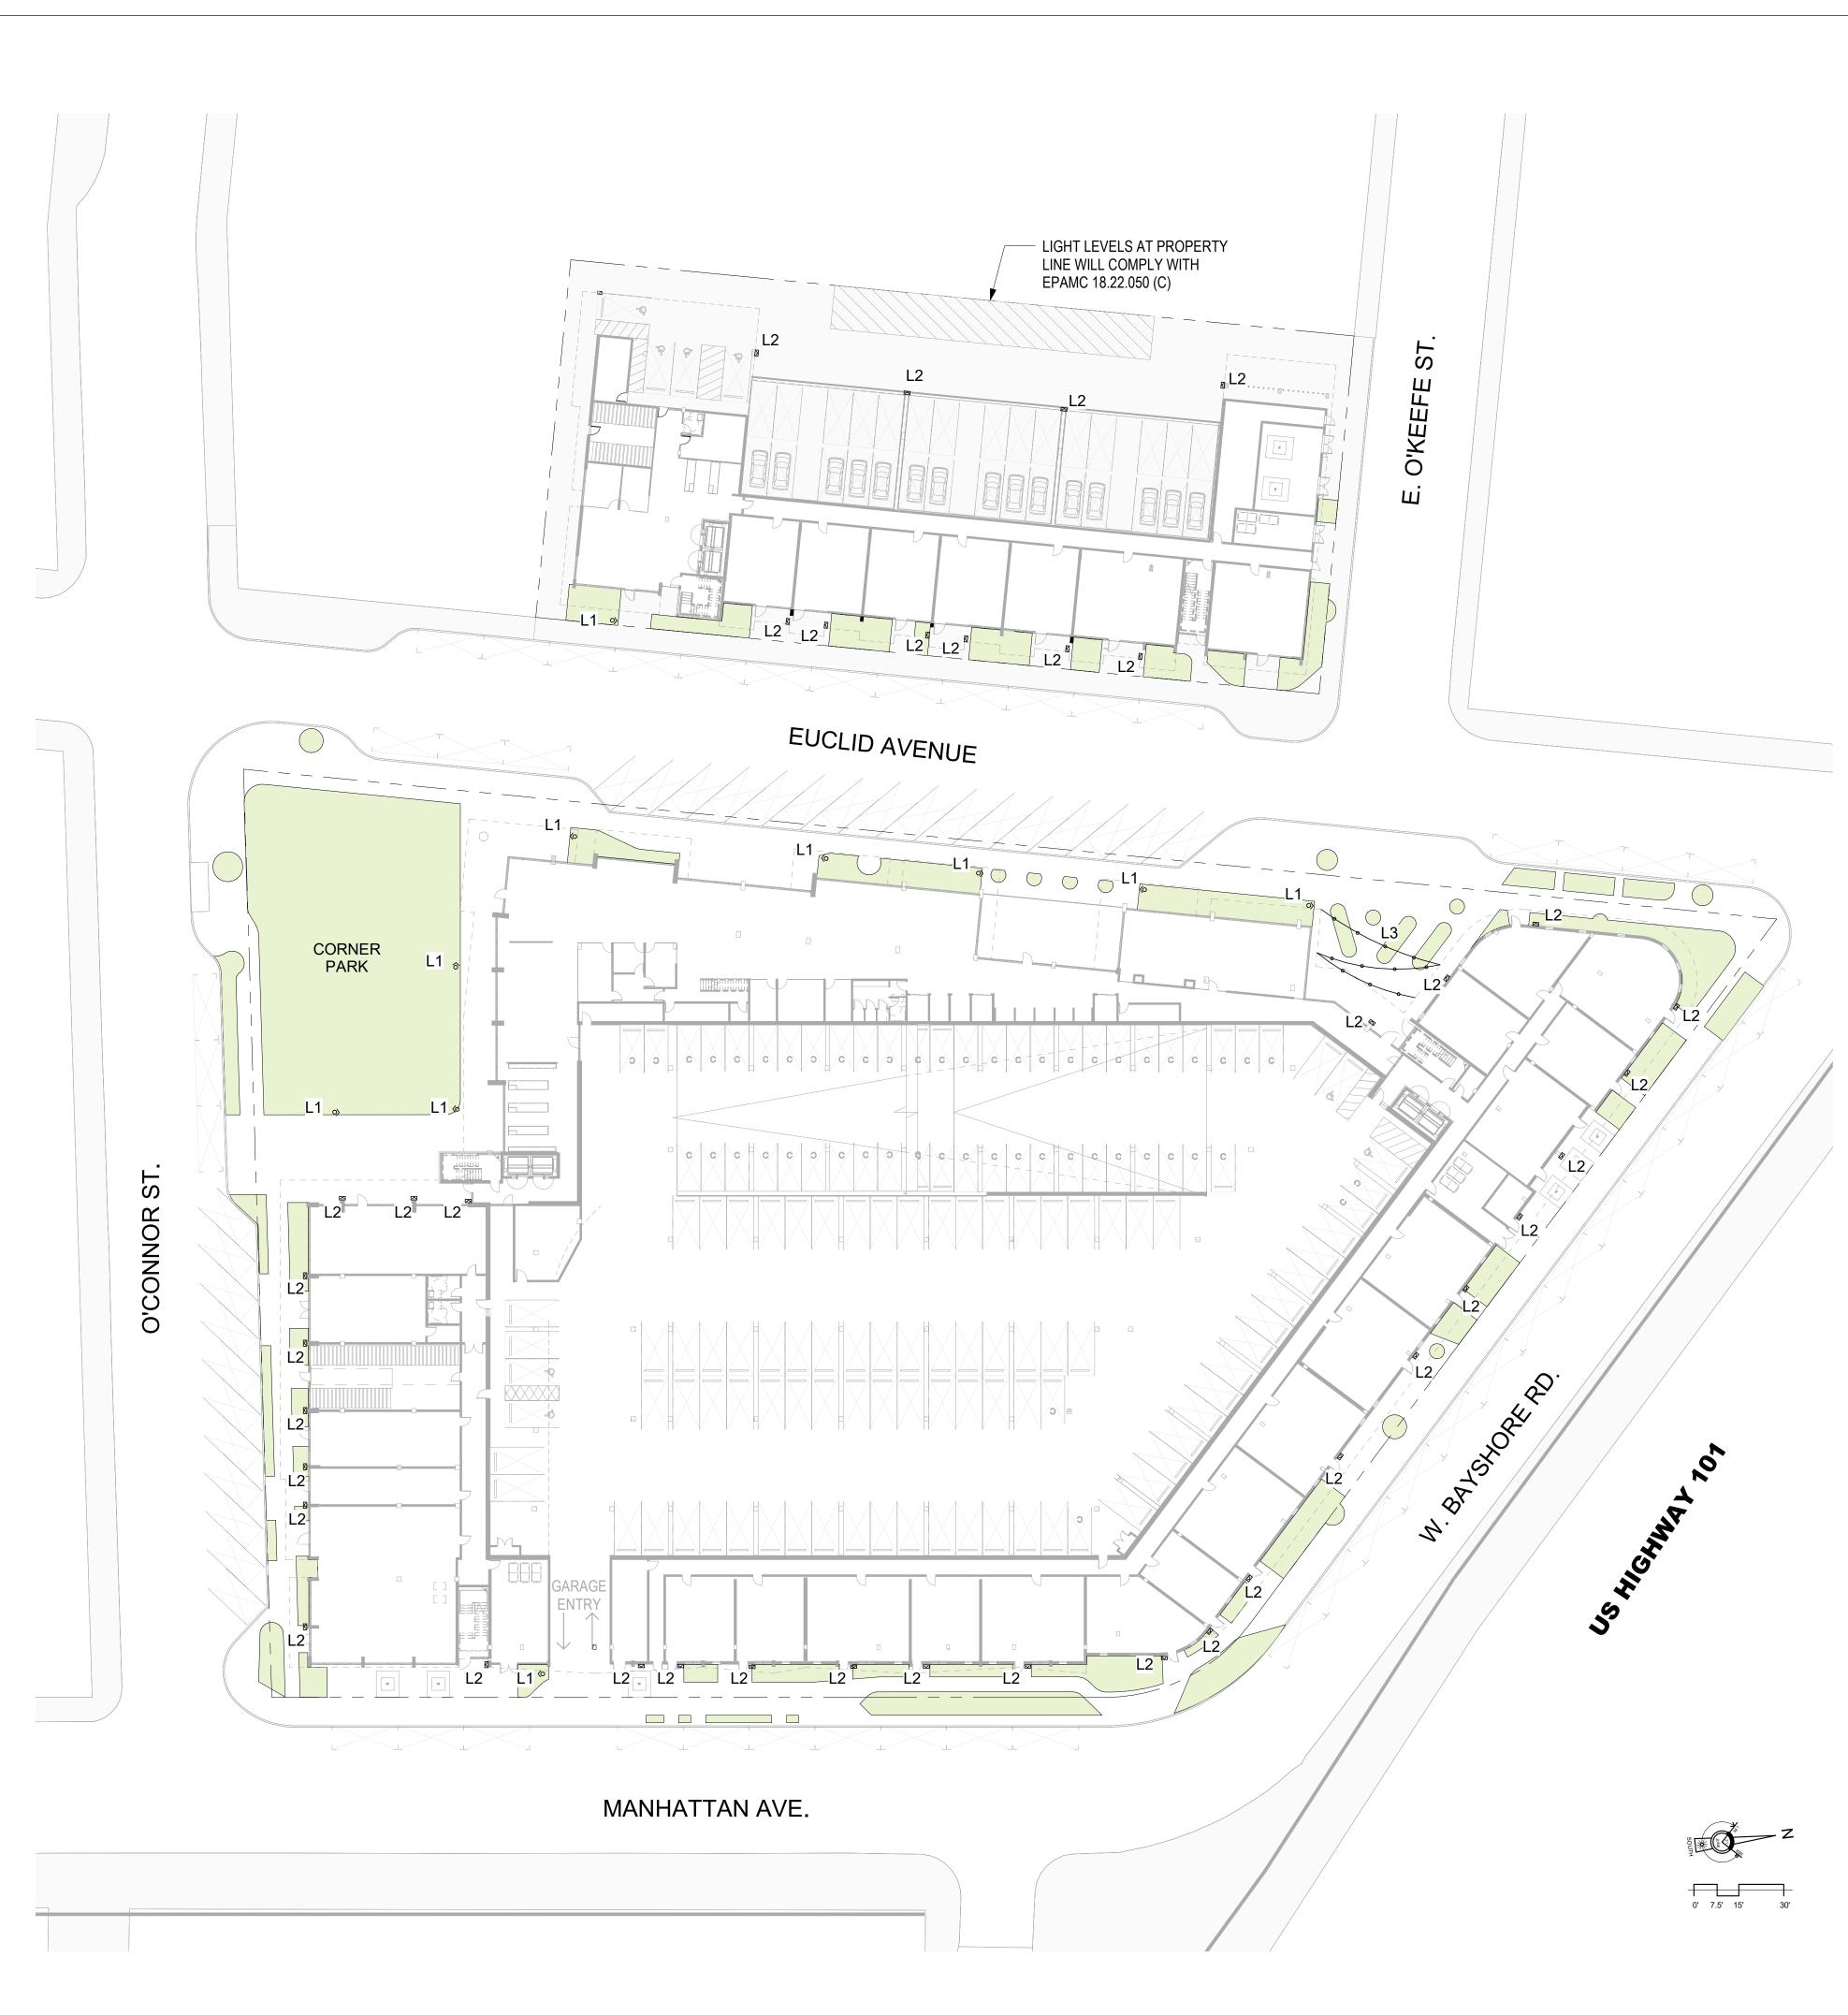



L1 0>

DECORATIVE BOLLARD LIGHT



L2  $\Box$ 

WALL MOUNTED DOWN LIGHT



HANGING STRING "FESTOON-STYLE" LIGHTS L3

NOTES: 1. OUTDOOR LIGHTING WILL COMPLY WITH EPAMC 18.22.050 2. OUTDOOR LIGHTING LEVELS WILL COMPLY WITH EPAMC 18.22.050 (C) 3. OUTDOOR LIGHTING WILL BE DESIGNED TO MINIMIZE ADVERSIE IMPACTS ON ADJACENT PROPERTIES AND TO NOT PRODUCE GLARE ONTO ADJACENT PROPERTIES OR ROADWAYS. 4. DAPKING AREA LIGHT EIXTURES AND LIGHT EIXTURES ON STRUCTURES 4. PARKING AREA LIGHT FIXTURES AND LIGHT FIXTURES ON STRUCTURES

SHALL BE FULL CUT-OFF FIXTURES

# Woodland Park Euclid Improvements



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	Issuances
Description	Date
Entitlements Update	2/27/2024

		Revisions
Rev.	Description	Date

1 Response to Comments 4/19/2024

Set Title

- Design Update April 2024

Drawing Title

CONCEPTUAL LIGHTING PLAN

A-511


Date Project No.





**Common Open Space.** The land area within a residential or nonresidential development not individually owned or dedicated for public use and designed, intended, and reserved exclusively for the shared enjoyment or use by all the residents and their guests. Does not include enclosed spaces/facilities (e.g., community center, meeting rooms, etc.)

**Private Open Space.** An outdoor or unenclosed area directly adjoining and accessible to a dwelling unit, reserved for the exclusive private enjoyment and use of residents of the dwelling unit and their guests (e.g., balcony, deck, porch, terrace, etc.). Boundaries are evident through the use of fences, gates, hedges, walls, or other similar methods of controlling access and maintaining privacy.

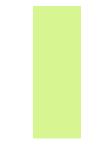

Publicly Accessible / Usable Open Space. An outdoor or unenclosed area within a residential development on the ground, or on a roof, balcony, deck, porch or terrace, designed and accessible for outdoor living, active or passive recreation, pedestrian access, or landscaping. Parking facilities, driveways, utility or service areas and submerged land do not constitute usable open space.

# **OPEN SPACE - PROVIDED**

WEST PARCEL (BUILDING A)

### COMMON:

Level 3	<b>OPEN SPACE - COMMON</b>	2,083 SF
Level 8	OPEN SPACE - COMMON	2,234 SF
	· ·	4,317 SF

### PRIVATE:

(BALCONIES)

Level 1	OPEN SPACE - PRIVATE	1	2,192 SF
Level 3	OPEN SPACE - PRIVATE	7	1,636 SF
Level 4	OPEN SPACE - PRIVATE	11	509 SF
Level 5	OPEN SPACE - PRIVATE	12	559 SF
Level 6	OPEN SPACE - PRIVATE	9	432 SF
Level 7	OPEN SPACE - PRIVATE	9	433 SF
Level 8	OPEN SPACE - PRIVATE	6	288 SF
	·	55	6,050 SF

WEST PARCEL GRAND TOTAL 10,367 SF

# **USABLE / PUBLIC:**

Level 1	OPEN SPACE - PUBLIC	1,913 S
L	· ·	1,913 S

PROJECT TOTAL:

TOTAL OPEN SPACE PROVIDED: 10,367 SF + 46,419 SF = 56,786 SF TOTAL (103 SF PER UNIT)

# EAST PARCEL (BUILDING B)

### COMMON:

Level 1	OPEN SPACE - COMMON	994 SF
Level 3	OPEN SPACE - COMMON	6,352 SF
Level 4	OPEN SPACE - COMMON	17,018 SF
Level 8	OPEN SPACE - COMMON	3,251 SF
		27,615 SF

### PRIVATE:

(BALCONIES)

Level 3OPEN SPACE - PRIVATE143,137Level 4OPEN SPACE - PRIVATE492,975Level 5OPEN SPACE - PRIVATE402,071Level 6OPEN SPACE - PRIVATE341,782Level 7OPEN SPACE - PRIVATE402,071Level 8OPEN SPACE - PRIVATE311,638				
Level 4OPEN SPACE - PRIVATE492,975Level 5OPEN SPACE - PRIVATE402,071Level 6OPEN SPACE - PRIVATE341,782Level 7OPEN SPACE - PRIVATE402,071Level 8OPEN SPACE - PRIVATE311,638	Level 1	OPEN SPACE - PRIVATE	2	5,130 SF
Level 5OPEN SPACE - PRIVATE402,071Level 6OPEN SPACE - PRIVATE341,782Level 7OPEN SPACE - PRIVATE402,071Level 8OPEN SPACE - PRIVATE311,638	Level 3	OPEN SPACE - PRIVATE	14	3,137 SF
Level 6OPEN SPACE - PRIVATE341,782Level 7OPEN SPACE - PRIVATE402,071Level 8OPEN SPACE - PRIVATE311,638	Level 4	OPEN SPACE - PRIVATE	49	2,975 SF
Level 7OPEN SPACE - PRIVATE402,071Level 8OPEN SPACE - PRIVATE311,638	Level 5	OPEN SPACE - PRIVATE	40	2,071 SF
Level 8 OPEN SPACE - PRIVATE 31 1,638	Level 6	OPEN SPACE - PRIVATE	34	1,782 SF
	Level 7	OPEN SPACE - PRIVATE	40	2,071 SF
210 18.804	Level 8	OPEN SPACE - PRIVATE	31	1,638 SF
210 10,00			210	18,804 SF


EAST PARCEL GRAND TOTAL

46,419 SF

### **USABLE / PUBLIC:**

Level 1	OPEN SPACE - PUBLIC	18,211 SF
		18,211 SF

# Woodland Park Euclid Improvements

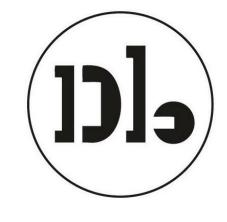

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	Issuances
Description	Date
Entitlements Update	2/27/2024

		Revisions
Rev.	Description	Date

1 Response to Comments 4/19/2024

Set Title

# Design Update -April 2024

Drawing Title

**OPEN SPACE** DIAGRAMS

Sheet	No.
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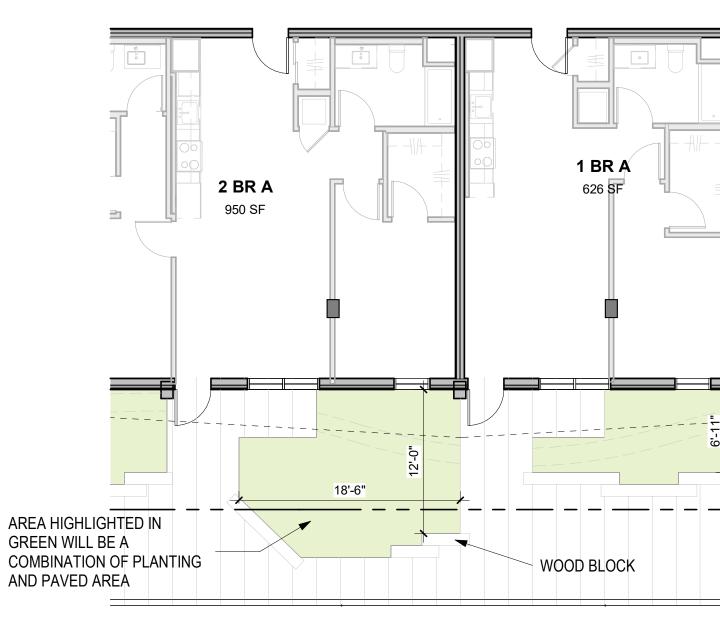
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Date	
Project	N






PRECEDENT IMAGE OF PLANTING SEPARATION



3 GROUND FLOOR PATIO CONCEPT 1/8" = 1'-0"

# Woodland Park Euclid Improvements

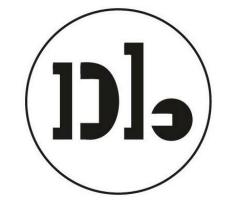

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PRECEDENT IMAGE OF WOOD BLOCK SEPARATION

CONCEPTUAL DESIGN OF PRIVATE PATIO AREAS ALONG EUCLID, BAYSHORE AND MANHATTAN GROUND FLOOR UNITS.

ALL DESIGNATED UNIT PATIOS ARE A MINIMUM OF 6' IN DEPTH AND ARE UNENCLOSED AREAS DIRECTLY ADJOINING THE DWELLING UNIT. THE PATIOS PROVIDE OUTDOOR GATHERING/PLANTING/SEATING SPACE TO THE RESIDENTS. PLANTING, WOOD BLOCKS, CURBS AND MATERIAL CHANGES ARE EXAMPLES OF WHAT WILL BE USED TO CREATE THE BOUNDARY BETWEEN THE PUBLIC SIDEWALK AND THE OUTDOOR, UNENCLOSED AREA DIRECTLY ADJOINING THE DWELLING UNIT. IssuancesDescriptionDateEntitlements Update2/27/2024

		Revisions
Rev.	Description	Date
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1 Response to Comments 4/19/2024

Set Title

Design Update -April 2024


Drawing Title

OPEN SPACE DIAGRAMS

Sheet No.

A-502

Date Project No.

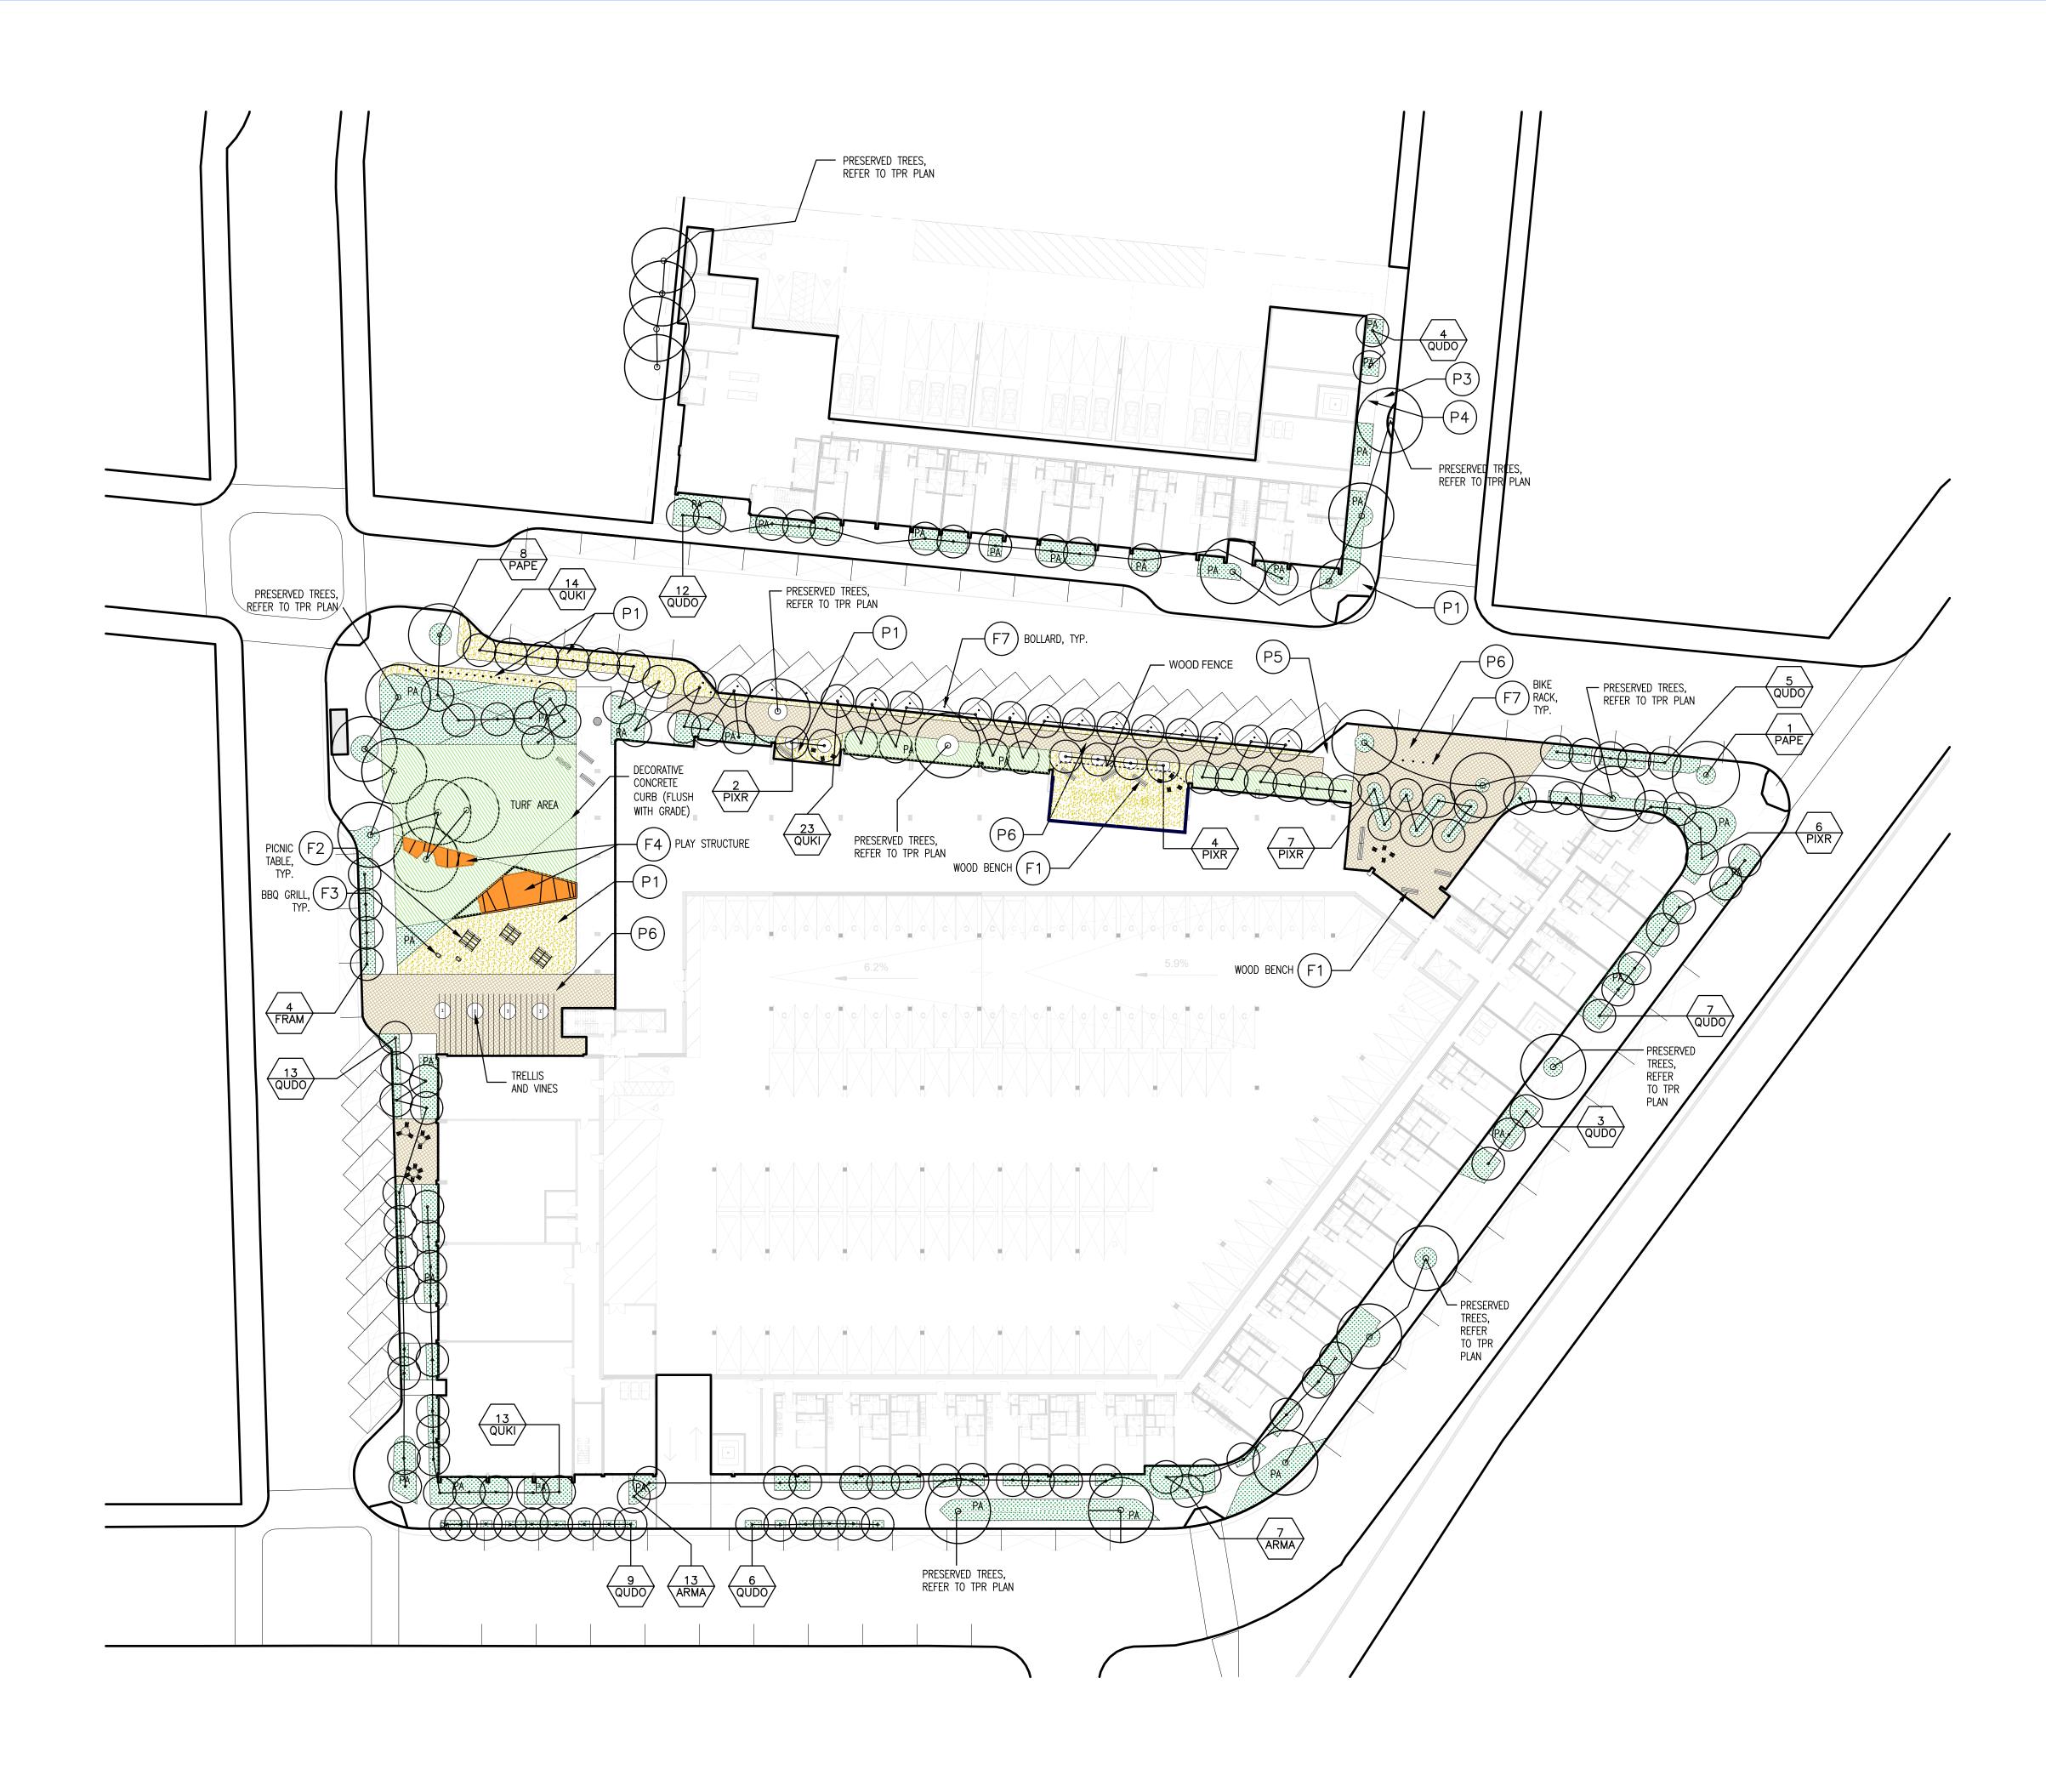





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	Issuances
Description	Date

		Revisions
Rev.	Description	Date

Set Title Entitlements Application

Drawing Title

Landscape Site Plan


Sheet No.

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Date	27 February, 2024
Project No.	21620

PAVIN	<u>G</u>			
KEY	SYMBOL	DESCRIPTION / LOCATION		
(P1)		DECOMPOSED GRANITE		
(P2)		GRAVEL		
(P3)		CIP CONCRETE		
(P4)		ASPHALT BLOCK PAVER		
(P5)		CIP COLORED CONCRETE		
P6		STONE PAVERS		
FURN	ISHINGS			
KEY	SYMBOL	DESCRIPTION / LOCATION		
(F1)		WOOD BENCH		
<b>F2</b>	H	PICNIC TABLE		
<b>F3</b>		BBQ GRILL		
(F4)		CUSTOM PLAY AN SEATING STRUCTUR		
<b>F5</b>		CURVED CONCRET BENCH		
<b>F6</b>		GARDEN BED		
<b>F7</b>	0	BIKE RACK / BOLLARD		
LIGHT	FIXTURES			
KEY	SYMBOL	DESCRIPTION / LOCATION		
PLANT TREES KEY	Соммон	I NAME		
FRAM WHITE ASH				
ARMA MARINA STRAWBERRY TREE				
QUDO	BLUE OAK	BLUE OAK		
PIXR	RED PUSH F	PISTACHE		
QUKI	KINDRED SP	IRIT OAK		





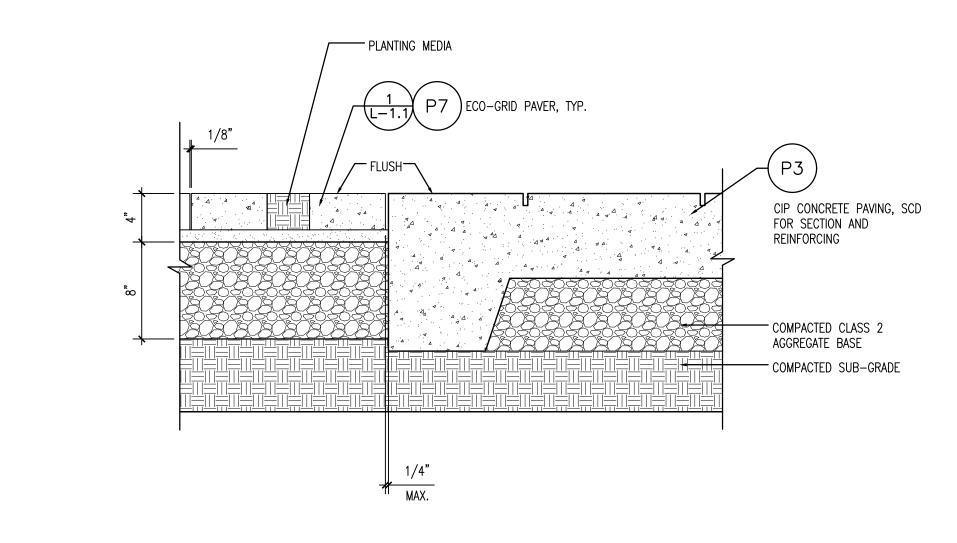
















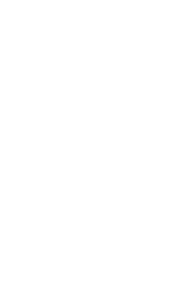

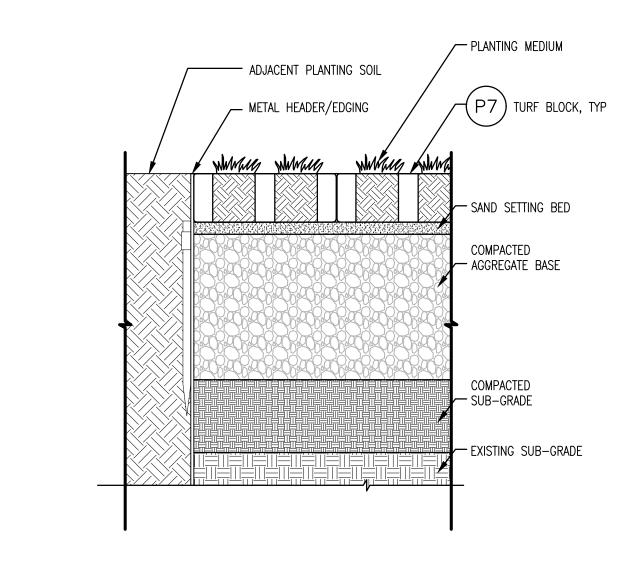

5 P7 - ECO-GRID PAVER AT PLANTINGScale: 1-1/2" = 1' - 0"

4 P7 - ECO-GRID PAVER AT CONCRETE PAVING SCALE: 1-1/2" = 1' - 0"

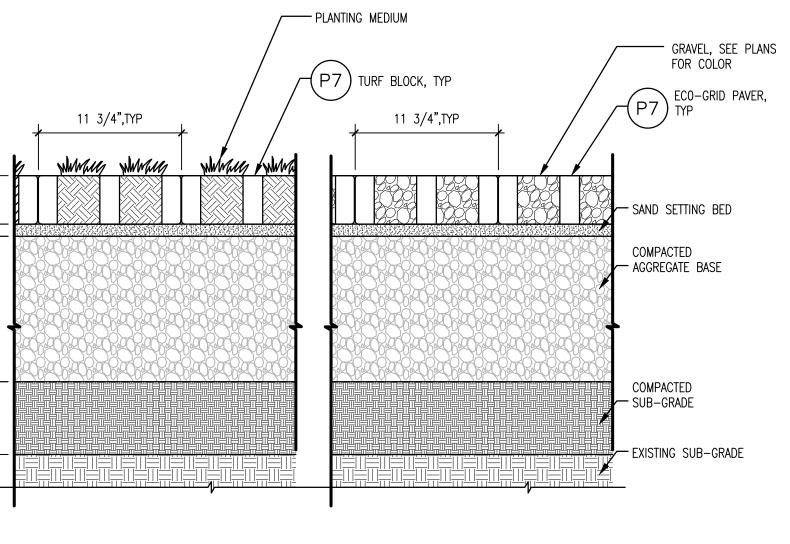


GRAVEL CONDITION

3 P7 - ECO-GRID PAVER, TYPICALSCALE: 1-1/2" = 1' - 0"

PLANTING CONDITION

# Woodland Park Euclid Improvements

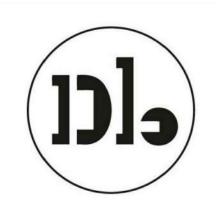

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	Issuances
Description	Date

		Revisions
Rev.	Description	Date

Set Title

Design Update -February 2024

Drawing Title

Landscape Details

Sheet No.

1	1	1	
	-		

Date Project No. 27 February, 2024 21620

### GENERAL NOTES

- 1. ALL TREE REMOVAL WORK SHALL BE PERFORMED IN CONFORMANCE WITH APPLICABLE LOCAL CODES AND ORDINANCES.
- 2. ALL ADDITIONAL REQUIREMENTS FOR TREE PROTECTION AND MITIGATION AS REQUIRED BY THE CITY ARBORIST AND THE PROJECT ARBORIST SHALL BE FOLLOWED. REFERENCE CITY PROJECT ARBORIST NOTES
- 3. CONTRACTOR SHALL VISIT THE SITE WITH OWNER'S REPRESENTATIVES PRIOR TO BEGINNING ANY WORK. VERIFY ALL TREES, SHRUBS & VEGETATION WITHIN THE LIMITS OF WORK TO BE REMOVED AND ALL TREES & PLANTS TO REMAIN AND TO BE PROTECTED.
- 4. ALL TREES AND PLANTS DESIGNATED TO REMAIN SHALL BE PROTECTED FROM PHYSICAL DAMAGE AND MAINTAINED THROUGHOUT THE DURATION OF THE CONTRACT. THOSE TREES AND PLANTS INDICATED TO BE REMOVED SHALL BE COMPLETELY REMOVED, INCLUDING THE ROOTS, AND DISPOSED OF OFF-SITE. BACKFILL EXCAVATED AREAS TO RESTORE TO EXISTING GRADE.
- 5. PROTECTIVE FENCING: TEMPORARY FENCES OR BARRICADES SHALL BE INSTALLED AS SHOWN ON THE DRAWINGS OR AS DIRECTED IN THE FIELD BY THE PROJECT ARBORIST OR THE OWNER'S REPRESENTATIVE. FENCING SHALL BE A MINIMUM OF SIX (6) FOOT HEIGHT, CHAIN LINK. MAINTAIN FENCING IN CONTINUOUS, STABLE AND UPRIGHT CONDITION AT ALL TIMES.
- 6. CONTRACTOR SHALL REMOVE FROM THE SITE ALL DEBRIS AND UNSUITABLE MATERIAL GENERATED FROM CONSTRUCTION AND DISPOSE OF IN A LAWFUL MANNER.

# TREE PROTECTION NOTES

STANDARDS.

WITHIN A TPZ AREA:

- NO ATTACHMENTS OR ANCHORAGES OF ANY KIND TO TREE TRUNKS, BRANCHES, OR FOLIAGE, INCLUDING USE AS SUPPORT FOR FENCING, SIGNAGE, POWER, ETC., GUY WIRING, ROPES, OR SIMILAR FUNCTIONS. NO DUMPING OF POISONOUS OR TOXIC MATERIALS, INCLUDING PAINT, PETROLEUM PRODUCTS, CHEMICALS, DIRTY OR NON-POTABLE WATER, OR OTHER DELETERIOUS MATERIALS. NO EXCESSIVE HEAT OR WATER FROM EQUIPMENT.

- INCH (18") DEPTH.



1. PROTECTION OF EXISTING VEGETATION SHALL COMPLY WITH REQUIREMENTS UNDER SPECIFICATION SECTION 015639 - TEMPORARY TREE AND PLANT PROTECTION.

2. PRIOR TO COMMENCING WORK, A TREE PROTECTION ZONE (TPZ) AREA SHALL BE DESIGNATED AND ESTABLISHED TO IDENTIFY THOSE AREA(S) THAT ARE NOT SPECIFICALLY DESIGNATED FOR REMOVAL OR DEMOLITION AND REQUIRE MANDATORY PROTECTION MEASURES. AREAS MAY INCLUDE THE BOUNDARY DELINEATED IN THE CONTRACT DRAWINGS AS THE DESIGNATED LIMITS OF WORK, ADJOINING AREAS THAT ARE IN CLOSE VICINITY (BY MEASUREMENT CALCULATION OF TREE DRIP LINE OR CANOPY SPREAD), VEHICULAR ACCESS AREAS LEADING TO THE CONSTRUCTION ZONE, LAY DOWN AREAS, OR OTHER AREAS IMPACTED BY CONSTRUCTION ACTIVITIES. TPZ AREA SHALL BE CONFIRMED BY THE OWNER'S AUTHORIZED REPRESENTATIVE, GOVERNING AGENCY REPRESENTATIVE, OR LANDSCAPE ARCHITECT.

3. CONTRACTOR SHALL BE FAMILIAR WITH THE GENERAL CONDITIONS OF THE CONTRACT FOR ANY DAMAGE TO LANDSCAPING OR OTHER AMENITIES THAT OCCUR WITHIN A TPZ AREA.

4. AVOID EXCAVATION WITHIN A DESIGNATED TPZ AREA. ANY ROOT CUTTING NECESSARY AS A RESULT OF EXCAVATION WITHIN A DESIGNATED TPZ AREA SHALL BE CONFIRMED IN ADVANCE WITH THE OWNER'S AUTHORIZED REPRESENTATIVE, GOVERNING AGENCY REPRESENTATIVE, OR LANDSCAPE ARCHITECT. EXCAVATION SHALL BE PERFORMED BY HAND, AND ROOT CUTTING SHALL BE MONITORED ACCORDINGLY BY A CERTIFIED ARBORIST. IF CONFIRMED, ALL NECESSARY ROOT PRUNING SHALL CONFORM TO ANSI A300 PRUNING

5. CONTRACTOR SHALL BE RESPONSIBLE FOR MITIGATING CONSTRUCTION RELATED DUST ACCUMULATION ON ALL PROTECTED PLANT MATERIALS. APPLY WATER IN ADEQUATE QUANTITY AND VOLUME TO SPRAY DOWN TRUNKS, BRANCHES, AND FOLIAGE TO REMOVE DUST TO A HEIGHT OF THIRTY FEET (30'). APPLICATION SHALL OCCUR AT MONTHY INTERVALS FROM APRIL THROUGH NOVEMBER.

6. CONTRACTOR SHALL ADHERE TO REQUIREMENTS (INCLUDING BUT NOT LIMITED TO) FOR THE FOLLOWING

NO STOCKPILING OR STORAGE OF MATERIALS, DEBRIS, REFUGE, SPOILS, OR SOIL.

- NO STORAGE OF CONSTRUCTION TOOLS, EQUIPMENT, OR MACHINERY. NO ACCESS OR PARKING BY VEHICLES, OR ACCESS BY CONSTRUCTION PERSONNEL.
- NO SOIL DISTURBANCE, INCLUDING EXCAVATION, COMPACTION, OR GRADE CHANGES. NO CUTTING, BREAKING, OR SHINNING OF ROOTS CAUSED BY TRENCHING, DIGGING, OR OTHER EXCAVATION WITHOUT PRIOR CONFIRMATION AND ACCEPTANCE.
- MAINTAIN TPZ AREA IN A PEST, DISEASE, AND WEED-FREE CONDITION.

7. CONDITIONAL TO COMMENCING WORK, INSTALL PROTECTIVE BARRICADE FENCING AT THE PERIMETER TPZ AREA(S) TO SAFEGUARD VEGETATION. REFER TO SPECIFICATION SECTION 015639 - TEMPORARY TREE & PLANT PROTECTION, FOR REQUIREMENTS OF FENCING MATERIALS (POSTS/STAKES AND FABRIC MESH), AND ASSOCIATED ATTACHED SIGNAGE. BARRICADE FENCING SHALL BE INSTALLED AND CONTINUOUSLY MAINTAINED IN A FIRM, TAUGHT, AND UPRIGHT CONDITION THROUGHOUT THE DURATION OF THE CONTRACT.

8. NO WORK SHALL BE PERMITTED WITHIN A DESIGNATED TPZ AREA WITHOUT FIRST OBTAINING CONSENT, IN WRITING, FROM THE OWNER'S AUTHORIZED REPRESENTATIVE, GOVERNING AGENCY REPRESENTATIVE, OR LANDSCAPE ARCHITECT. ANY WORK AUTHORIZED WITHIN A DESIGNATED TPZ AREA MUST BE DONE IN ACCORDANCE AND UNDER OBSERVATION BY A MONITORING CERTIFIED ARBORIST.


9. ENGAGEMENT OF A CONSULTING CERTIFIED ARBORIST, AS REQUIRED, SHALL BE THE RESPONSIBILITY OF THE CONTRACTOR AND ALL ASSOCIATED COSTS SHALL BE INCLUDED IN THE CONTRACT BID.

10. EXISTING IRRIGATION SYSTEM, AS APPLICABLE, SHALL BE KEPT IN FUNCTIONAL WORKING OPERATION TO PROVIDE NECESSARY WATER TO ALL PLANTS WITHIN A DESIGNATED TPZ AREA. WHERE CONDITIONS REQUIRE THE NEED TO TEMPORARILY SHUTDOWN AN EXISTING IRRIGATION SYSTEM, CONTRACTOR SHALL PROVIDE FOR HAND-WATERING TO ALL IMPACTED PLANTS. APPLY FRESH, POTABLE WATER AT REGULAR INTERVALS AND IN SUFFICIENT QUANTITY AND APPLICATION RATE TO MAINTAIN HEALTH AND VIGOR OF PROTECTED PLANT MATERIAL THROUGHOUT THE DURATION OF THE CONTRACT. TREES SHALL BE IRRIGATED DEEPLY AND AT A FREQUENCY SO THAT ADEQUATE SOIL MOISTURE IS DETECTED WITH A SOIL PROBE AT A MINIMUM EIGHTEEN

11. CONDITIONAL TO RECEIVING FINAL ACCEPTANCE, CONTRACTOR SHALL REMOVE ALL TPZ AREA MATERIALS THAT WERE INSTALLED DURING THE CONSTRUCTION PERIOD.

12. FAILURE BY THE CONTRACTOR TO ADHERE TO THE REQUIREMENTS SPECIFIED FOR TREE AND PLANT PROTECTION WITHIN A DESIGNATED TPZ AREA MAY RESULT IN THE SUSPENSION OF CONSTRUCTION ACTIVITIES AS NOTIFIED BY THE OWNER'S AUTHORIZED REPRESENTATIVE. ASSOCIATED COSTS INCURRED DUE TO CONSTRUCTION DELAYS FOR NON-COMPLIANCE SHALL BE BORNE BY THE CONTRACTOR.

13. CONTRACTOR SHALL BE RESPONSIBLE FOR FULL AND ADEQUATE COMPENSATION TO OWNER FROM CONTRACTOR'S NON-COMPLIANCE IN FAILING TO ADEQUATELY PROTECT OR FROM RESULTING CONSEQUENTIAL DAMAGE TO PLANTS WITHIN A DESIGNATED TPZ AREA. DIMINISHED VALUE OR COSTS TO REMOVE AND REPLACE TREES OR PLANTS IN KIND THAT HAVE BEEN IMPAIRED THROUGH CONSTRUCTION ACTIVITY SHALL BE COMPENSATED TO THE OWNER, AS DETERMINED BY THIRD PARTY REVIEW. CHOICE OF RECEIVING EITHER MONETARY COMPENSATION OR DIRECTING REMOVAL AND REPLACEMENT IN KIND SHALL BE MADE BY THE OWNER'S AUTHORIZED REPRESENTATIVE.

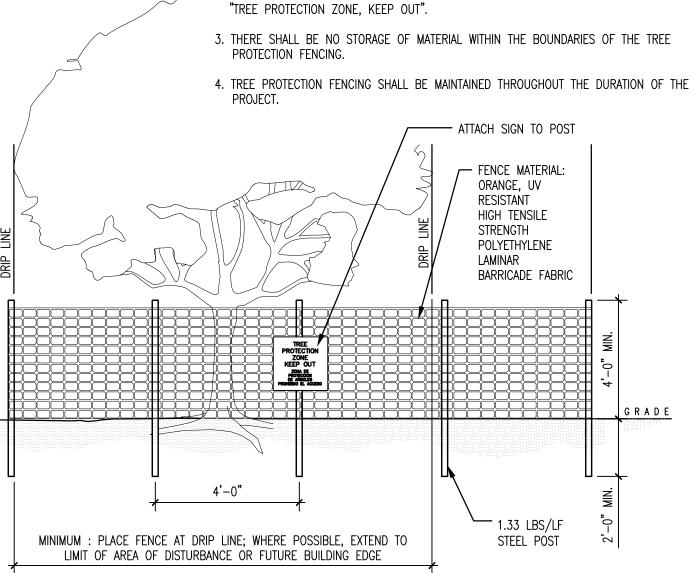

# REE PROTECTION FENCE SCALE: 3/4"=1'-0"

		SIT	E TREES			REPLACEMENT T	REES	
CONDITION	NAME	SPECIES	TRUNK DIAMETER (IN)	PRESERVED (Y/N)	PROTECTED TREE TO BE REMOVED		SIZE	QT
	860	OLEANDER	9	N	→ <u>860</u>		24" BOX	1
	861	OLEANDER	8	N	→ 861			1
	863	OLEANDER	7	N/A				
3	870	CALIFORNIA BLACK	14	N	870	870 KINDRED SPIRIT OAK	24" BOX	1
J		WALNUT				870 RINDRED SFIRIT OAR	24 007	
	871	DEODAR CEDAR	36	Y				
	872	ENGLISH WALNUT	8	Y				
	873	BOXELDER	8	Y				
	874	DEODAR CEDAR	40	Y				
	875	AVOCADO	14 9, 6, 5	Y N	976	876 KINDRED SPIRIT OAK		1
	876	JAPANESE MAPLE	9, 0, 5 7, 4, 4, 4, 4,	IN	876	876 KINDRED SPIRIT OAK	24" BOX	1
	877	JAPANESE MAPLE	4, 4	N	→ 877	877 BLUE OAK	24" BOX	1
4	878	COAST REDWOOD	35	Y				
4	879	SAUCER MAGNOLIA	15, 10	N	→ <u>879</u>	879 BLUE OAK	24" BOX	1
	880	ORANGE	14	N	→ <u>880</u>	880 KINDRED SPIRIT OAK		1
	881	AVOCADO	26	N		881 BLUE OAK	24" BOX	1
3	882	BLACKWOOD ACACIA	21	N	882	882 BLUE OAK	24" BOX	1
3	883	BLACKWOOD ACACIA	16	N	883	883 BLUE OAK	24" BOX	1
1	885	GLOSSY PRIVET	15	N	885		24" BOX	1
1	886	AUSTRALIAN BUSH	7, 6, 5, 5	N	886		24" BOX	1
I			,, ,, ,, ,, ,				24 DVA	1
	887	AUSTRALIAN BUSH CHERRY	14	N	→ 887	887 BLUE OAK	24" BOX	2
	000	AUSTRALIAN BUSH						-
	888	CHERRY	14	N	888	888 BLUE OAK	24" BOX	2
3	890	AUSTRALIAN BUSH	7	N	890	890 BLUE OAK	24" BOX	1
5		CHERRY WEEPING BOTTLE	,				24 007	
	891	BRUSH	14, 6	N	891	891 BLUE OAK	24" BOX	2
	896	ENGLISH WALNUT	17	N	896	896 BLUE OAK	24" BOX	2
	897	ORANGE	7	Ŷ				
0	899	CHERRY	13	N	899	899 KINDRED SPIRIT OAK	24" BOX	2
3	900	ENGLISH WALNUT	17	N	→ <u>900</u>			2
4	901	ORANGE	7	N/A				
	902	CHINESE ELM	24	N	→ <u>902</u>	902 BLUE OAK	24" BOX	2
	903	CHINESE ELM	26	N	→ <u>903</u>		24" BOX	2
	904	MONTERREY PINE	34	N	→ <u>904</u>		24" BOX	2
	905	RAYWOOD ASH	7	N	$\rightarrow$ 905		24" BOX	1
3	907	RAYWOOD ASH	10, 12	N	→ <u>907</u>		24" BOX	2
	908	RAYWOOD ASH	11	N	908		24" BOX	2
	910	RAYWOOD ASH	9	N	910	910 BLUE OAK	24" BOX	2
	911	RAYWOOD ASH	10	N	911	911 BLUE OAK	24" BOX	2
2	912	PLUM	30	N	912	912 KINDRED SPIRIT OAK	24" BOX	2
1	913	BOXELDER	20	N	913	913 KINDRED SPIRIT OAK	24" BOX	2
	914	BOXELDER	20	Y				
3								
0	916	TULIP TREE	24	Y				
	917	COAST LIVE OAK	17	N	917	917 BLUE OAK	24" BOX	2
	920	ITALIAN CYPRESS	14	Y				
3	921	ITALIAN CYPRESS	11	Y				
	922	ITALIAN CYPRESS	12	Y				
	923	PLUM	12, 8	Y			<u> </u>	
2	924	APPLE	15	N	924			2
	926	PLUM	13	N	926			2
0	928	CABBAGE PALM	11, 9	N	928		24" BOX	2
3	929	RIVER RED GUM	32	N	929		24" BOX	2
	931	SILVER DOLLAR GUM	21	N	931		24" BOX	2
	932	RIVER RED GUM	36	N	932		24" BOX	2
Λ	937	RIVER RED GUM	24	N	937		24" BOX	2
4	938	CABBAGE PALM	50	N	938		24" BOX	2
3	939	SOUTHERN MAGNOLIA	30	N	939		24" BOX	2
3	940	COAST LIVE OAK	27	N	940	940 BLUE OAK	24" BOX	2
4	941	COAST LIVE OAK	26	Y Y				
3	942	SOUTHERN MAGNOLIA	26	Y N	0.47	943 BLUE OAK	24" DOV	2
4	943 944	SOUTHERN MAGNOLIA COAST REDWOOD	23 30	N Y	943	943 DLUE UAK	24" BOX	Z
3 3	944 947	VICTORIAN BOX	30 17, 15	Y N	047	947 KINDRED SPIRIT OAK	24" BOX	<u> </u>
2	947 948	PLUM	17, 15	N N	→ 947 → 948			2
۷								
	1	TOTAL PROTECTED TRE	ES REMOVED	43		TOTAL TREES REQUIRED REPLACE	)	43
					TOTAL T	TOTAL TREES PLANTED FOR RE	PLACEMENT	72
					*REPLACEMEN	PLACEMENT TREES WILL BE BLUI	OAK, KINDE	RED
					SPIRIT OAK OR	IT OAK OR ANOTHER APPROPRIA	ATE APPOVED	
					SPIRIT OAK OR NATIVE TREE. M		ATE APPOVED	



# ILLUSTRATED.


THE FENCE.

1. ALL PLANTS DESIGNATED TO BE SAVED SHALL BE PROTECTED BY FENCING, AS

2. INSTALL TREE PROTECTION FENCE AT TREE DRIP LINE OR AT EDGE OF DISTURBED AREA PRIOR TO COMMENCEMENT OF CONSTRUCTION.

3. SPACE TREE PROTECTION ZONE SIGNS A MINIMUM OF ONE EVERY 300 FEET. THE SIZE OF EACH SIGN MUST BE A MINIMUM OF 2' x 2' AND BE VISIBLE FROM BOTH SIDES OF THE SIGN MUST CONTAIN THE FOLLOWING LANGUAGE IN BOTH ENGLISH & SPANISH:

# Woodland Park Euclid Improvements

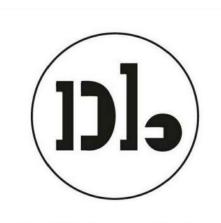

**David Baker Architects** dbarchitect.com 461 Second St, Loft c127 San Francisco, CA 94107 415.896.6700



	Issuances
Description	Date

		Revisions
Rev.	Description	Date

Set Title

Design Update -February 2024

Drawing Title

Tree Protection and **Removals List** and Notes

Sheet No.

**T-0.1** 

Date Project No. 27 February, 2024 21620







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PROTECTED TREE TO BE PRESERVED

<u>#000</u> <u>#000</u>

PROTECTED TREE TO BE REMOVED

ADDITIONAL PROTECTED TREE TO BE REMOVED

NEW REPLACEMENT TREE

TREE QUANTITY IN AREA TREE SPECIES KEY, REFER TO PLANT LIST FOR TREE SPECIES

### NOTES:

•

- 1. FOR LANDSCAPE MATERIALS, REFER TO SITE
- FOR FULL PLANT LIST, REFER TO LANDSCAPE SCHEDULES.
   FOR TREE PRESERVATION LIST, REFER TO TREE PROTECTION AND REMOVALS LIST.

PLANT	LIST	
TREES		
KEY	COMMON NAME	
FRAM	WHITE ASH	
ARMA	MARINA STRAWBERRY TREE	
QUDO	BLUE OAK	
PIXR	RED PUSH PISTACHE	
QUKI	KINDRED SPIRIT OAK	
PAPE	IRONWOOD	

\*REPLACEMENT TREES WILL BE BLUE OAK, KINDERED SPIRIT OAK OR ANOTHER APPROPRIATE APPOVED NATIVE TREE. MINIMUM 24" BOX SIZE.

# Woodland Park Euclid Improvements **David Baker Architects** dbarchitect.com 461 Second St, Loft c127 San Francisco, CA 94107 415.896.6700



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Entitlements Application

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**Tree Protection** & Removal Plan

Sheet	No.
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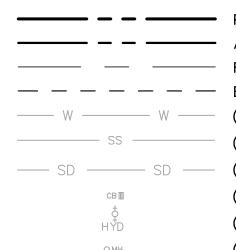
T-1.1

Date	
Project	Ν

27 February, 2024 21620



# LEGEND:



PROPERTY LINE ADJACENT PROPERTY LINE ROAD CENTERLINE - EASEMENT (E)WATER LINE (E)SANITARY SEWER LINE (E)STORM DRAIN LINE (E)CATCH BASIN (E)FIRE HYDRANT (E)MANHOLE

### **ABBREVIATIONS:**

BOUNDARY EXISTING (E) (T) TOTAL TYP TYPICAL CB CATCH BASIN FH, HYD FIRE HYDRANT MANHOLE MH MISC MISCELLANEOUS WATER SS SANITARY SEWER

### **BASIS OF BEARING:**

THE BEARING NORTH 88°27'00" EAST OF THE NORTHERLY LINE OF WEEKS STREET AS SAID BEARING IS SHOWN ON THAT CERTAIN RECORD OF SURVEY, FILED FOR RECORD ON SEPTEMBER 6, 1995 IN BOOK 16 OF L.L.S. MAPS AT PAGE 25, RECORDS OF SAN MATEO COUNTY, WAS HELD AS THE BASIS OF BEARINGS OF THIS SURVEY.

### **BENCHMARK:**

CITY OF EAST PALO ALTO BENCHMARK: BM-5

DRIVEN STAINLESS STEEL ROD IN SLEEVE MONUMENT IN GRADE BOX (MARKED SURVEY MONUMENT EPA BM) IN LANDSCAPING AT SOUTH EDGE OF NEWBRIDGE STREET SIDEWALK NEAR INTERSECTION WITH BAY ROAD AND 100' WESTERLY OF BUS STOP.

ELEVATION = 16.81 FEET, BASED ON THE NORTH AMERICAN VERTICAL DATUM OF 1988 (NAVD88).


## NOTES:

- 1. EXISTING CONDITIONS OBTAINED FROM AERIAL SURVEY DATED 11/09/2016.
- 2. FEMA FLOOD HAZARD INFORMATION: FLOOD ZONE X, AREAS OF MINIMAL FLOOD HAZARD, PER MAP NUMBER 06081C0309F, PANEL 309 OF 510, DATED APRIL 5, 2019.
- 3. PROPERTY LINES ARE SHOWN FOR REFERENCE AND ARE NOT RESOLVED.
- 4. THE TYPES, LOCATIONS, SIZES AND/OR DEPTHS OF EXISTING UNDERGROUND UTILITIES AS SHOWN ARE APPROXIMATE AND WERE OBTAINED FROM SOURCES OF VARYING RELIABILITY. ONLY ACTUAL EXCAVATION WILL REVEAL THE TYPES, EXTENT, SIZES, LOCATIONS AND DEPTHS OF SUCH UNDERGROUND UTILITIES. A REASONABLE EFFORT HAS BEEN MADE TO LOCATE AND DELINEATE ALL KNOWN UNDERGROUND UTILITIES. HOWEVER, THE ENGINEER CAN ASSUME NO RESPONSIBILITY FOR THE COMPLETENESS OR ACCURACY OF ITS DELINEATION OF SUCH UNDERGROUND UTILITIES WHICH MAY BE ENCOUNTERED, BUT WHICH ARE NOT SHOWN ON THIS SURVEY.
- 5. SEE LANDSCAPING TREE DISPOSITION PLAN FOR ALL EXISTING TREES TO BE REMOVED OR TO REMAIN.

# NORTH

# Woodland Park

# Euclid Improvements

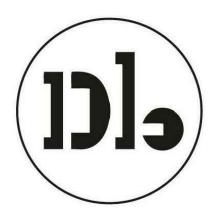

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EXISTING CONDITIONS AND DEMOLITION PLAN


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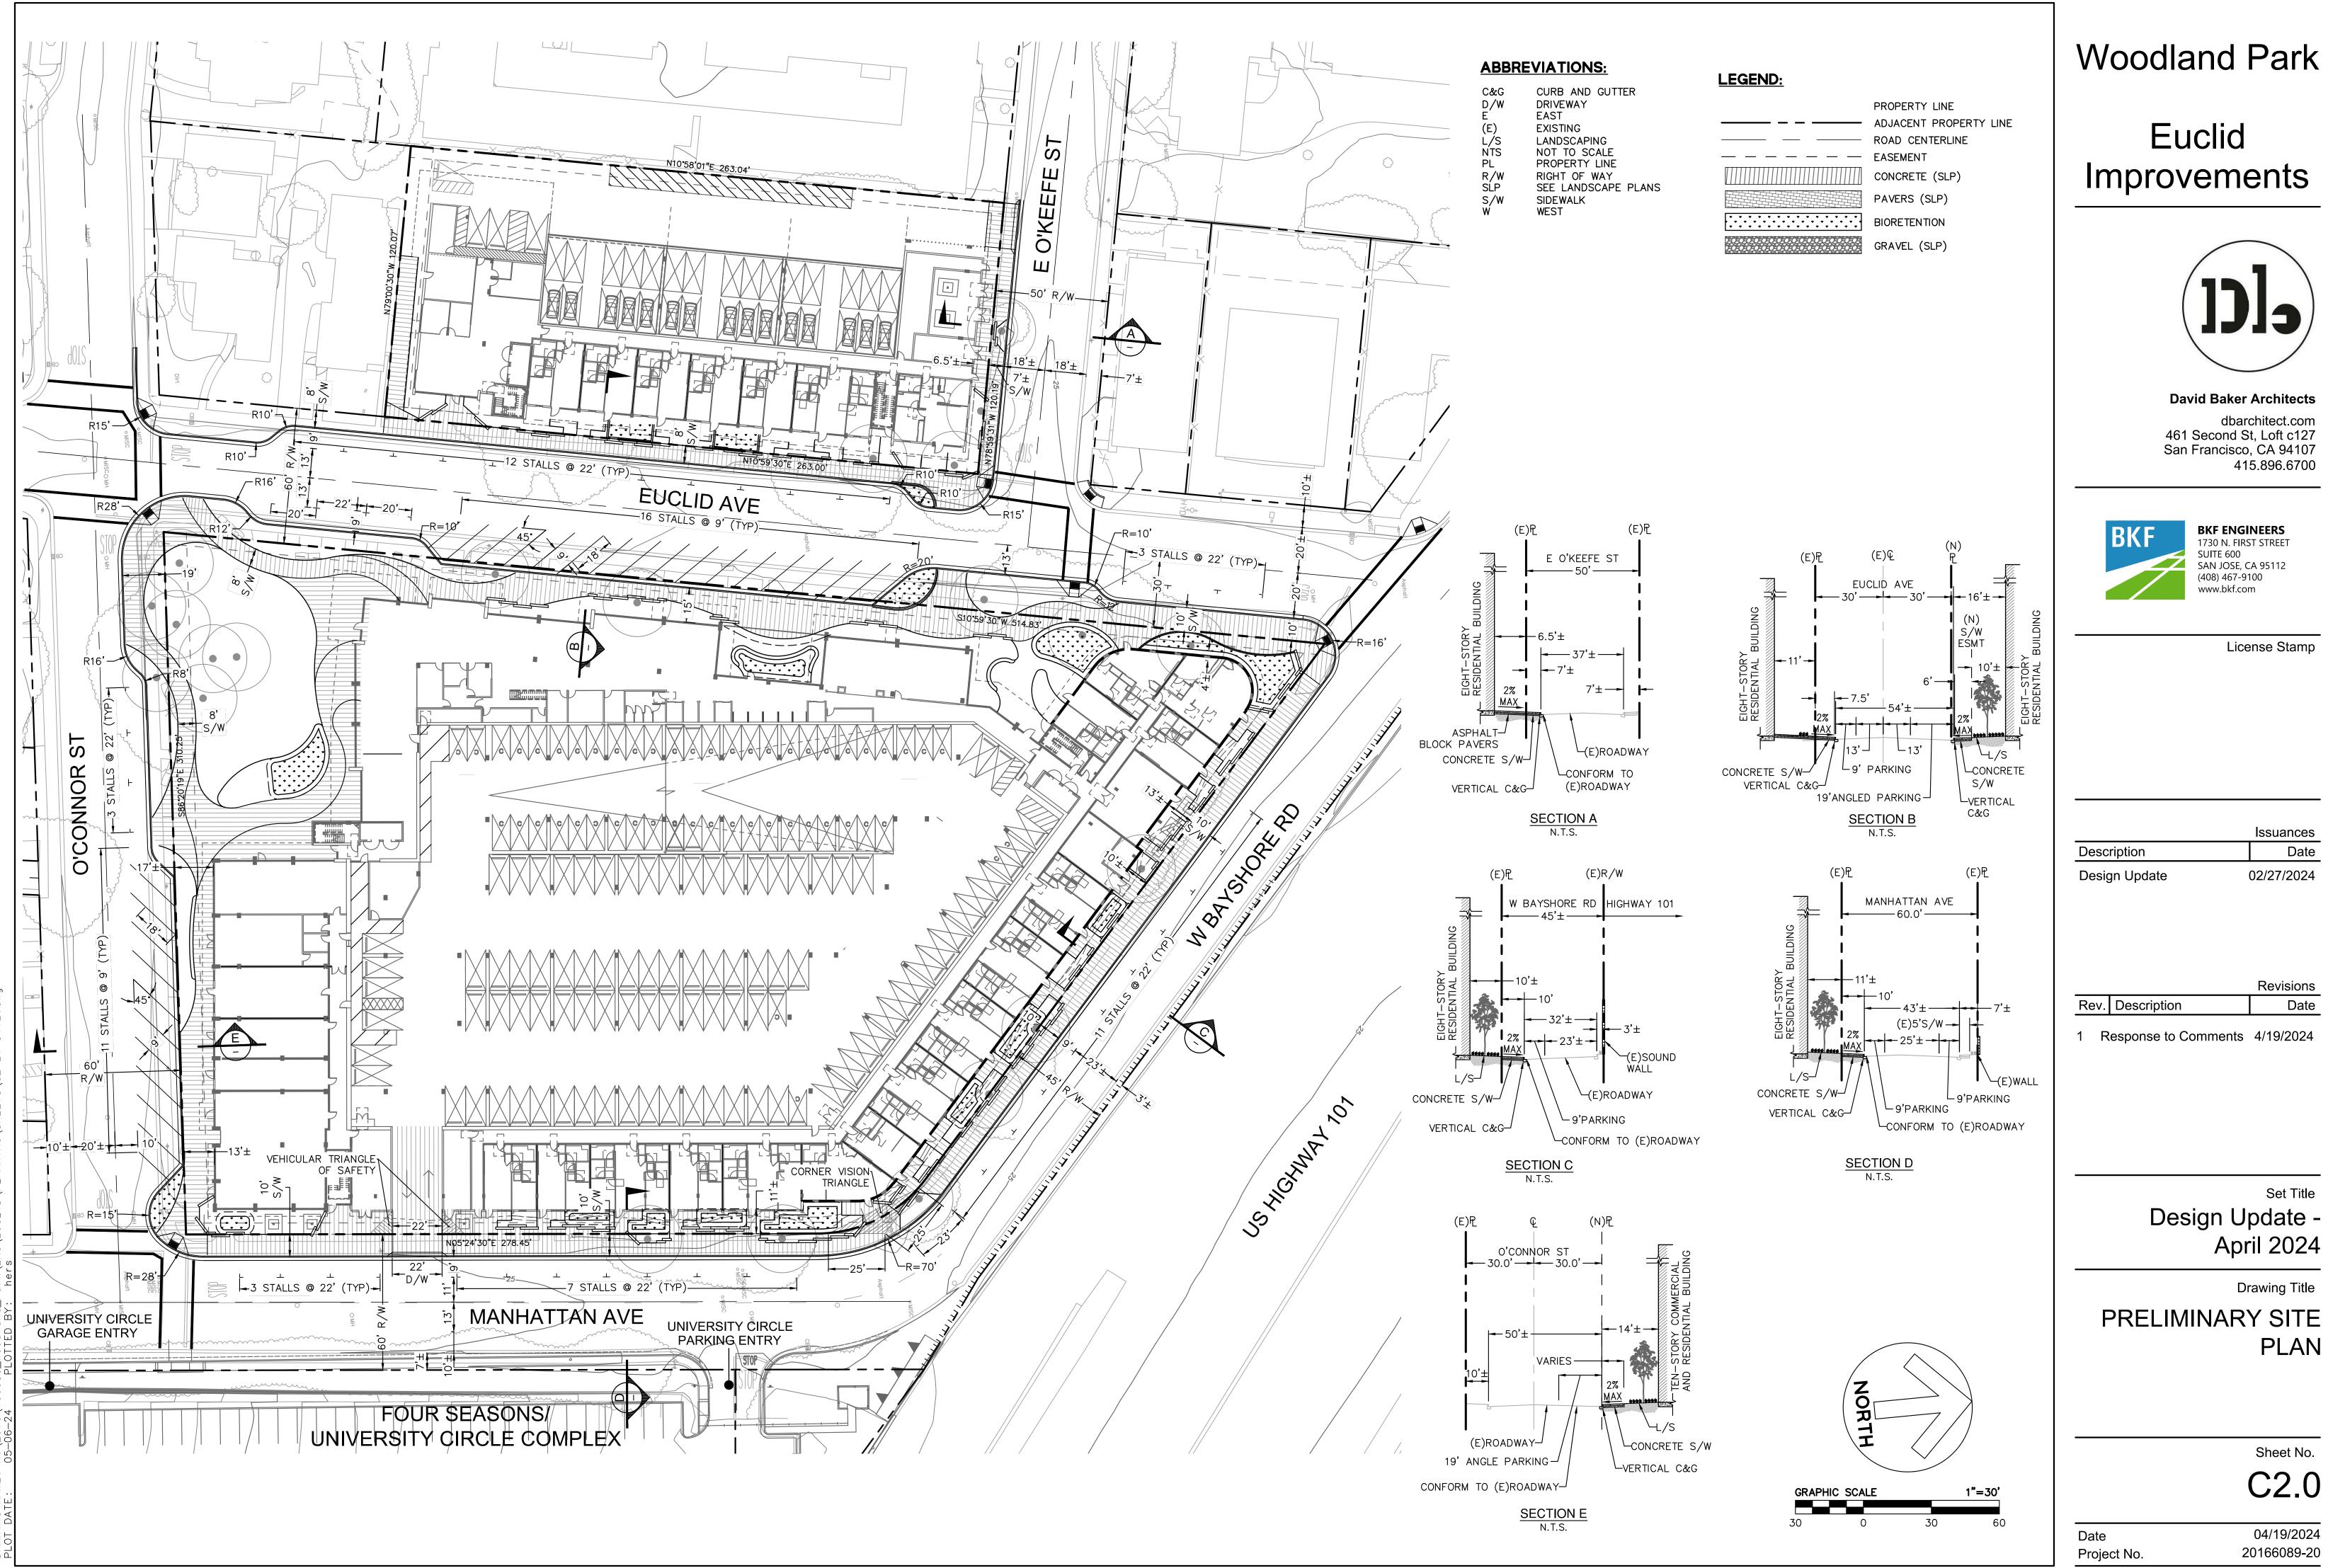
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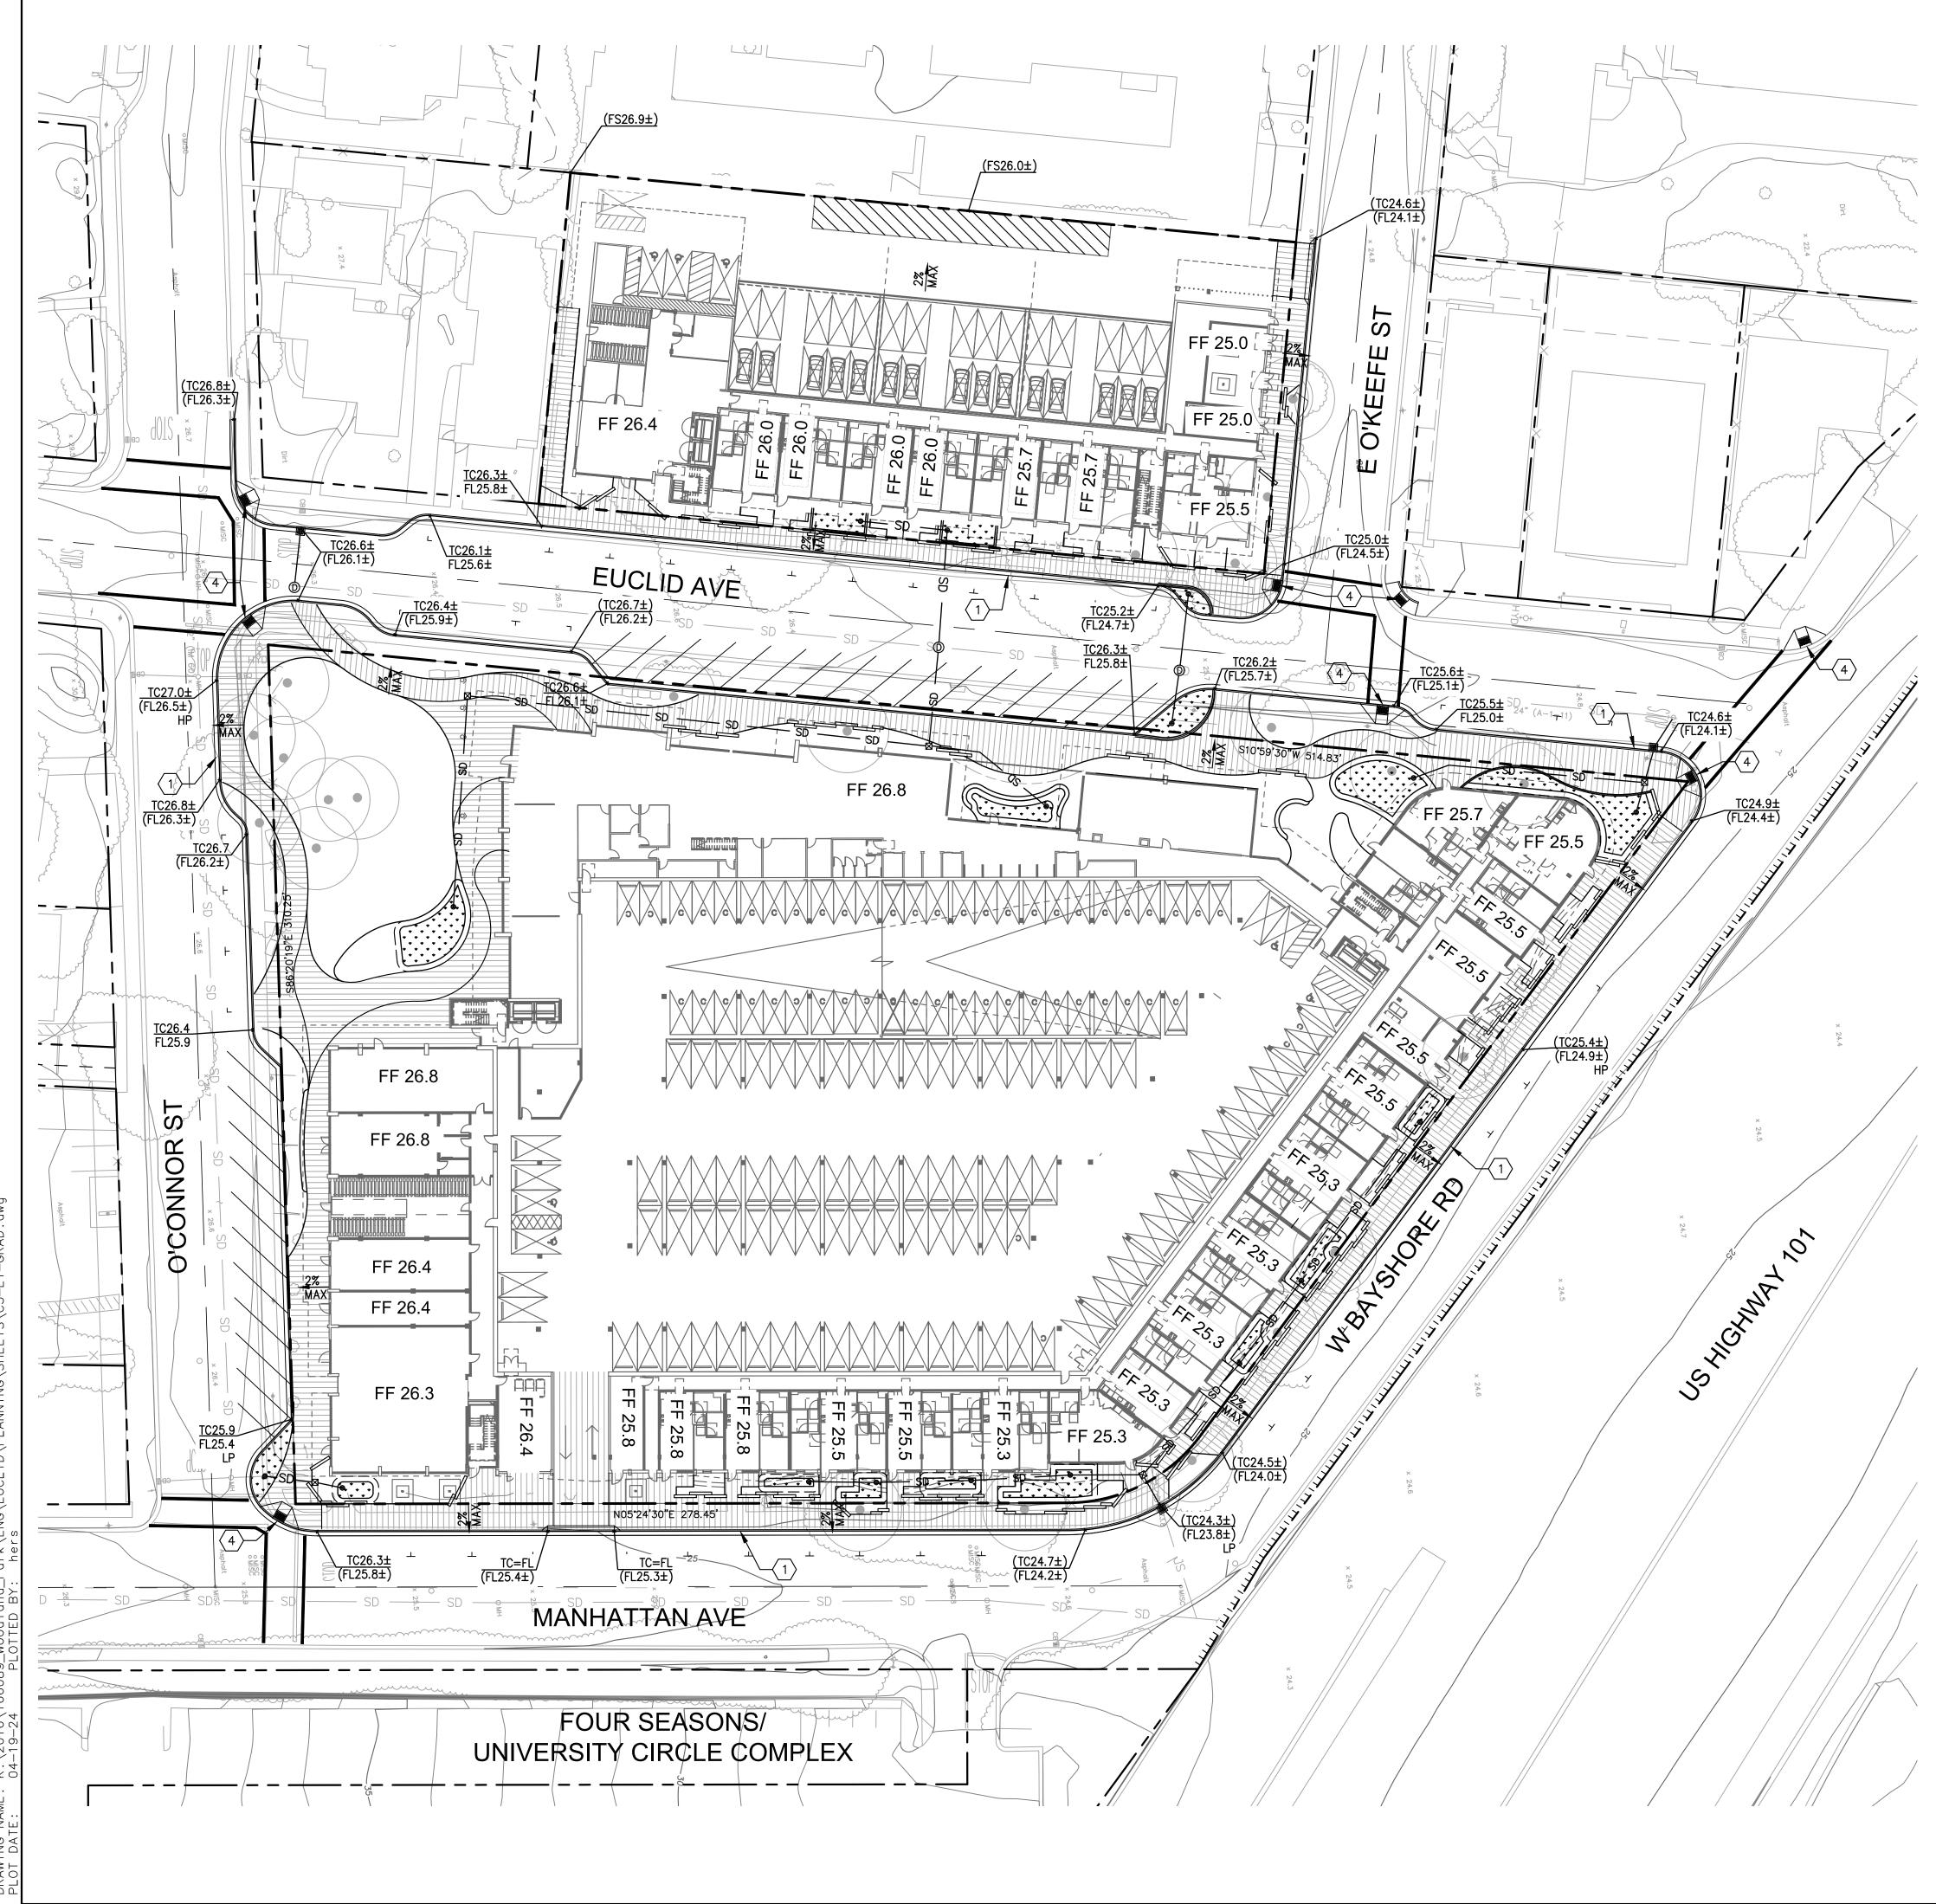
Drawing Title

PRELIMINARY SITE PLAN

Sheet No.

C2.0

04/19/2024 20166089-20

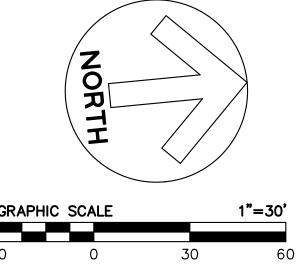

### LEGEND:

	GRADE BREAK
X%	SLOPE
FL26.5	SPOT ELEVATION
(FL26.0±)	SPOT ELEVATION, CONFORM TO EXISTING
	SD JUNCTION BOX
<b>e</b>	SD OVERFLOW DRAIN
	BIORETENTION AREA
	PROPERTY LINE
	ADJACENT PROPERTY LINE
	ROAD CENTERLINE
	EASEMENT

# **ABBREVIATIONS:**


AMERICANS WITH DISABILITIES ACT ADA BLDG BUILDING BACK OF SIDEWALK BW EXISTING ΕX FINISHED FLOOR FF FG FINISHED GRADE FL FLOWLINE FINISHED SURFACE FS HP HIGH POINT LOW POINT LP MATCH MA MAX MAXIMUM MIN MINIMUM FL TC PAVEMENT TOP OF CURB

### **GRADING NOTES:**

- UNLESS OTHERWISE NOTED, ALL EXTERIOR DOORWAYS AND ACCESSIBLE PATHS OF TRAVEL SHALL BE ADA COMPLIANT.
- 2. SLOPES ALONG ACCESSIBLE PATHS OF TRAVEL SHALL NOT EXCEED A RUNNING SLOPE OF 1:20 OR A CROSS SLOPE OF 1:48. ACCESSIBLE WALKS AND SIDEWALKS SHALL BE 48" WIDE, MINIMUM. ANY AREAS ON THE SITE NOT CONFORMING TO THESE BASIC RULES DUE TO EXISTING CONDITIONS OR DISCREPANCIES IN THE DOCUMENTS ARE TO BE REPORTED TO THE ENGINEER/ARCHITECT PRIOR TO PROCEEDING WITH PLACEMENT OF BASE ROCK, FORM WORK AND/OR FLATWORK.
- CONTRACTOR SHALL EXERCISE EXTREME CARE TO CONFORM TO THE LINES. GRADES, SECTIONS AND DIMENSIONS AS SET FORTH ON THESE PLANS. ALL GRADED AREAS SHALL CONFORM TO THE VERTICAL ELEVATIONS SHOWN WITH A TOLERANCE OF ONE-TENTH OF A FOOT. WHERE GRADED AREAS DO NOT CONFORM TO THESE TOLERANCES, THE CONTRACTOR SHALL BE REQUIRED TO PERFORM CORRECTIVE GRADING AT NO EXTRA COST TO THE OWNER.
- 4. IT SHALL BE CONTRACTOR'S RESPONSIBILITY TO CONFIRM THE GROUND ELEVATIONS AND OVERALL TOPOGRAPHY PRIOR TO THE START OF CONSTRUCTION AS TO THE ACCURACY BETWEEN THE WORK SET FORTH ON THESE PLANS AND THE WORK IN THE FIELD. ANY DISCREPANCIES SHALL BE IMMEDIATELY BROUGHT TO THE ATTENTION OF THE ENGINEER/ARCHITECT IN WRITING PRIOR TO THE START OF CONSTRUCTION WHICH MAY REQUIRE CHANGES IN DESIGN AND/OR AFFECT THE EARTHWORK QUANTITIES.
- 5. LANDSCAPING DIRECTLY ADJACENT TO THE BUILDING SHALL BE A MINIMUM OF 8" BELOW WOOD FRAMING AND SHEATHING THAT IS NOT NATURALLY DURABLE OR PRESERVATIVE-TREATED.
- 6. LANDSCAPING DIRECTLY ADJACENT TO THE BUILDING SHALL SLOPE AWAY FROM THE BUILDING WITH A MINIMUM SLOPE OF 5% FOR THE FIRST 10 FEET. IF PHYSICAL OBSTRUCTIONS OR LOT LINES PROHIT 10 FEET OF HORIZONTAL DISTANCE, A 5% SLOPE SHALL BE PROVIDED TO AN APPROVED ALTERNATIVE METHOD OF DIVERTING WATER AWAY FROM THE FOUNDATION. SWALE USED FOR THIS PURPOSE SHALL BE SLOPED A MINIMUM OF 2% WHERE LOCATED WITHIN 10 FEET OF THE BUILDING FOUNDATION.
- 7. IMPERVIOUS SURFACES WITHIN 10 FEET OF THE BUILDING FOUNDATION SHALL BE SLOPED A MINIMUM OF 2% AWAY FROM THE BUILDING.
- 8. UNDERGROUND SERVICE ALERT (USA) SHALL BE CONTACTED AT LEAST 48 HOURS PRIOR TO ANY EXCAVATION.
- 9. ANY LAND DISTURBING ACTIVITIES OCCURRING BETWEEN OCTOBER 1ST AND APRIL 30TH ARE RESTRICTED BY THE CITY. A DETAILED EROSION AND SEDIMENT CONTROL PLAN SHALL BE REQUIRED FOR ACTIVITIES OCCURRING DURING THIS PERIOD AND APPROVAL IN WRITING BY THE CITY ENGINEER.
- 10. GRADING ACTIVITIES AND ASSOCIATED NOISE SHALL BE LIMITED TO WEEK DAYS BETWEEN THE HOURS OF 8AM TO 5PM. NO GRADING ACTIVITIES ARE TO OCCUR ON SATURDAYS AND SUNDAYS, WITHOUT SPECIAL PERMISSION FROM THE CITY ENGINEER.
- 11. ALL GRADING SHALL CONFORM TO APPROVED SPECIFICATIONS PRESENTED HEREON OR ATTACHED HERETO. ALL GRADING WORK SHALL BE OBSERVED AND APPROVED BY THE GEOTECHNICAL ENGINEER.
- 12. PER THE GEOTECHNICAL FEASIBILITY STUDY PREPARED BY GEOSPHERE CONSULTANTS, INC, DATED DECEMBER 27, 2017: THE HISTORICAL HIGH GROUNDWATER DEPTH IS ESTIMATED TO BE ON THE ORDER OF 13 FEET AT THE PROJECT SITE. DURING SITE INVESTIGATIONS, GROUNDWATER WAS ENCOUNTERED AT DEPTHS OF 15 TO 16 FEET BELOW EXISTING SURFACE (APPROXIMATE ELEVATION OF 7-10 FEET).


# KEY NOTES:

- $\langle 1 \rangle$  NEW VERTICAL CURB AND GUTTER
- 2 NEW VERTICAL CURB
- 3 NEW VALLEY GUTTER
- $\langle 4 \rangle$  NEW CURB RAMP

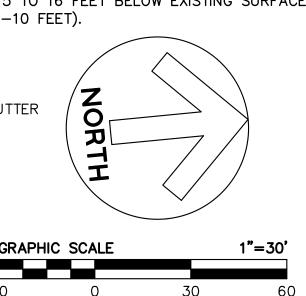

# Woodland Park

# Euclid Improvements

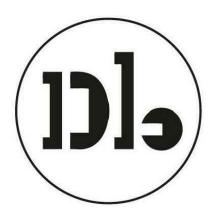

# **David Baker Architects**

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1 Response to Comments 4/19/2024

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PRELIMINARY GRADING AND DRAINAGE PLAN


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Date Project No.

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$\setminus$ $\setminus$ $\setminus$	



### LEGEND:

— ss —	SANITARY SEWER LINE		
S	SANITARY SEWER MANHOLE		
— SD —	STORM DRAIN LINE		
	SD PERFORATED PIPE		
	SD CATCH BASIN		
	SD JUNCTION BOX		
0	SD OVERFLOW DRAIN		
D	STORM DRAIN MANHOLE		
——w ——	DOMESTIC WATER LINE		
——FW——	FIRE WATER LINE, SEE NOTE 6		
	BACKFLOW PREVENTER		
M	WATER METER		
M	WATER VALVE		
++++	FIRE HYDRANT		
	BIORETENTION AREA		
ABBREVIATIONS:			

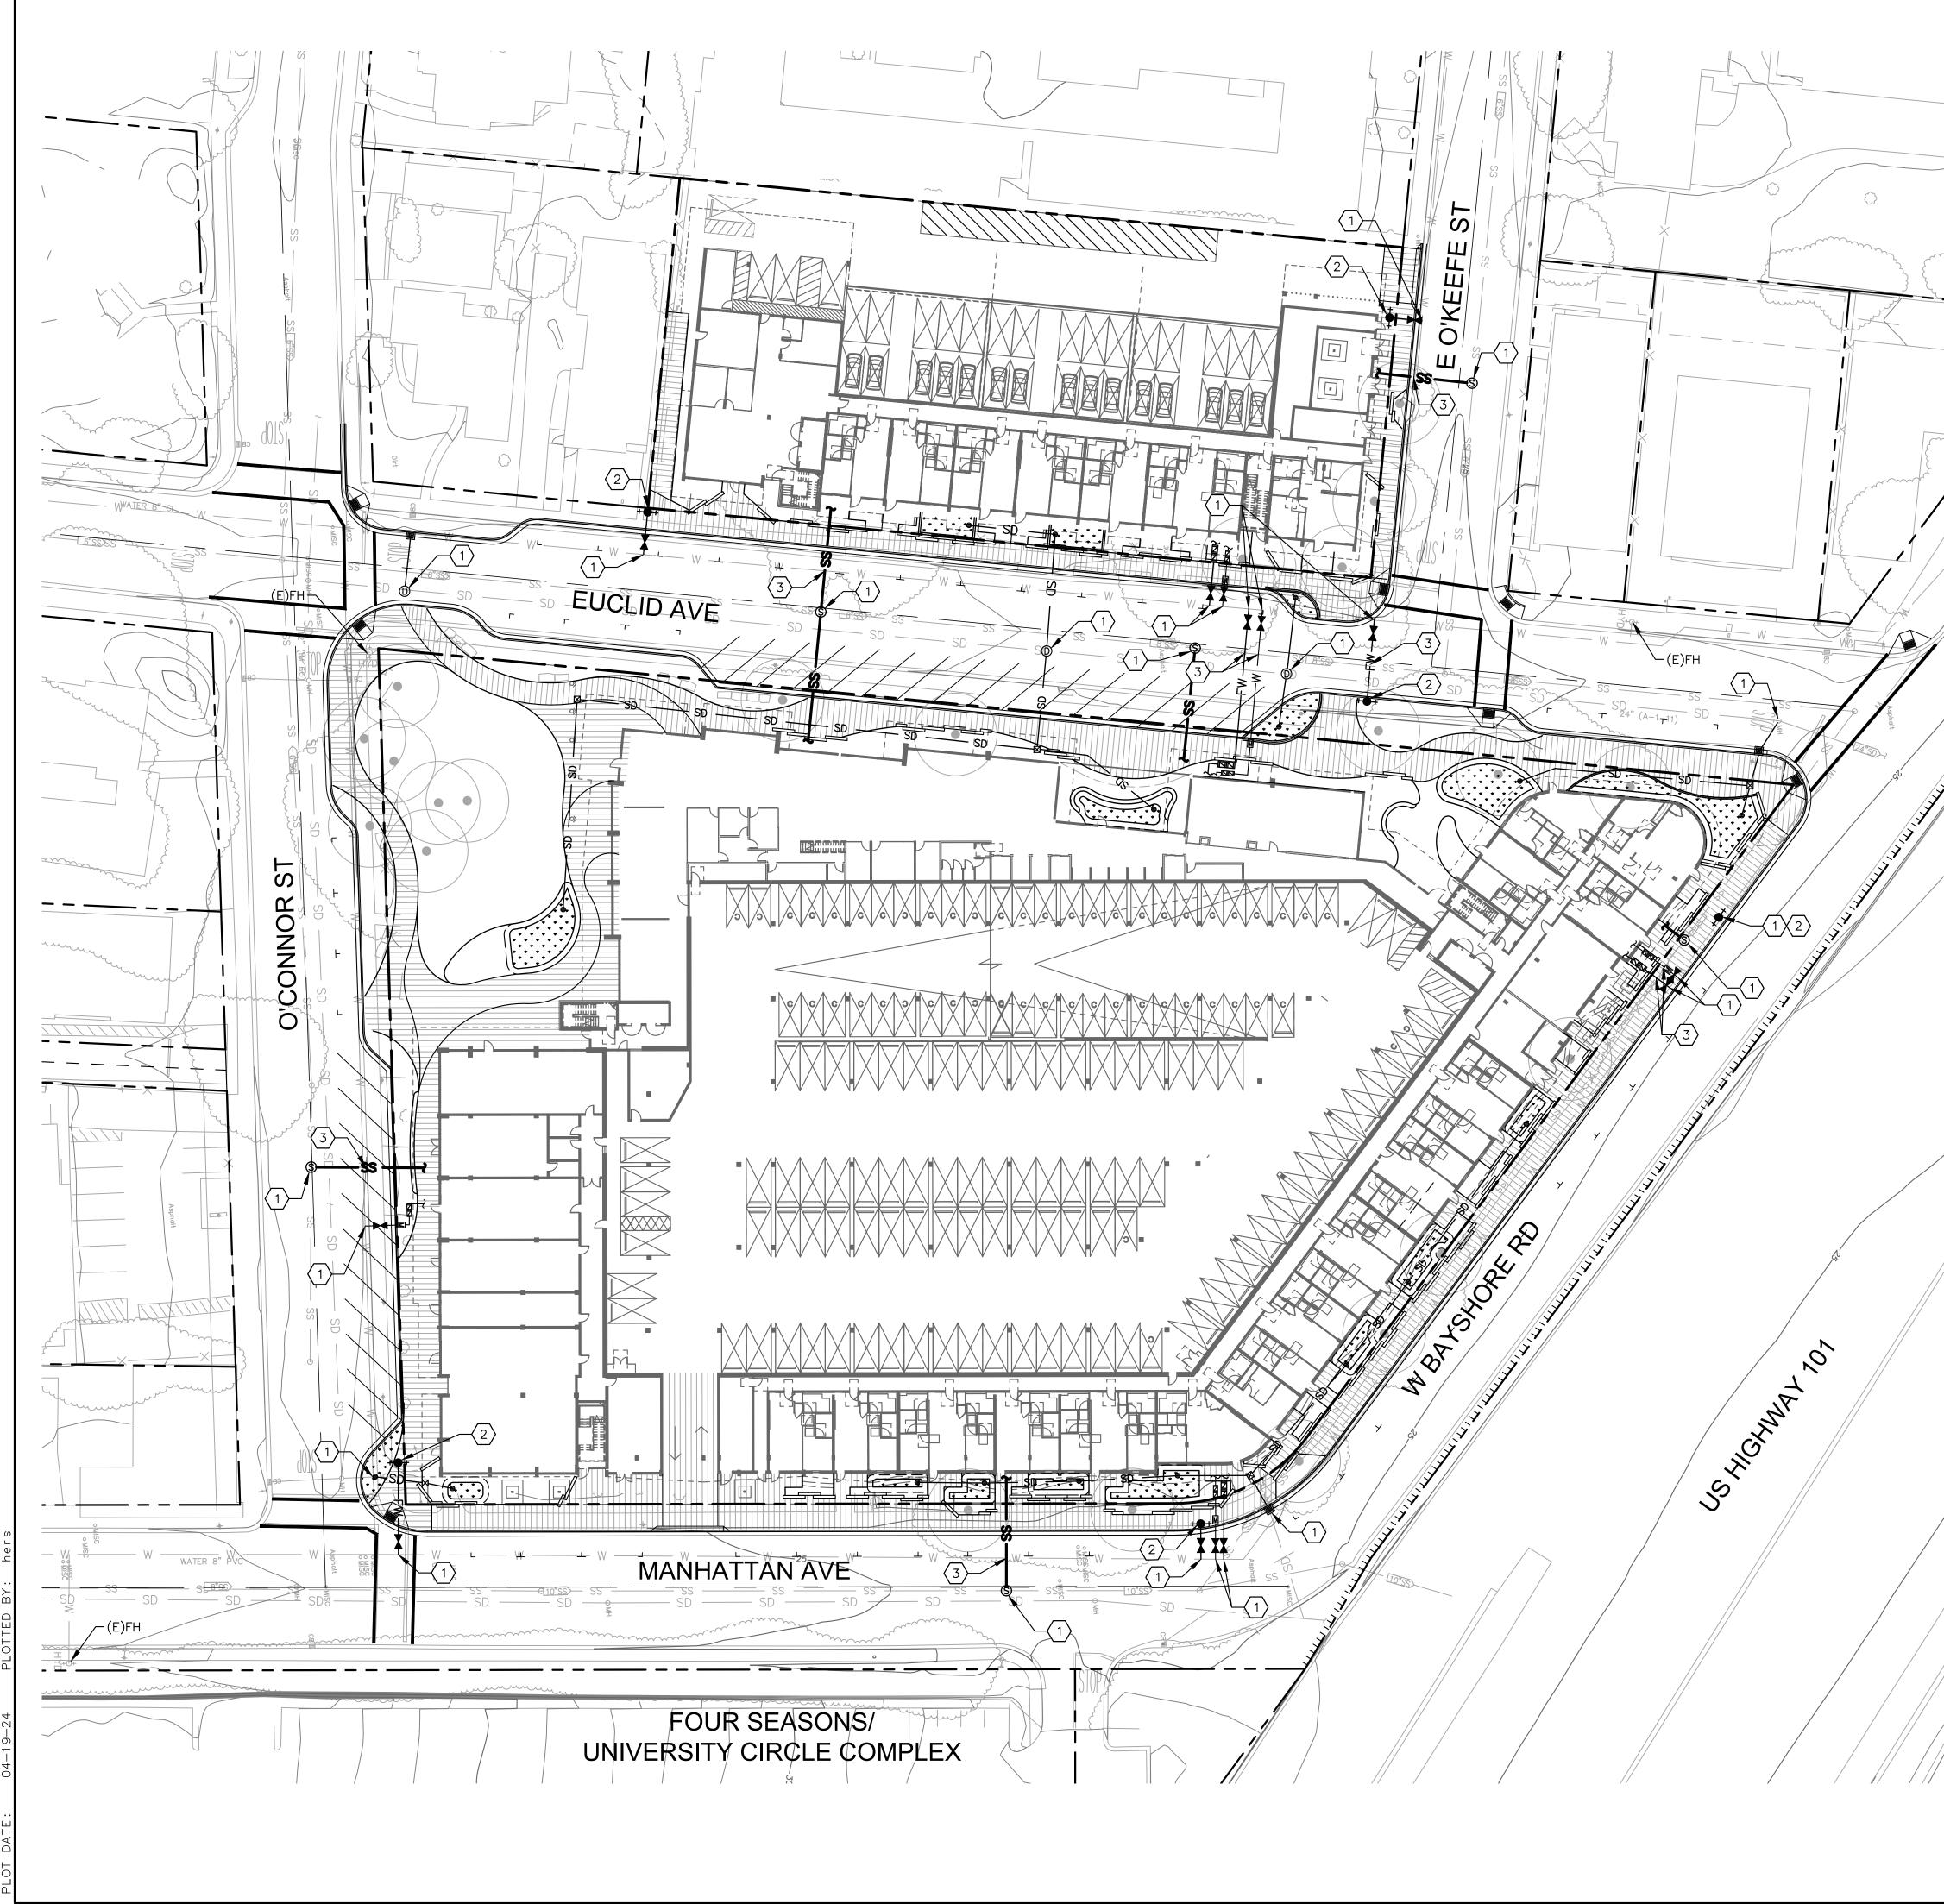BACKFLOW PREVENTOR RFD


CB CATCH EX,(E) EXISTI FW FIRE M HYD,FH FIRE M MH MANH PVC POLYV SD STORM SDCO STORM SDCO STORM SDMH STORM SS SANIT SSCO SANIT	WATER HYDRANT OLE /INYL CHLORIDE /I DRAIN /I DRAIN CLEANOUT /I DRAIN MANHOLE ARY SEWER ARY SEWER CLEANOUT ARY SEWER MANHOLE
---	--

### UTILITY NOTES:

- 1. THE TYPES, LOCATIONS, SIZES AND/OR DEPTHS OF EXISTING UNDERGROUND UTILITIES AS SHOWN ARE APPROXIMATE AND WERE OBTAINED FROM SOURCES OF VARYING RELIABILITY. ONLY ACTUAL EXCAVATION WILL REVEAL THE TYPES, EXTENT, SIZES, LOCATIONS AND DEPTHS OF SUCH UNDERGROUND UTILITIES. A REASONABLE EFFORT HAS BEEN MADE TO LOCATE AND DELINEATE ALL KNOWN UNDERGROUND UTILITIES. HOWEVER, THE ENGINEER CAN ASSUME NO RESPONSIBILITY FOR THE COMPLETENESS OR ACCURACY OF ITS DELINEATION OF SUCH UNDERGROUND UTILITIES WHICH MAY BE ENCOUNTERED, BUT WHICH ARE NOT SHOWN ON THIS SURVEY.
- 2. NO EXISTING UTILITY SERVICES WILL BE REUSED. ALL EXISTING SERVICES WILL BE REMOVED TO THE PROPERTY LINE AND ABANDONED OR REMOVED PER CITY STANDARDS.
- 3. ALL WORK DONE WITHIN THE PUBLIC RIGHT OF WAY SHALL BE PER SEPARATE PERMIT.
- 4. SEE JOINT TRENCH PLANS FOR ALL DRY UTILITIES AND JOINT TRENCH INFORMATION.
- 5. SEE MEP PLANS FOR CONTINUATION AT BUILDING POINT OF CONNECTION.
- 6. NEW FIRE WATER SERVICE FOR REFERENCE ONLY. FINAL DESIGN BY FIRE PROTECTION ENGINEER.
- 7. CONTRACTOR TO VERIFY ALL (E)UTILITY TIE-IN LOCATIONS AND CROSSINGS BY POTHOLING PRIOR TO INSTALLATION.
- 8. TRENCHES SHALL NOT BE LEFT OPEN OVERNIGHT IN EXISTING PUBLIC STREET AREAS. CONTRACTOR SHALL BACKFILL TRENCHES OR PLACE STEEL PLATING WITH ADEQUATE CUTBACK TO PREVENT SHIFTING OF STEEL PLATE AND/OR HOT-MIX ASPHALT REQUIRED TO PROTECT OPEN TRENCHES AT THE END OF THE WORKING DAY.
- 9. A MINIMUM OF 10 FEET HORIZONTAL SEPARATION SHALL BE MAINTAINED BETWEEN WATER AND SEWER LINES AND 1 FOOT VERTICAL WATER ABOVE SEWER WHERE LINES CROSS. WATER AND SEWER LINES SHALL NOT CROSS AT LESS THAN 45 DEGREES TO EACH OTHER.
- 10. UTILITY TRENCHES SHALL USE TRENCH SAND AROUND ALL UTILITIES CONFORMING TO APPROPRIATE STANDARDS SUCH AS PG&E, CALIFORNIA AMERICAN WATER COMPANY STANDARDS, AND SAN MATEO COUNTY PUBLIC WORKS STANDARDS.
- 11. THE CITY OF EAST PALO ALTO ENGINEERING DIVISION SHALL BE CONTACTED 48 HOURS PRIOR TO INSTALLATION OR CONNECTION FOR INSPECTION OF ANY UTILITIES CONNECTING TO MUNICIPAL FACILITIES.
- 12. EAST PALO ALTO SANITARY DISTRICT SHALL BE CONTACTED 48 HOURS PRIOR TO INSTALLATION OF CONNECTION FOR INSPECTION OF SEWER LINES AND CONNECTIONS. ADDITIONALLY, FOR ANY WORK IN THE PUBLIC RIGHT OF WAY CONTACT THE CITY OF EAST PALO ALTO ENGINEERING DIVISION FOR INSPECTION.
- 13. PACIFIC GAS & ELECTRIC, COMCAST, AT&T, AND ALL OTHER APPROPRIATE UTILITIES COMPANIES SHALL BE CONTACTED AT LEAST 48 HOURS PRIOR TO INSTALLATION TO SCHEDULE ANY REQUIRED INSPECTIONS, OR AS REQUIRED BY SAID UTILITIES. ADDITIONALLY, FOR ANY WORK IN THE PUBLIC RIGHT OF WAY CONTACT THE CITY OF EAST PALO ALTO ENGINEERING DIVISION FOR INSPECTION.
- 14. ALL EXISTING WATER MAINS SHALL BE REPAIRED AND TESTED TO THE SATISFACTION OF AMERICAN WATER ENTERPRISES AND THE CITY ENGINEER.
- 15. ALL WORK WITHIN THE PUBLIC RIGHT OF WAY SHALL CONFORM TO EAST PALO ALTO SUBDIVISION REGULATIONS, SAN MATEO COUNTY STANDARD DETAILS FOR PUBLIC WORKS, CALIFORNIA DEPARTMENT OF TRANSPORTATION STANDARD DETAILS, GREEN BOOK STANDARD SPECIFICATIONS, AMERICAN WATER COMPANY CODE, EAST PALO ALTO SANITARY DISTRICT SEWER CODE, FIRE CODE, AND OTHER APPLICABLE UTILITY STANDARDS WITHIN THEIR RESPECTIVE JURISDICTIONS.


### KEY NOTES:

- (1) CONNECT TO EXISTING UTILITY
- $\langle 2 \rangle$  NEW FIRE HYDRANT
- MAINTAIN MINIMUM OF 1 FOOT SEPARATION BETWEEN WATER OVER SEWER  $\langle 3 \rangle$

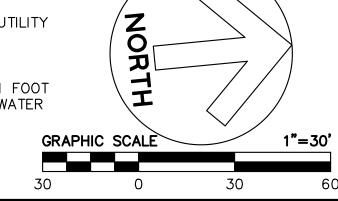

# Woodland Park

# Euclid Improvements

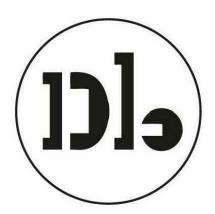

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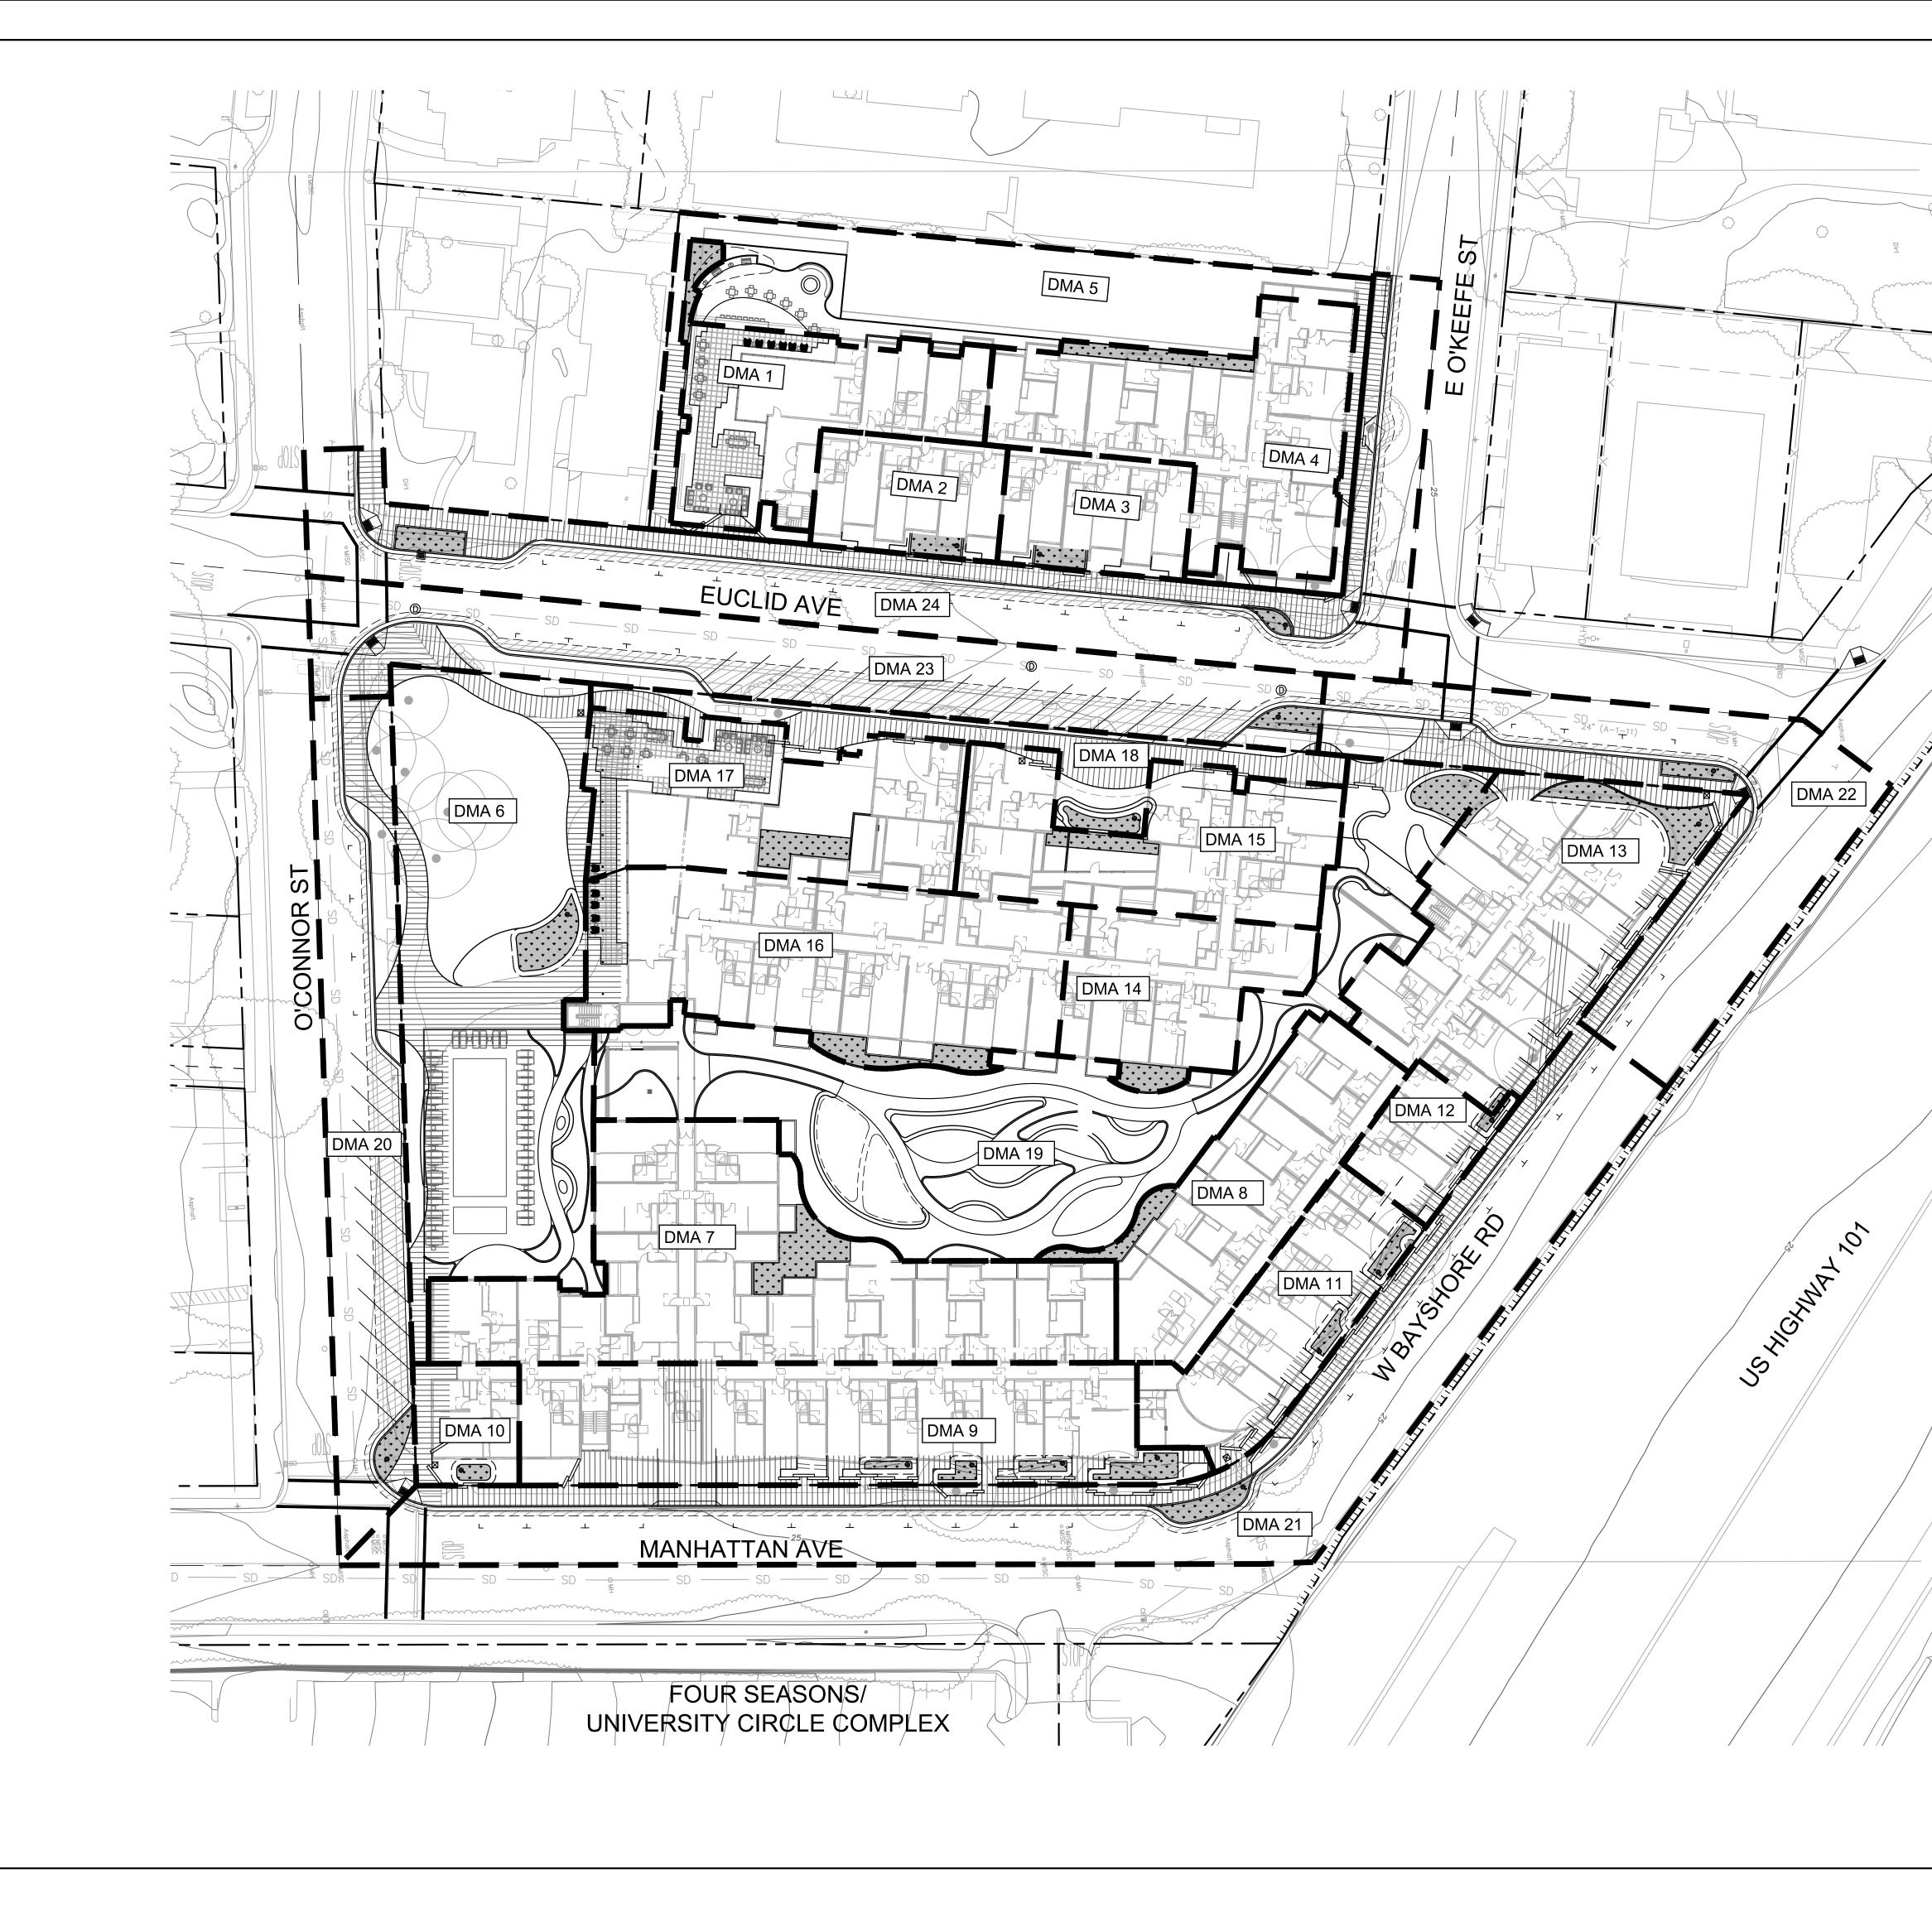
PRELIMINARY UTILITY PLAN

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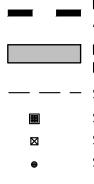
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# LEGEND




 DRAINAGE MANAGEMENT AREA (DMA) BOUNDARY
 INTEGRATED MANAGEMENT PRACTICE (IMP)
 SD PERFORATED PIPE SD CATCH BASIN SD JUNCTION BOX

SD OVERFLOW DRAIN

# Woodland Park

# Euclid Improvements

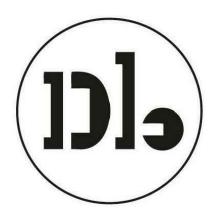

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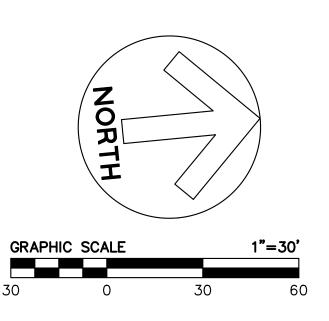
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PRELIMINARY STORMWATER MANAGEMENT PLAN

Sheet No.

C5.0

Date Project No. 06/04/2024 20166089-20



		TREATMENT CONT	FROL MEASURE SUMMA	NRY			
DRAINAGE	DRAINAGE AREA	PROPOSED	CONDITION	TREATMENT MEASURE SIZE			
AREAS	SIZE (SF)	PERVIOUS SURFACE (SF)	IMPERVIOUS SURFACE (SF)	REQUIRED (SF)	PROVIDED (SF)	TREATMENT MEASURE TYPE	
DMA-1	6,270	LANDSCAPE 241	ROOF/SIDEWALK 6,029	241	241	STRUCTURAL BIORETENTION AREA	
DMA-2	3,107	LANDSCAPE 93	ROOF/SIDEWALK 3,014	121	136	STRUCTURAL BIORETENTION AREA	
DMA-3	3,107	LANDSCAPE 102	ROOF/SIDEWALK 3,005	120	137	STRUCTURAL BIORETENTION AREA	
DMA-4	8,485	LANDSCAPE 325	ROOF/SIDEWALK 8,120	325	365	STRUCTURAL BIORETENTION AREA	
DMA-5	10,627	LANDSCAPE 427	ROOF/SIDEWALK 10,200	N/A	N/A	PERMEABLE PAVERS	
DMA-6	16,590	LANDSCAPE 7,420	ROOF/SIDEWALK 9,170	367	368	NON-STRUCTURAL BIORETENTION AREA	
DMA-7	13,915	LANDSCAPE 868	ROOF/SIDEWALK 13,047	522	566	STRUCTURAL BIORETENTION AREA	
DMA-8	6,584	LANDSCAPE 341	ROOF/SIDEWALK 6,243	250	341	STRUCTURAL BIORETENTION AREA	
DMA-9	11,073	LANDSCAPE 973	ROOF/SIDEWALK 10,100	404	405	NON-STRUCTURAL BIORETENTION AREA	
DMA-10	1,819	LANDSCAPE 230	ROOF/SIDEWALK 1,589	64	73	NON-STRUCTURAL BIORETENTION AREA	
DMA-11	5,089	LANDSCAPE 429	ROOF/SIDEWALK 4,660	187	206	NON-STRUCTURAL BIORETENTION AREA	
DMA-12	1,978	LANDSCAPE 193	ROOF/SIDEWALK 1,785	71	71	NON-STRUCTURAL BIORETENTION AREA	
DMA-13	10,219	LANDSCAPE 550	ROOF/SIDEWALK 9,669	387	512	NON-STRUCTURAL BIORETENTION AREA	
DMA-14	4,754	LANDSCAPE 238	ROOF/SIDEWALK 4,516	181	238	STRUCTURAL BIORETENTION AREA	
DMA-15	6,904	LANDSCAPE 270	ROOF/SIDEWALK 6,634	265	270	STRUCTURAL BIORETENTION AREA	
DMA-16	11,111	LANDSCAPE 470	ROOF/SIDEWALK 10,641	426	470	STRUCTURAL BIORETENTION AREA	
DMA-17	7,782	LANDSCAPE 600	ROOF/SIDEWALK 7,182	287	344	STRUCTURAL BIORETENTION AREA	
DMA-18	4,040	LANDSCAPE 900	ROOF/SIDEWALK 3,140	125	153	NON-STRUCTURAL BIORETENTION AREA	
DMA-19	17,244	LANDSCAPE 8,212	ROOF/SIDEWALK 9,032	361	395	NON-STRUCTURAL BIORETENTION AREA	
TOTAL	150,698	22,882	127,816	4,684	5,291		

	TREATMENT CONTROL MEASURE SUMMARY (OFF-SITE)				
DRAINAGE DRAINAGE AREA		PROPOSED CONDITION	TREATMENT MEASURE SIZE		
AREAS	SIZE (SF)	NEW/REPLACED IMPERVIOUS SURFACE (SF)	REQUIRED (SF)	PROVIDED (SF)	TREATMENT MEASURE TYPE
DMA-20	9,378	ROAD/SIDEWALK 3,137	126	190	STRUCTURAL BIORETENTION AREA
DMA-21	19,417	ROAD/SIDEWALK 5,730	230	244	STRUCTURAL BIORETENTION AREA
DMA-22	11,060	ROAD/SIDEWALK 3,277	131	133	STRUCTURAL BIORETENTION AREA
DMA-23	11,944	ROAD/SIDEWALK 4,234	169	196	STRUCTURAL BIORETENTION AREA
DMA-24	16,122	ROAD/SIDEWALK 7,008	280	293 (SEE NOTE 2)	STRUCTURAL BIORETENTION AREA
TOTAL	67,921	23,386	936	1,056	

# <u>NOTES</u>

# Woodland Park

# Euclid Improvements



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Description	Date
Design Update	02/27/2024

		Revisions
Re	ev. Description	Date
1 2	Response to Comments Response to Comments	

Set Title Design Update -April 2024

Drawing Title

PRELIMINARY STORMWATER MANAGEMENT PLAN

Sheet No.


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Date Project No.


06/04/2024 20166089-20

1) TREATMENT AREAS WERE SIZED USING THE "4 PERCENT METHOD" FLOW-BASED SIZING CRITERIA IN THE 2014 SAN MATEO COUNTY C.3 STORMWATER TECHNICAL GUIDANCE HANDBOOK, UNLESS THE REQUIRED SF IS FOLLOWED BY AN ASTERISK "\*". IF REQUIRED SF HAS AN ASTERISK, TREATMENT IS SIZED USING THE COMBINED FLOW METHOD AND AT A MIN. PROVIDES AN EQUIVALENT OF 6-INCHES OF STORED RUNOFF IN SURFACE PONDING AREA.

2) DUE TO SITE CONSTRAINTS AND EXISTING GRADING PATTERNS ON E O'KEEFE STREET, ALL RUNOFF FROM NEW/REPLACED IMPERVIOUS AREA IN DMA 24 CANNOT BE CONVEYED TO PROPOSED TREATMENT AREAS. TO SATISFY MINIMUM TREATMENT REQUIREMENTS, TWO BIORETETION AREAS ARE BEING PROPOSED THAT WILL TREAT A LARGE MAJORITY OF THE NEW/REPLACED IMPERVIOUS AREA PLUS EXISTING IMPERVIOUS AREA TO REMAIN.

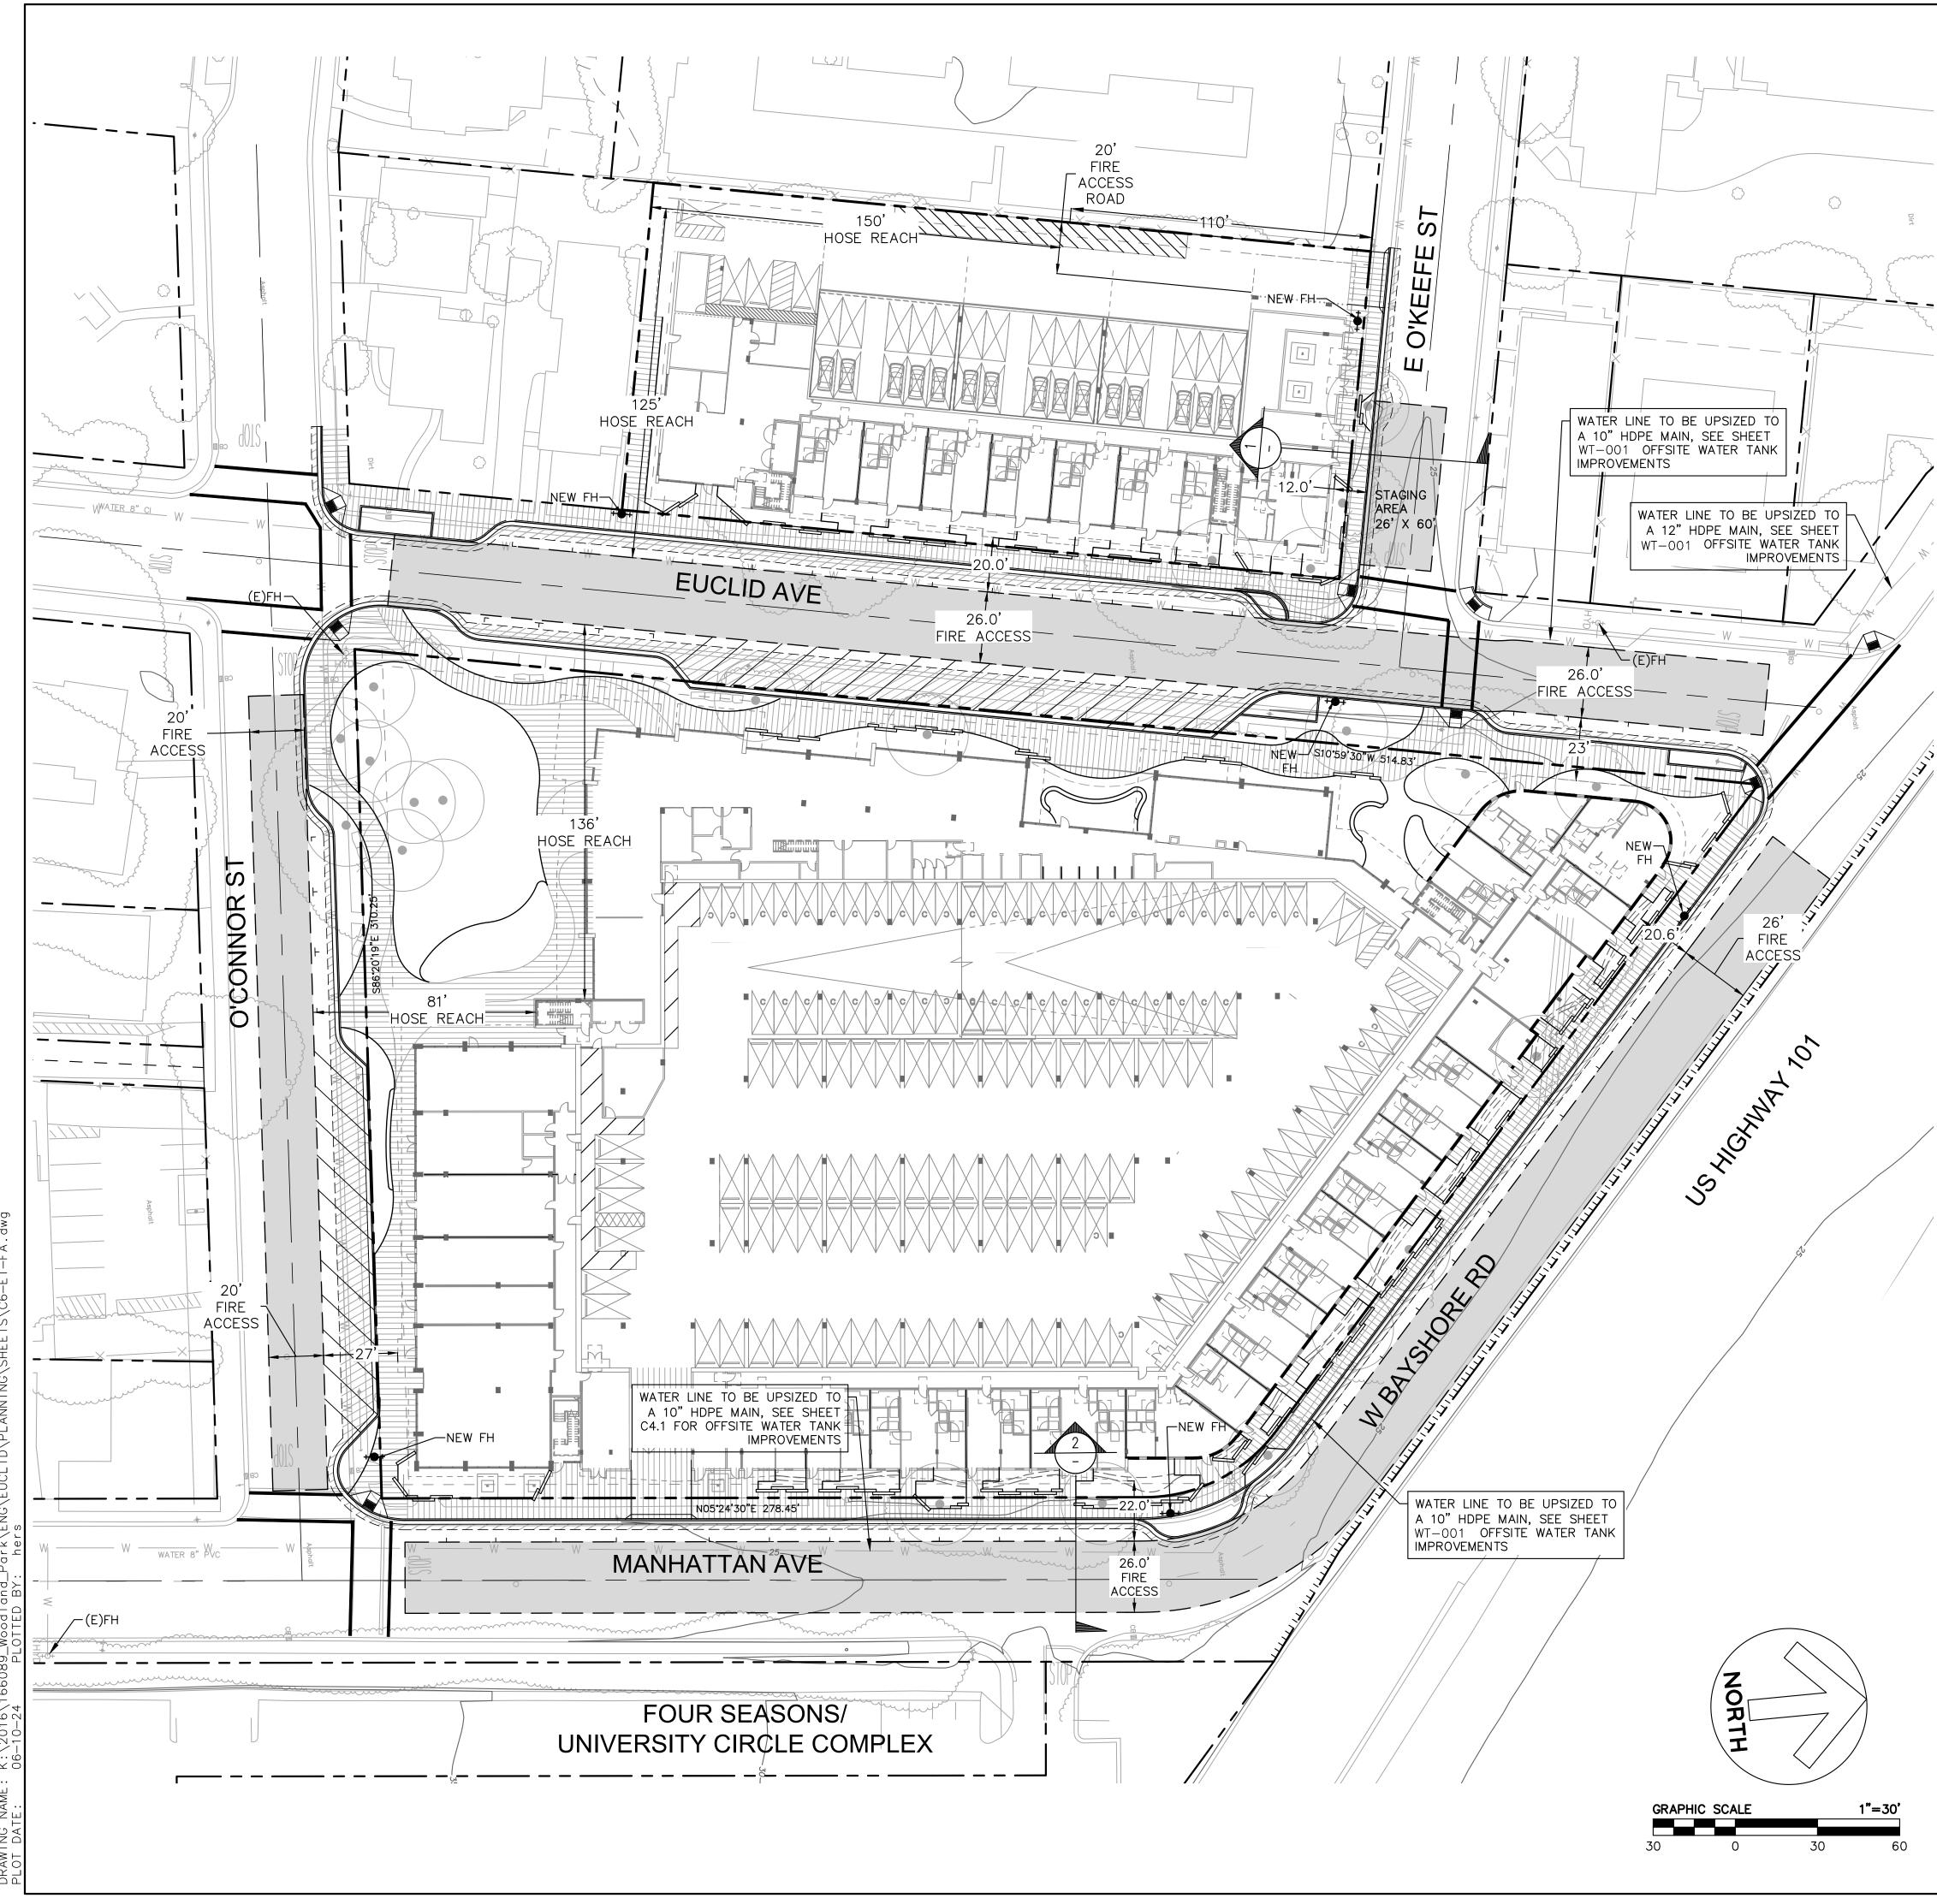

### LEGEND:

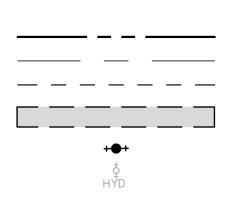

PROPERTY LINE ADJACENT PROPERTY LINE ROAD CENTERLINE — EASEMENT FIRE TRUCK STAGING AREA FIRE HYDRANT EXISTING FIRE HYDRANT


### **ABBREVIATIONS:**

-	
Е	EAST
(E)	EXISTING
ÈΗ	FIRE HYDRANT
NTS	NOT TO SCALE
W	WEST

### NOTES:


- . ON-SITE WIDTH FOR AERIAL LADDER TRUCK SHALL BE 26 FEET. THE SET UP AREAS SHALL BE A MAXIMUM OF 30 FEET FROM THE BUILDINGS AND NO CLOSER THAN 15 FEET TO THE BUILDING.
- 2. FIRE PUMP SHALL BE PROVIDED FOR ALL HIGH RISE BUILDINGS. THE PUMP SHALL BE RATED TO PUMP 150% OF THE REQUIRED DEMAND.
- 3. ALL HIGH RISE BUILDINGS SHALL HAVE STAND BY POWER GENERATORS.
- 4. ALL PUBLIC AND ON-SITE CURBS TO BE PAINTED, LETTERED, AND SIGNED AS FIRE LANES, FIRE ACCESS, AND AERIAL LADDER TRUCK ACCESS FOR RESCUE AND FIREFIGHTING OPERATIONS.
- 5. SPACING FOR FIRE HYDRANTS IS 300 FEET. THE MINIMUM ACCEPTED MENLO PARK FIRE DISTRICT FIRE FLOW IS 2000 GPM AT 20 PSI RESIDUAL PRESSURE.
- 6. ALL PUBLIC STREETS WHERE STREET WIDTHS ARE LESS THAN 26 FEET TO HAVE NO PARKING AND RED CURBS, ALL STREETS LESS THAN 32 FEET AND MORE THAN 26 FEET MAY HAVE PARKING ON ONE SIDE AND RED CURBS ON THE OTHER, STREETS 32 FEET OR GREATER MAY HAVE PARKING ON BOTH SIDES.
- FIRE LANES/EMERGENCY VEHICLE ACCESS TO HAVE RED PAINTED CURBS, CURB LETTERING AND POSTED SIGNS AS REQUIRED BY THE CVC, CFC AND MPFPD.
- 8. ALL TURNING RADII TO BE CAPABLE OF A SINGLE INLINE VEHICLE OF 42 FEET IN LENGTH MAKING ALL TURNING MANEUVERS.
- 9. FIRE HYDRANTS AND FIRE APPLIANCES (FIRE DEPARTMENT CONNECTIONS AND POST INDICATOR VALVES) TO BE CLEARLY
- ACCESSIBLE AND FREE FROM OBSTRUCTION. 10. FIRE HYDRANT TO BE WET BARREL STANDARD STEAMER TYPE WITH ONE 4 <sup>1</sup>/<sub>2</sub>" AND TWO 2 <sup>1</sup>/<sub>2</sub>" OUTLETS (MPFPD CFC SEC. 507.5.1 APPENDIX C).
- 11. DISCHARGE FIRE SPRINKLER TEST WATER TO ONSITE VEGETATED AREAS, OR TO THE SANITARY SEWER SYSTEM SUBJECT TO THE LOCAL SANITARY SEWER AGENCY'S AUTHORITY AND STANDARDS.

# **EXAMPLE STAGING CROSS SECTIONS:**

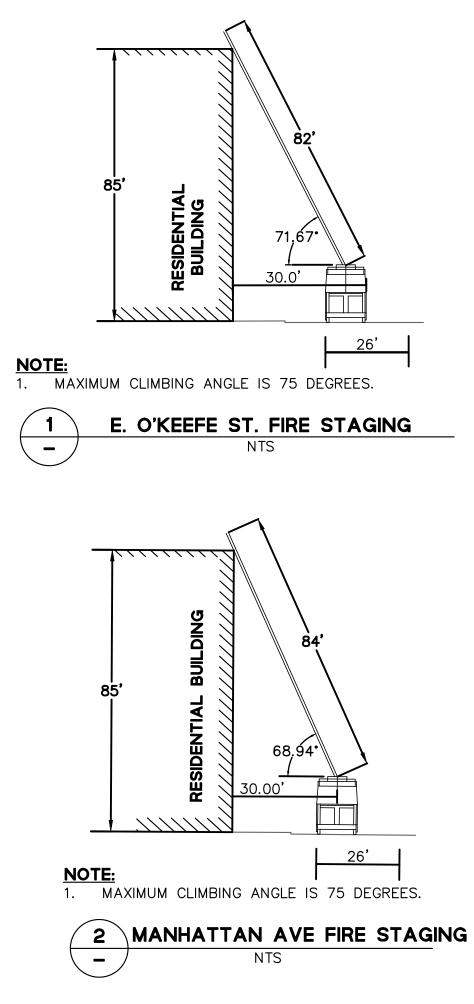

# Woodland Park

# Euclid Improvements

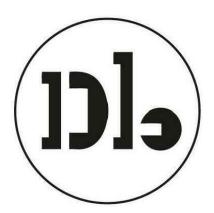

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1 2		esponse to Comments esponse to Comments	

Set Title Design Update -April 2024


Drawing Title

PRELIMINARY FIRE ACCESS PLAN

Sheet No.

C6.0

Date Project No.

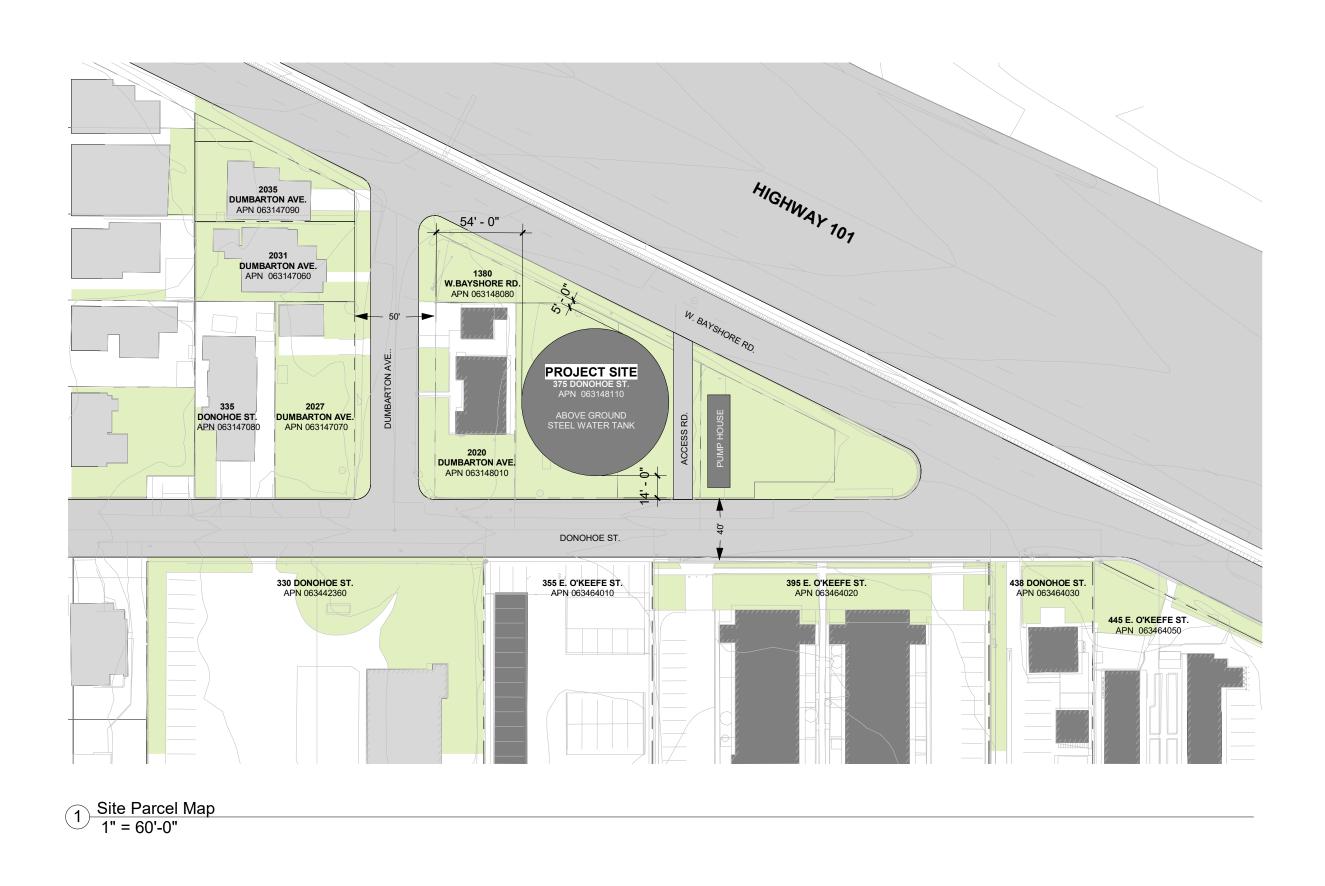

3 W.BAYSHORE ELEVATION 1/16" = 1'-0"




2 DONOHOE ST. ELEVATION 1/16" = 1'-0"





3D View - Donohoe St.

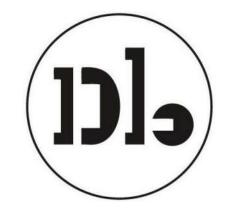

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Entitlements Submission	09/25/2019

		Revisions
Rev.	Description	Date

Set Title

- Application September 2019

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WATER TANK EXHIBIT

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08/19/2022 21620